



OAD NAME: REDWOOD HOUSE ROAD	DESIGN SECTION		
DAD NO: 5F200	MILE POST: 7,14	ENGINEERING	
OJECT NO.: FEMA-4434-DR-CA PW-2	DESIGNED BY:	JAB	
NTRACT NO.: 219303	DRAWN BY:	RMD	
AWING FILE NAME: 219303 CDSN001-00	REVIEWED BY:	JAB	


STORM DAMAGE REPAIR TO REDWOOD HOUSE ROAD

COUNTY OF HUMBOLDT DEPARTMENT OF PUBLIC WORKS

COVER SHEET, INDEX AND MAPS

COUNTY OF HUMBOLDT DEPARTMENT PUBL

PROJECT PLANS FOR CONSTRUCTION OF STORM DAMAGE REPAIRS TO **REDWOOD HOUSE ROAD PM 7.14** PROJECT NO. FEMA-4434-DR-CA PW-27 CONTRACT NO. 219303

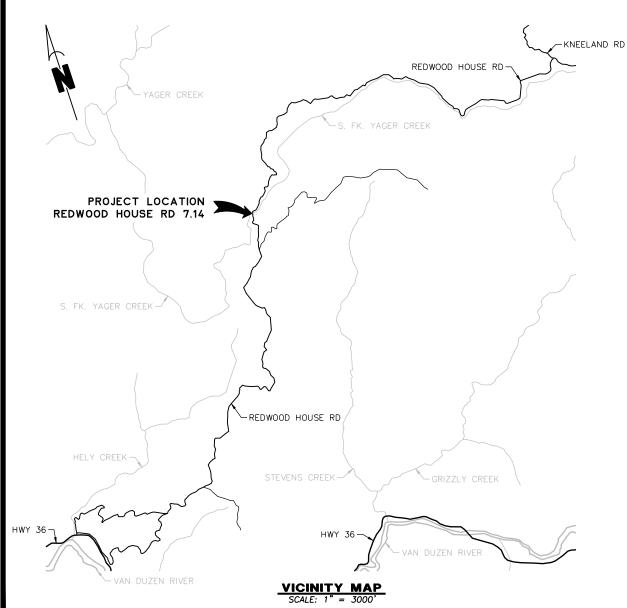



INDEX OF SHEETS

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- YAGER CREEK TEMPORARY DIVERSION PLAN
- EROSION CONTROL AND REVEGETATION PLAN
- 10. YAGER CREEK SECTION VIEWS
- 11. REDWOOD HOUSE ROAD SECTION VIEWS

NOTES


THE CONTRACTOR SHALL HAVE A CLASS "A" LICENSE FOR THIS PROJECT.

REFERENCE TO CALTRANS STANDARD PLANS DATED JULY 2018. (SEE APPLICABLE STAN PLAN LIST IN SPECIAL PROVISIONS)

GEOTECHNICAL MEMORANDUM BY CRAWFORD & ASSOCIATES, INC. FINAL

DESIGN DESIGNATION

DESIGN FLOW FOR YAGER CREEK, Q100 = 2700cfs

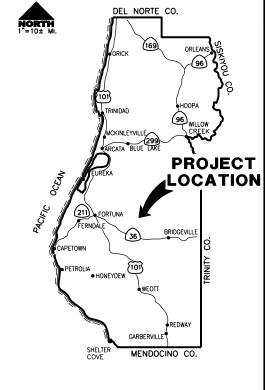

LOCATION MAP SCALE: 1"=10± MILE

RECOMMENDED

04-12-2021



APPROVED

any TONY R. SEGHETTI RCE 63714, EXP. 9/30/2022

04-12-2021

DATE






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STORM DAMAGE REPAIR TO REDWOOD HOUSE ROAD CONSTRUCTION SIGNS, STAGING &

COUNTY OF HUMBOLDT DEPARTMENT OF PUBLIC WORKS

STOCKPILE LOCATIONS AND QUANTITIES

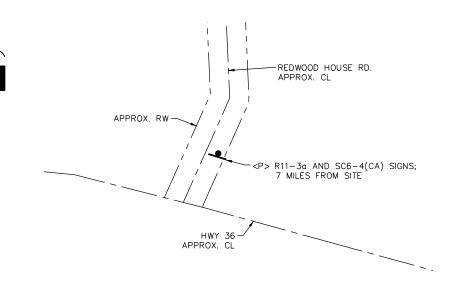


REDWOOD HOUSE RD AT HWY 36

SCALE 1"=50'

STOCKPILE NOTES

- 1) MANAGE MATERIAL STOCKPILE PER SECTION 13-4.03(C) OF CALTRANS STANDARD SPECIFICATION
- 2) IF STOCKPILE AREA IS IN A TURNOUT, THE TURNOUT SHALL BE REESTABLISHED TO PRE-CONSTRUCTION CONDITIONS.
- STOCKPILE LOCATION SHOWN HAS BEEN APPROVED BY PUBLIC WORKS AS DETAILED IN THE ENVIRONMENTAL REPORT. ALTERNATIVE SITES MAY BE APPROVED THROUGH PUBLIC WORKS

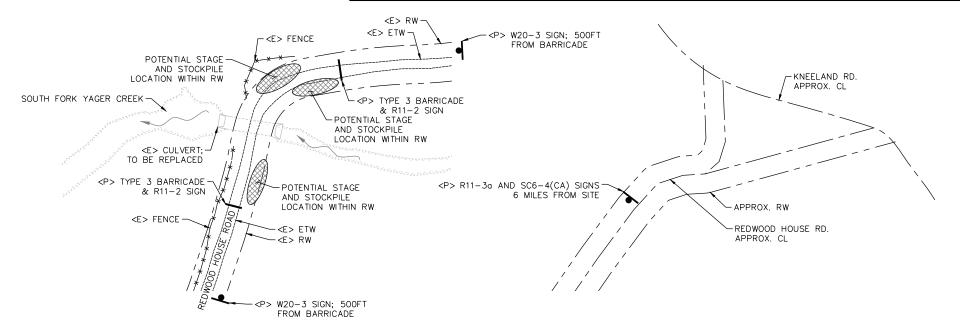

REDWOOD HOUSE RD AT S. FK. YAGER CRK

SCALE 1"=50'

SIGN CODE	QTY	SIGN MESSAGE	PANEL SIZE	NUMBER & POST SIZE
R11-2	2	ROAD CLOSED	30" × 48"	N/A
R11-3a	2	ROAD CLOSED TRAFFIC ONLY	30" × 60"	(2) 4" x 4"
SC6-4(CA)	2	ROAD CLOSED O AM - O PM	48" × 60"	(2) 4" x 4"
W20-3	2	ROAD CLOSED 500FT	36" × 36"	(1) 4" x 4"

CONSTRUCTION AREA SIGN SUMMARY

POST SIZE	
'A	
x 4"	
x 4"	
x 4"	

R11-2

ITEM ITEM

R11-3a

REDWOOD HOUSE RD AT KNEELAND RD

SCALE 1"=50'

ROAD CLOSED XX MILES AHEAD LOCAL TRAFFIC ONLY

ROAD CLOSED [MON][JAN][OO] CLOSED THRU 500 F [FRI] [JAN] [00]

W20 - 3


SC6-4(CA)

QUANTITIES

NO.	CODE		ITEM DESCRIPTION	UNIT	QUANTIT
1	120090		Construction Area Signs	EA	8
2	120100		Traffic Control System	LS	1
3	120120		Type III Barricade	EA	4
4	130100		Job Site Management	LS	1
5	130200		Prepare Water Pollution Control Program	LS	1
6	130680		Temporary Silt Fence	LF	90
7	130900		Temporary Concrete Washout	LS	1
8	131201		Temporary Creek Diversion System	LS	1
9	170103		Clearing and Grubbing	LS	1
10	192001	F	Structure Excavation	CY	1,930
11	193001	F	Structure Backfill (Arch Culvert)	CY	830
12	210212		Dry Seed	SF	1,390
13	210420		Straw	SF	1,390
14	210500		Willow Stakes	EA	40
15	210501		Alder Tree	EA	10
16	260203		Class 2 Aggregate Base	CY	82
17	510050	F	Structural Concrete (Arch Culvert Footing)	CY	111
18	520101	F	Bar Reinforcing Steel (Arch Culvert Footing)	LBS	2,560
19	675000	Р	Galvanized Steel Structure Plate Low-Profile Arch Culvert (31'8" x 12'8",	LF	75
20	710130		Remove Culvert	EA	1
21	720000		Engineered Streambed Material	CY	304
22	723050		Rock Slope Protection (1/4 Ton, Class V, Method B)	CY	172
23	723020		Rock Slope Protection (1 Ton, Class VIII, Method A)	CY	167
24	999990		Mobilization	LS	1

NOTES

- 1) SIGNS SHALL BE PLACED AS SHOWN ON PLAN OR AS DIRECTED BY THE ENGINEER.
- 2) FINAL PLACEMENT OF SIGNS SHALL BE APPROVED BY RESIDENT ENGINEER.
- 3) ADDITIONAL PORTABLE SIGNS SHALL BE USED AS REQUIRED FOR OTHER ROADSIDE WORK.
- 4) SEE STANDARD PLAN T13 FOR TRAFFIC CONTROL SYSTEM.
- IN ADDITION TO CONSTRUCTION AREA SIGNS AND WHEN DIRECTED BY THE RESIDENT ENGINEER, THE CONTRACTOR SHALL UTILIZE FLAGMEN AS NECESSARY TO DIRECT TRAFFIC.
- WHEN THROUGH TRAFFIC IS ALLOWED, KEEP A MINIMUM OF 1 TRAFFIC LANE AT LEAST 10 FEET WIDE OPEN FOR TRAFFIC, EXCEPT THE FULL WIDTH OF THE TRAVELED WAY (18' MINIMUM) MUST BE OPEN WHEN CONSTRUCTION OPERATIONS ARE NOT ACTIVE OR AN APPROVED TRAFFIC CONTROL PLAN IS IN PLACE.
- 7) INSTALL R11-30 AND SC6-4(CA) SIGNS WITH PLANNED CLOSURE DATES A MINIMUM OF 14 CALENDAR DAYS PRIOR TO IMPLEMENTING ROAD CLOSURE.

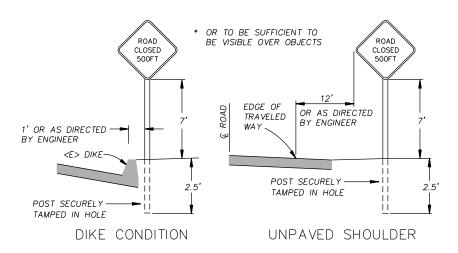

RURAL CONSTRUCTION AREA SIGN

- NOT TO SCALE -



ORIGINAL DRAWING

IF NOT ONE INCH ON
THIS SHEET, ADJUST

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CONTRACT NO.: 219303	DRAWN BY:	RMD	
DRAWING FILE NAME: 219303 CDSN001-00	REVIEWED BY:	JAB	
PLOT DATE: 04/12/2021	REVISION DATE:	APPROVED BY:	TRS

COUNTY OF HUMBOLDT DEPARTMENT OF PUBLIC WORKS

STORM DAMAGE REPAIR TO REDWOOD HOUSE ROAD

The purpose of this survey is to determine topography for a culvert failure at PM 7.14 of Redwood House Road, Humboldt County, CA. This survey reflects conditions

on the site at time of survey; field work was performed

for storm culvert shown hereon. The original size of the culvert is unknown as it is crushed into an oval shape with bottom at ends rusted out. We shot top of culvert with no size for this reason. Photos of culvert are provided in transmittal of this drawing. See Underground Utility Note hereon.

2. Underground utilities research was not performed. No evidence of underground utilities was observed except

3. Coordinates for this survey are California Coordinate System of 1983 (CCS83) Zone 1, NAD 83 (2011), Epoch 2010.0 based on a static GPS Control Survey using the NGS OPUS Post Processing Software. The control point identified as Point 50 was held for horizontal positions shown hereon. The mapping angle is 1 degree 15 minutes 09 seconds; rotate bearings hereon counterclockwise by this angle to obtain "True" or Geodetic Bearings. Grid distances shown should be divided by the Combined Scale factor of 0.99980702 to obtain ground distances. Mapping angle and grid scale factor are taken at control point number 50, a 12" spike. Elevations are NAVD 88 datum based on OPUS solution utilizing the GEOID 12B model: an elevation of 2201.13 feet was measured at the aforementioned

Only trees greater than 12 inches in diameter were located, numerous other smaller trees exist and are not shown. Trees are generally located breast high. Their locations should be considered approximate as not all

5. No boundary survey was performed as part of this project. A found 1" iron pipe, LS 3431 per Book 75 of

Surveys, page 57, was used to show the approximate location of the north line of Lands of Humboldt

Redwood Co. Ownership shown is based on Humboldt

6. Per the County of Humboldt the right of way shown on

existing centerline of the road based on data in the

this survey is fifty feet in width centered on the

SURVEY CONTROL

May 20 through 28, 2020.

Control Point 50.


trees are growing vertically.

County Assessor data.

Road Register pages 112-114.

SURVEY NOTES:



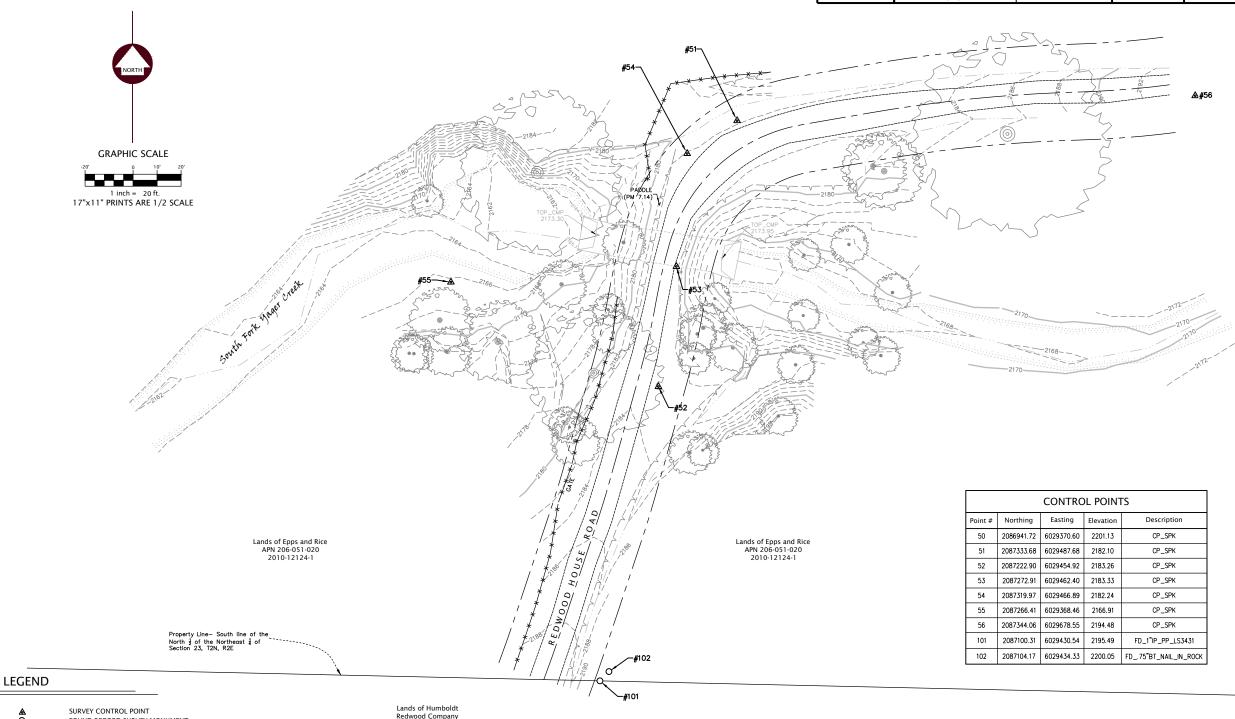

APN 206-051-016 2008-18466-122 (Unit 16

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TOPOGRAPHIC SURVEY

or

Redwood House Rd. PM 7.14 Humboldt County Project No. 219303 Task Order No. DPW2017-005-T49

SECTION 23, T2N, R2E, HUMBOLDT MERIDIAN IN THE UNINCORPORATED AREA OF, HUMBOLDT COUNTY, STATE OF CALIFORNIA Date: June 2020

SCALE: 1" = 20'

SHEET 1 OF 1

POINTS WEST SURVEYING CO.
5201 Carlson Park Dr., Suite 3 - Arcata, CA 95521
707 · 840 · 9510 · Phone 707 · 840 · 9542 · Fax

UNDERGROUND UTILITY NOTE

Underground utilities are shown based on a combination of visible physical evidence and records made available to the surveyor.

The surveyor makes no guarantees that the underground utilities shown comprise all such utilities in the area, either in service or abandoned. The surveyor further does not warrant that the underground utilities are in the exact locations indicated. The surveyor has not physically located the underground utilities.

Call Underground Service Alert (USA) 1-800-642-2444 a minimum of 48 hours prior to any excavations.

EDGE OF TRAVELED WAY (DIRT ROAD) EXISTING GROUND CONTOURS (TWO FOOT INTERVALS) TOP OF SLOPE TOE OF SLOPE / GRADE BREAK STORM DRAIN CULVERT OHT OVERHEAD TELEPHONE LINE


FOUND RECORD SURVEY MONUMENT


RIGHT OF WAY CENTERLINE

DRAINAGE FLOW LINE

TELEPHONE POLE


RIGHT OF WAY EASEMENT LINES

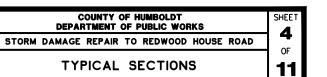

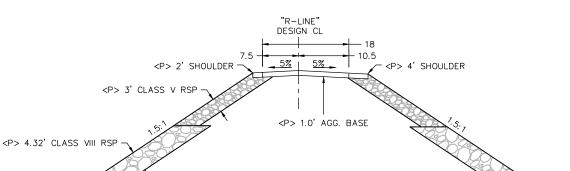

TYPICAL ROADWAY SECTION

SCALE: 1"=10'

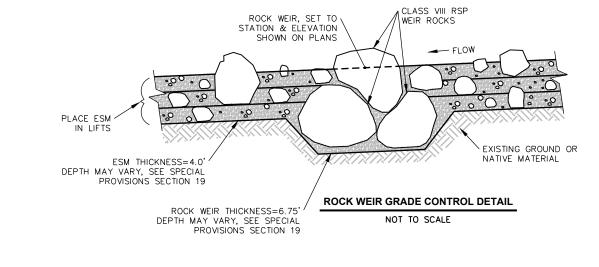

MILE POST: 7,14

DESIGN SECTION

RAWN BY: RMD

REVIEWED BY: JAB

OAD NAME: REDWOOD HOUSE ROAD


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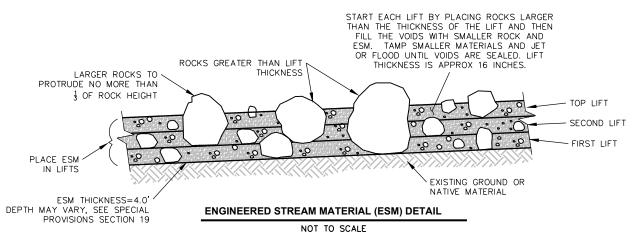
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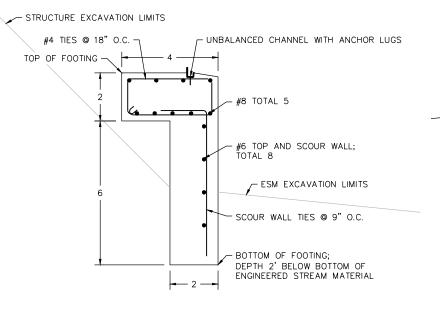
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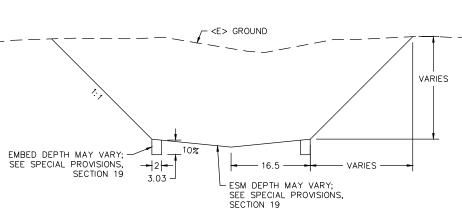
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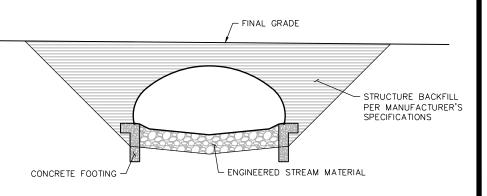
BAR IS ONE INCH ON ORIGINAL DRAWING









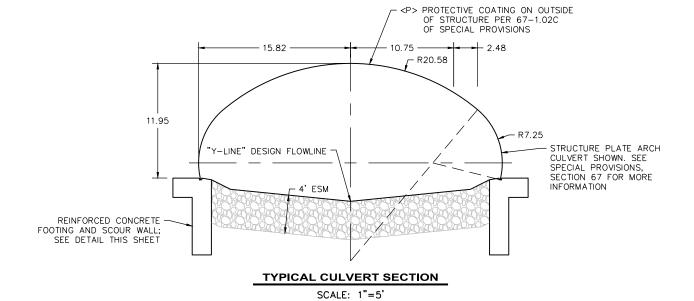

CULVERT FOOTING SECTION


TYPICAL EXCAVATION SECTION

TYPICAL BACKFILL SECTION

SCALE: 1"=10'

SCALE: 1"=2'

SCALE: 1"=10'

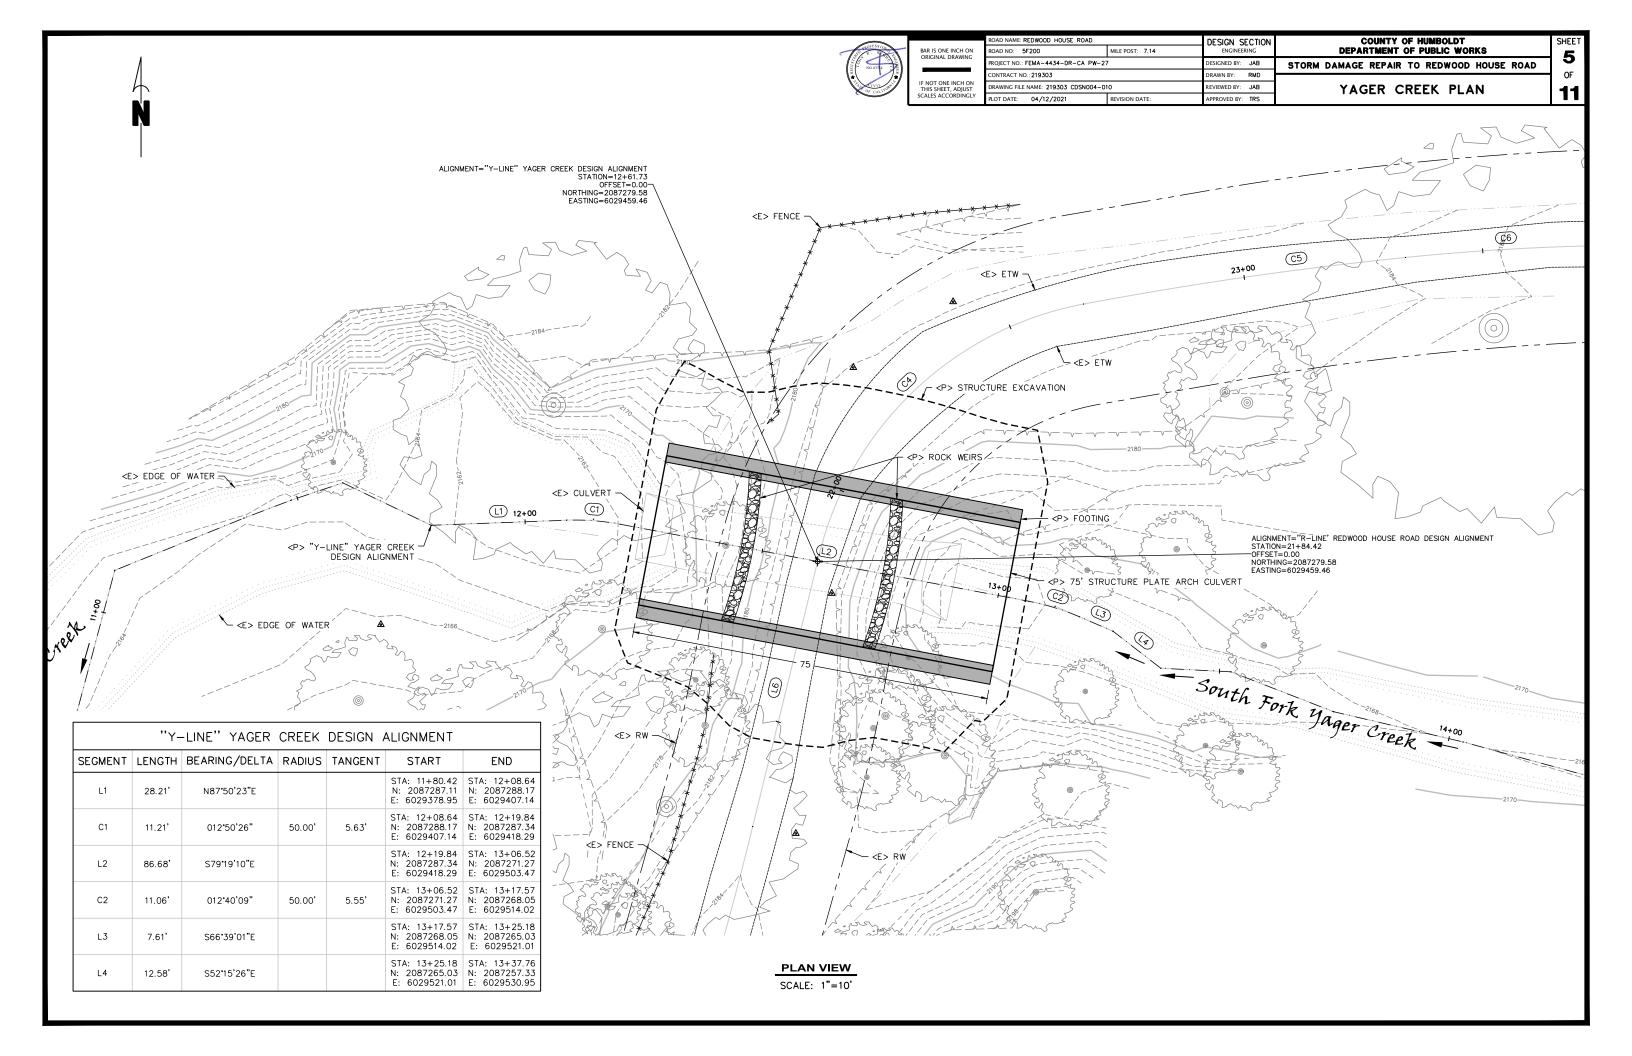



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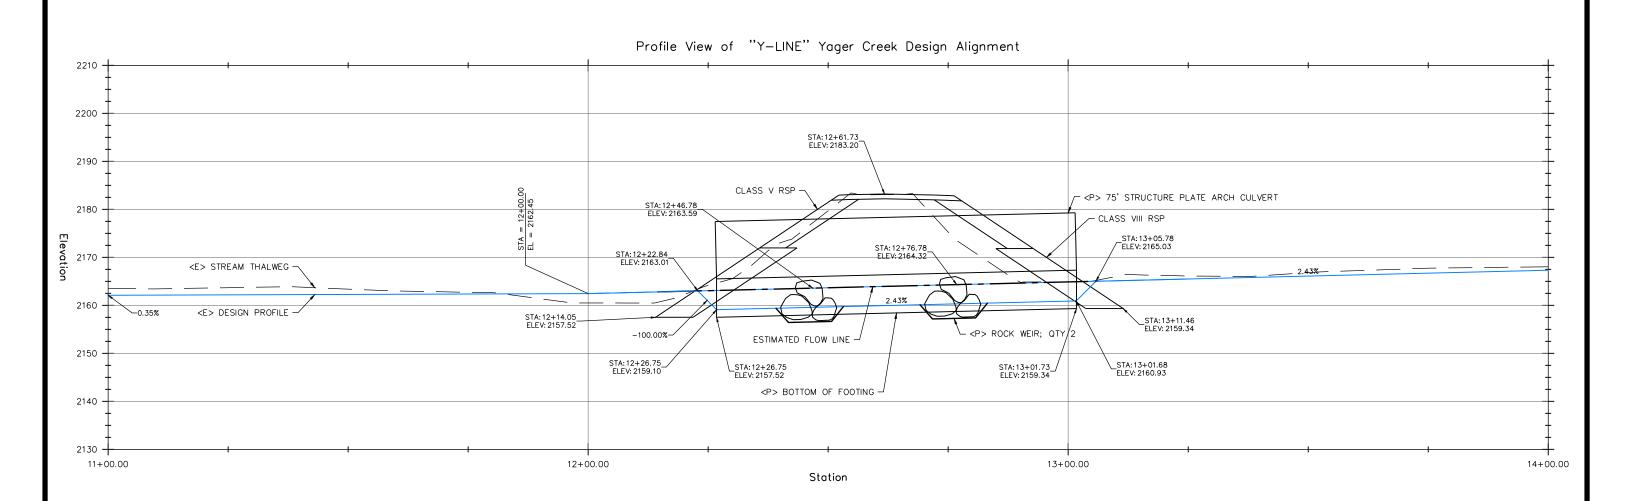
COUNTY OF HUMBOLDT DEPARTMENT OF PUBLIC WORKS

STORM DAMAGE REPAIR TO REDWOOD HOUSE ROAD 11

SHEET


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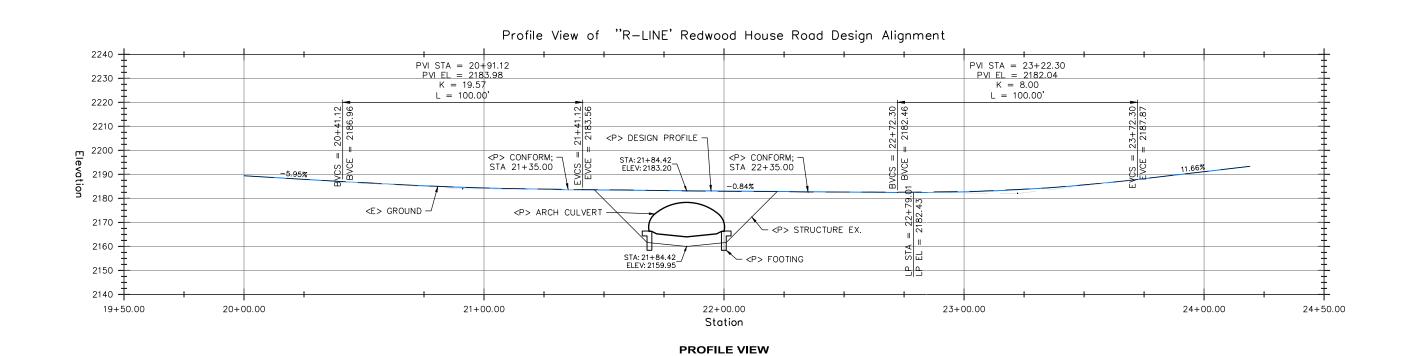
YAGER CREEK PROFILE



PROFILE VIEW

SCALE: 1"=10'




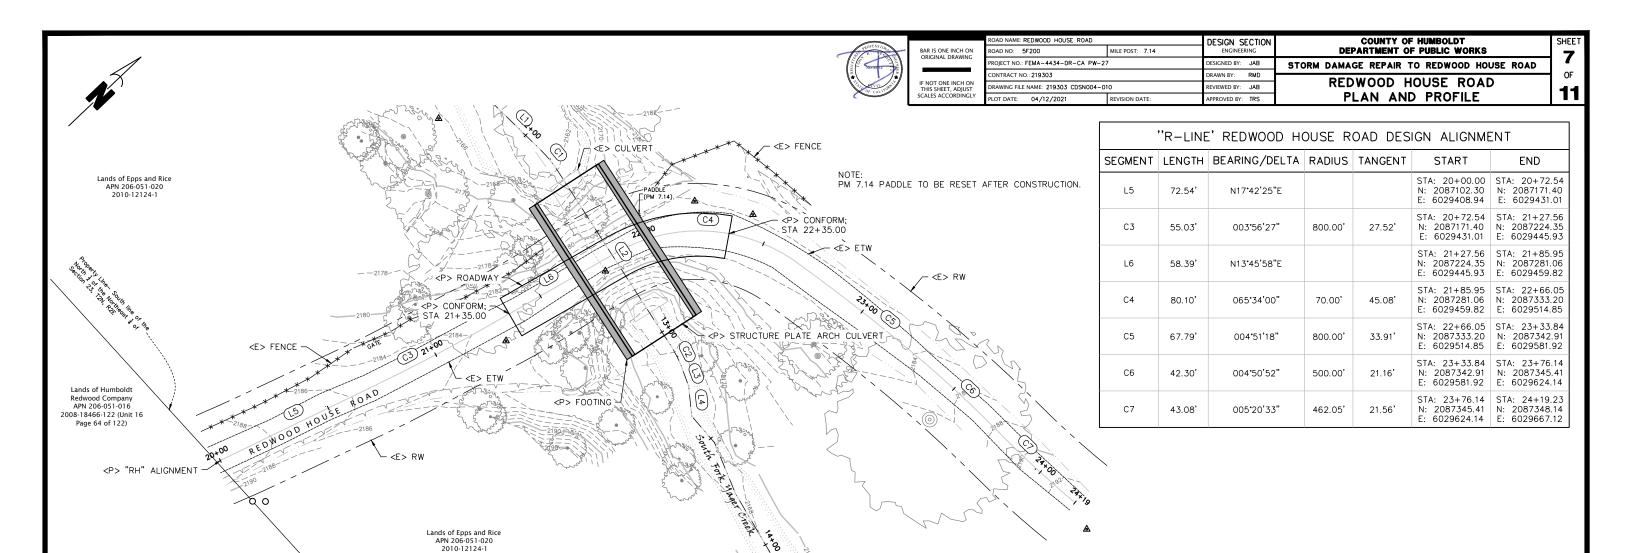


SCALE: 1"=20'

PLAN VIEW

SCALE: 1"=20'

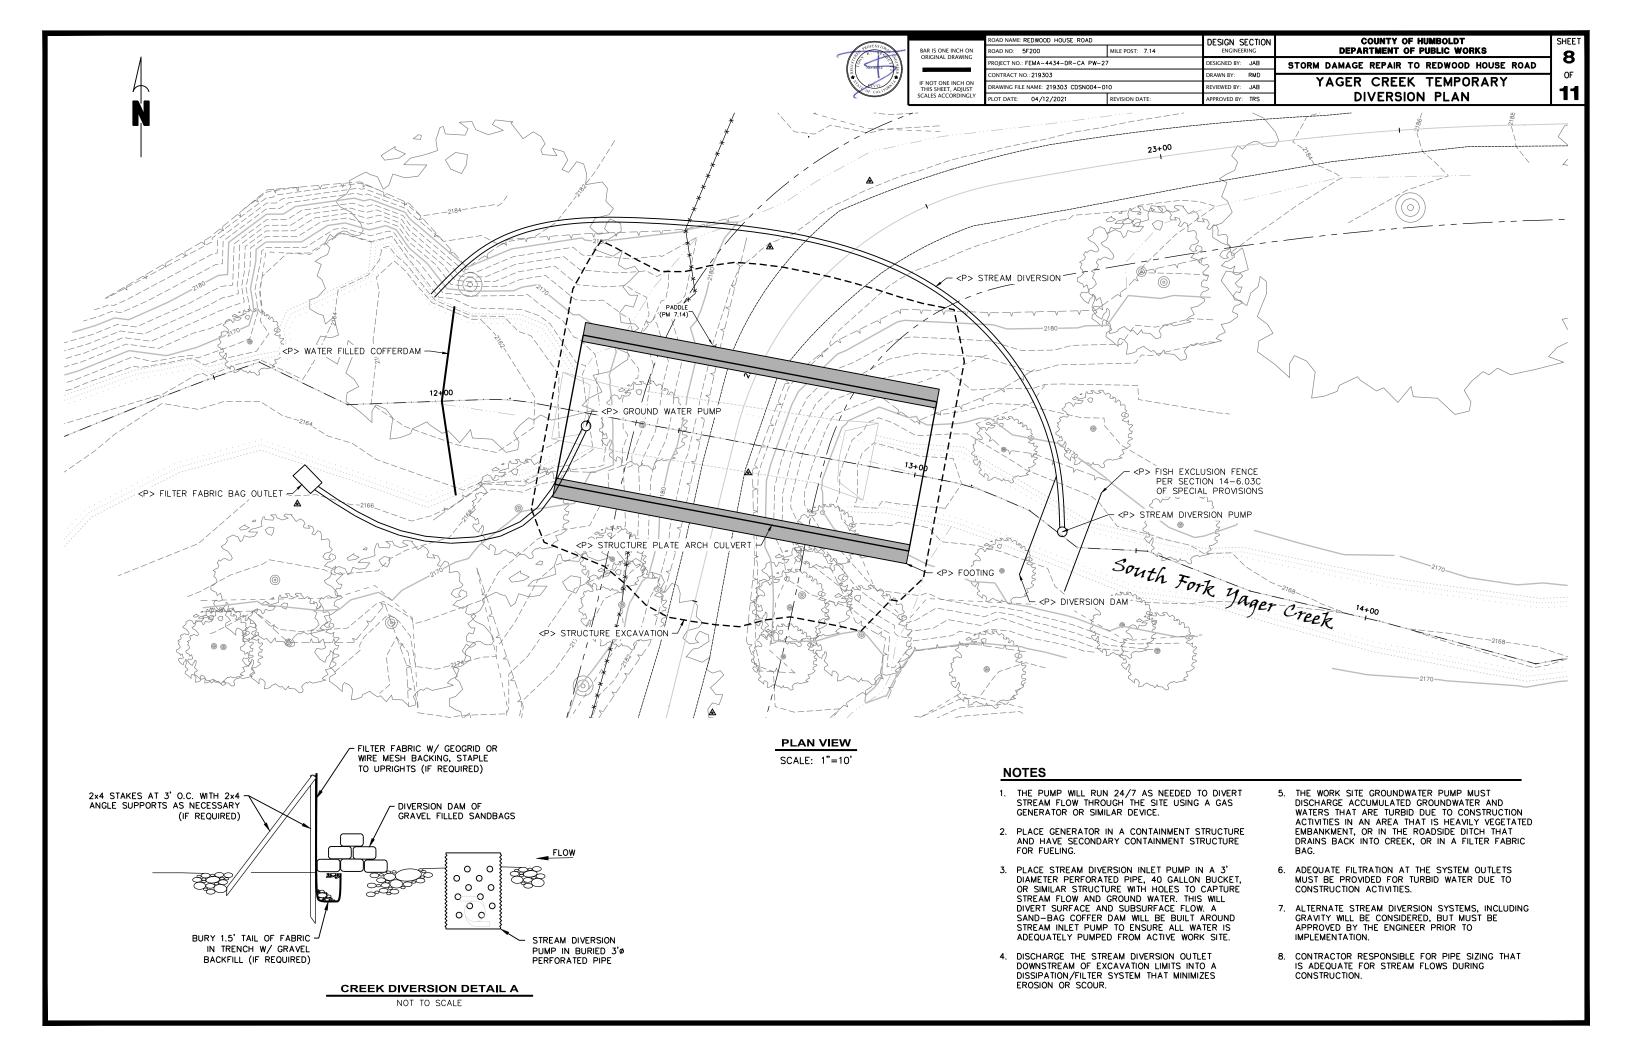

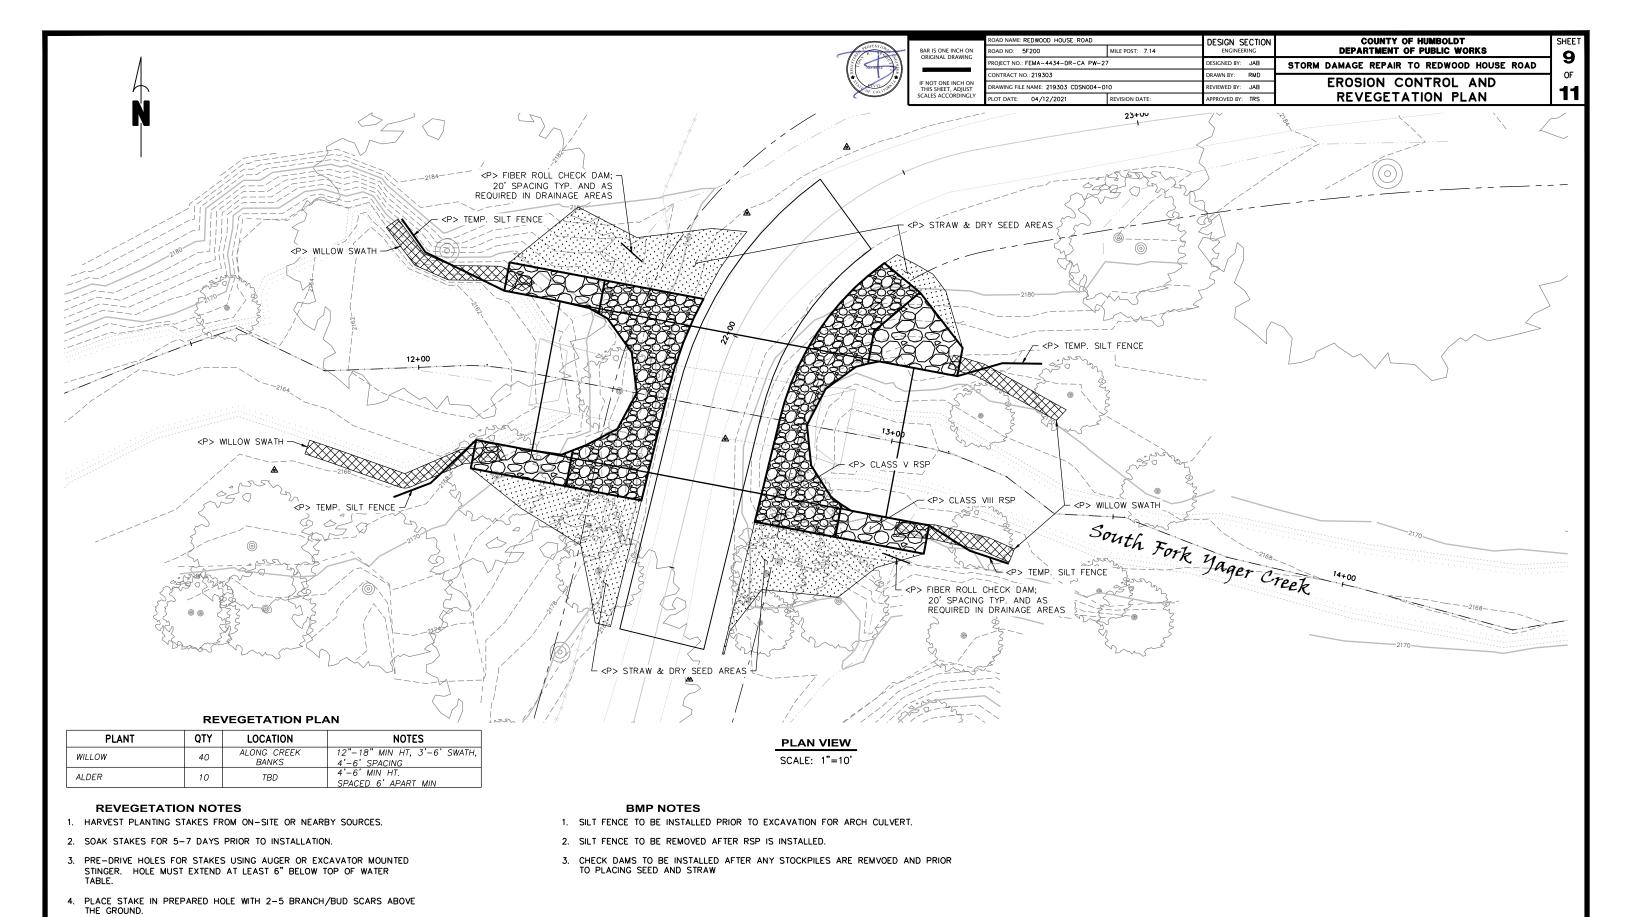

WATER PLANTING AREA THOROUGHLY AFTER INSTALLING STAKES AND ENSURE THERE ARE NO AIR POCKETS IN HOLE AROUND WILLOW STAKES.
 PLACE WILLOW STAKES 6 FT ON CENTER MAXIMUM. STAGGER WILLOW STAKE ROWS BY 5FT PARALLEL TO THE ROAD.
 REPLACE RED ALDER TREES AT 6 FT ON CENTER. TREES SHALL HAVE

A MINIMUM HEIGHT OF 4 FT. (IF NEEDED, AS REQUIRED)



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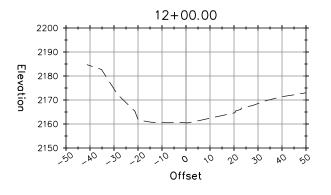
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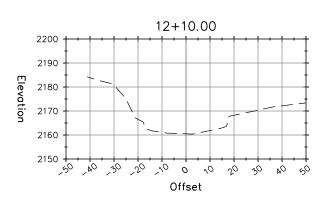
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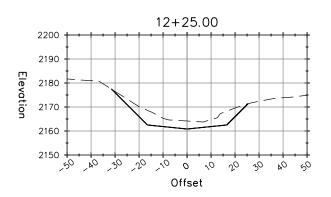
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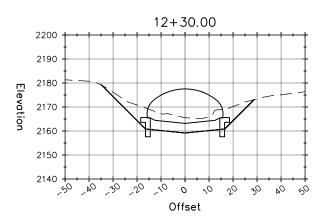
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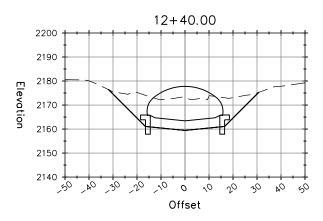
YAGER CREEK SECTION VIEWS
















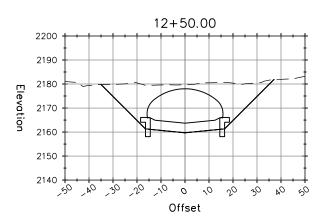


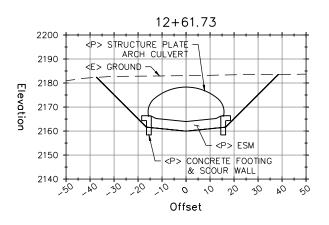


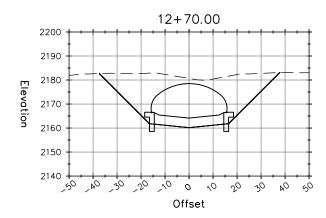

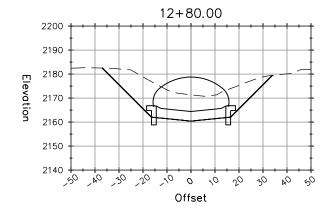

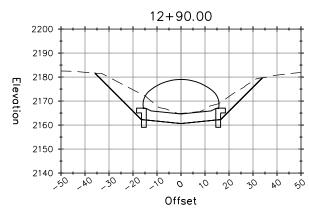

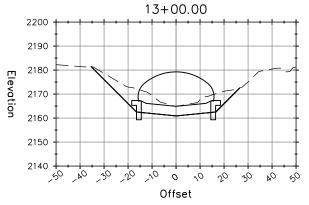

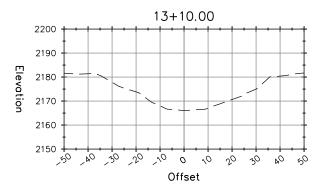

SECTION VIEWS

SCALE: 1"=20'



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REDWOOD HOUSE ROAD


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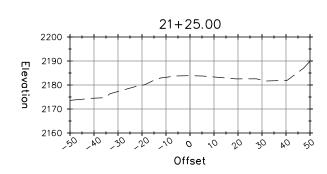
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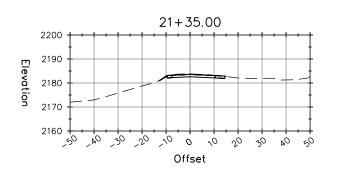
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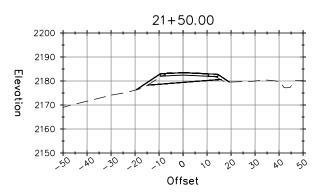
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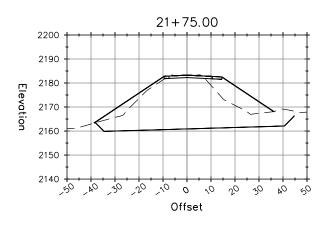
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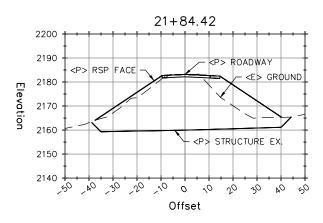














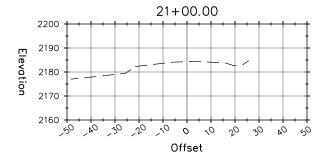


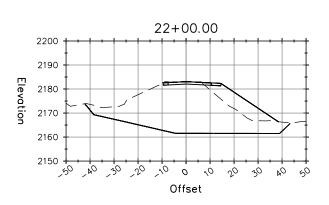


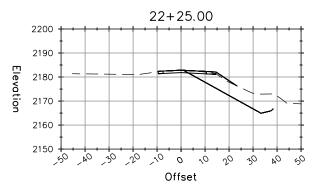

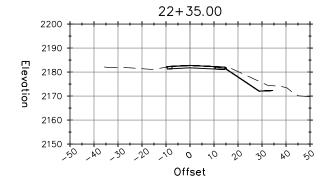

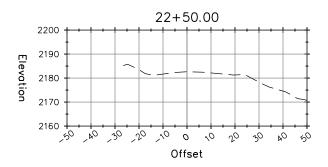

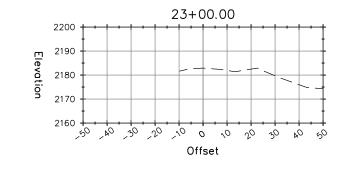

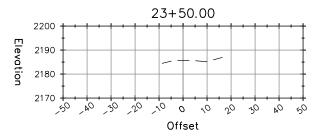

SECTION VIEWS