



23



ROAD NAME: HARRIS ROAD AND STE	DESIGN SECTION ENGINEERING		
ROAD NO: 88020 & 8C080			
PROJECT NO.: FEMA 4301-DR-CA PW-1048	CAL DES ID: 023-00000	DESIGNED BY:	MMS
CONTRACT NO.: 217382 & 217343		DRAWN BY:	MWS
DRAWING FILE NAME: L: 2017 S D\HA	REVIEWED BY:	JAB	
PLOT DATE: 4/17/2019		APPROVED BY:	TRS

TORM DAMAGE REPAIR TO HARRIS RD 1.16 & STEELHEAD RD 1.00 N BY: MMS WED BY: JAB

COVER SHEET


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COUNTY OF HUMBOLDT DEPARTMENT OF PUBLIC WORKS

COUNTY OF HUMBO

PEPARTMENT

STORM DAMAGE REPAIRS TO HARRIS RD [8B020] AT P.M. 1.16 AND STEELHEAD RD [8C080] AT P.M. 1.00 PROJECT NO. FEMA 4301-DR-CA PW-1048 **CONTRACT NO. 217382 AND 217343** 

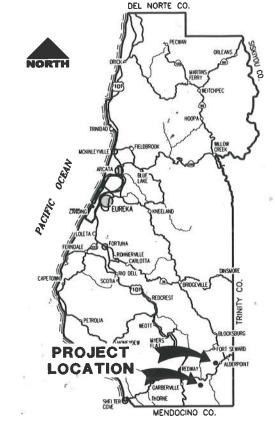

LOCATION MAP SCALE: 1"=10± MILE

# THE REDWOOD!

## INDEX OF SHEETS

- COVER SHEET
- TRAFFIC CONTROL PLAN AND QUANTITIES
- STEELHEAD ROAD PLANS AND DETAILS
- HARRIS ROAD TYPICAL SECTIONS & DETAILS
- HARRIS ROAD PLAN & PROFILE
- HARRIS ROAD CROSS SECTIONS

# RECOMMENDED



**APPROVED** 



## NOTES

THE CONTRACTOR SHALL HAVE A CLASS "A" OR "C33" LICENSE

REFERENCE TO CALTRANS STANDARD PLANS DATED OCTOBER 2018 (SEE APPLICABLE STANDARD PLAN LIST IN SPECIAL PROVISIONS)

## **DESIGN DESIGNATION**

HARRIS ADT = 37V=25MPH (NOT POSTED) STEELHEAD ADT = ~40 V=25MPH (NOT POSTED)

STEELHEAD ROAD **PROJECT** LOCATION

STEELHEAD VICINITY MAP

HARRIS VICINITY MAP

ALDERPOINT


**PROJECT** 

LOCATION

29

HARRIS

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# ENTER SUPER SUPER
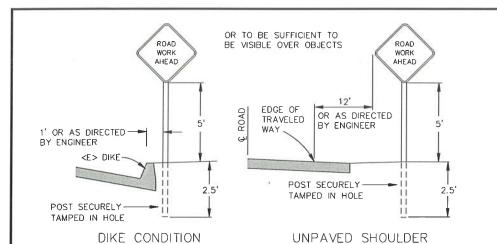
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 OAD NAME:
 HARRIS ROAD AND STEELHEAD ROAD
 DE SIGN SECTION

 OAD NO:
 88020 860080
 MILE POST:
 1,16 & 1,00
 ENGINEERING DIVISION

 ROPECT NO:: FEMA 4301 DR CAPPH 1048
 CAL OES ID.023.00000
 DESIGNED BY:
 MMS

 ONTRACT NO:
 217382 & 217343
 DRAWN BY:
 MMS

 RAWING FILE NAME:
 L.\2017 Storm Damage\\tarris Road PM 1,16\Design\217382.C2
 REVIEWED BY:
 JAB

 LOT DATE:
 4/17/2019
 APPROVED BY:
 TRS

STORM DAMAGE REPAIR TO HARRIS RD 1.16 & STEELHEAD RD 1.00

COUNTY OF HUMBOLDT

DEPARTMENT OF PUBLIC WORKS

SHEET

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TRAFFIC CONTROL PLANS AND QUANTITIES

## QUANTITIES


NO. CODE		ITEM DESCRIPTION		UNIT	HARRIS QUANTITY	STEELHEAD QUANTITY	TOTAL
1	120090		Construction Area Signs	EA	10	6	16
2	120100		Traffic Control System	LS	0.5	0.5	1
3	129000		Temporary Railing (Type K)	EA	0	7	7
4	130100		Job Site Management	LS	0.5	0.5	1
5	130200		Prepare Water Pollution Contol Program	LS	0.5	0.5	1
6	130680		Temporary Silt Fence	LF	300	100	400
7	170103		Clearing and Grubbing (LS)	LS	0.5	0.5	1
8	190101		Roadway Excavation	CY	85		85
9	192037	F	Structure Excavation (Wire Wall & Gabion)	CY	960	150	1,110
10	198050		Embankment	CY	255	95	350
11	198100		Structure Backfill (Wire Wall)	CY	420		420
12	210350		Fiber Rolls	LF	300	100	400
13	210430		Hydroseed	SQFT	4,000	1,000	5,000
14	260400		Aggregate Base (1.5" Minus Crushed Rock)	CY	85	40	125
15	477020		Mechanically Stabilized Embankment (Wire Wall)	SQFT	1,696		1,696
16	680902		6" Perforated Plastic Pipe Underdrain	LF	240		240
17	682049		Class 3 Permeable Material	CY	370		370
18	722020		Gabion (6'x6'x3')	CY		110	110
19	729011		Filter Fabric (Class 8)	SY	- 1	100	100
20	820108		Delineator (Class 2)	EA	5	5	10
21	999990		Mobilization	LS	0.5	0,5	1

## NOTES

- 1) SIGNS SHALL BE PLACED AS SHOWN ON PLAN OR AS DIRECTED BY THE ENGINEER.
- 2) FINAL PLACEMENT OF SIGNS SHALL BE APPROVED BY RESIDENT ENGINEER.
- 3) ADDITIONAL PORTABLE SIGNS SHALL BE USED AS REQUIRED FOR OTHER ROADSIDE WORK,
- 4) SEE STANDARD PLAN T13 FOR TRAFFIC CONTROL SYSTEM.
- 5) IN ADDITION TO CONSTRUCTION AREA SIGNS AND WHEN DIRECTED BY THE RESIDENT ENGINEER, THE CONTRACTOR SHALL UTILIZE FLAGMEN AS NECESSARY TO DIRECT TRAFFIC.
- 6) DISTANCE TO W20-1 AND G20-2 MAY BE EXTENDED TO ENCOMPASS SITES WITHIN ONE MILE OF EACH OTHER.
- \* PLACEMENT MAY NEED ADJUSTMENT AFTER K-RAIL IS SET.

# RURAL CONSTRUCTION AREA SIGN

- NOT TO SCALE -

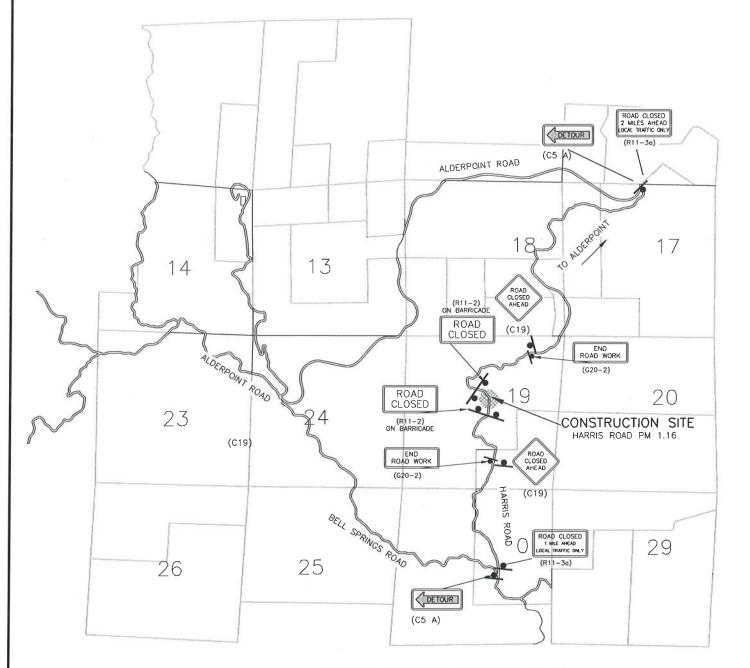


# HARRIS TRAFFIC CONTROL PLAN

1"=2000'±

# CONSTRUCTION AREA SIGN SUMMARY SIGN TYPE QTY DESCRIPTION SIZE REMARKS POST SIZE NUMBER SIZE NUMBER

		22001111 11011	0.20	THE MITTER OF	SIZE	
C5-A	2	DETOUR	48" × 18"	VISIBLE AT ALL TIMES	4" x 4"	1
R11-2	2	ROAD CLOSED	48" × 48"	VISIBLE AT ALL TIMES	4" x 4"	1
R11-3a	1	ROAD CLOSED 1 MILE AHEAD	60" × 30"	VISIBLE AT ALL TIMES	4" x 4"	2
G20-2	4	END ROAD WORK	36" x 18"	VISIBLE AT ALL TIMES	4" x 4"	1
C19	2	ROAD CLOSED AHEAD	48" × 48"	VISIBLE AT ALL TIMES	4" x 4"	1
R11-3a	1	ROAD CLOSED 2 MILES AHEAD	60" × 30"	VISIBLE AT ALL TIMES	4" × 4"	2
W20-1	2	ROAD WORK AHEAD	36" × 36"	VISIBLE AT ALL TIMES	4" x 4"	1
R-1	2	STOP	36" x 36"	VISIBLE AT ALL TIMES	4" x 4"	1

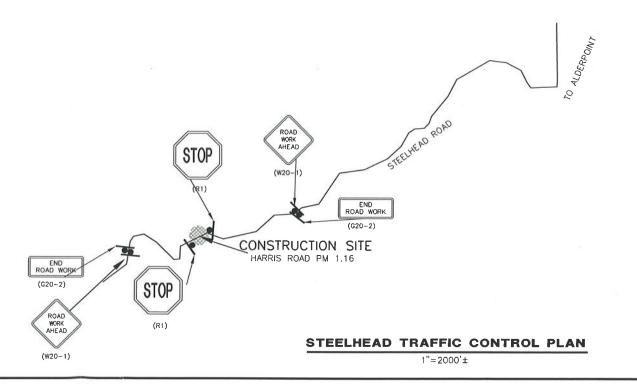




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RUAD NAME: HARRIS ROAD AND STEELH	EAD ROAD	DESIGN SECTION ENGINEERING DIVISION		COUNTY OF HUMBOLDT
ROAD NO: 88020 &8C080	MILE POST: 1.16 & 1.00			
PROJECT NO.: FEMA 4301-DR-CA-PW-1048	CAL OES ID:023-00000	DESIGNED BY:	MMS	STORM DAMAGE REPAIR TO HARRIS RD 1.16 & STEELHEAD RD 1.00
CONTRACT NO.: 217382 & 217343		DRAWN BY:	MMS	
DRAWING FILE NAME: L:\2017 Storm Dama	ge\Harris Road PM 1.16\Design\217382_C2	REVIEWED BY:	JAB	STEELHEAD ROAD
PLOT DATE: 4/17/2019		APPROVED BY:	TRS	SITE PLANS, QUANTITIES, AND DETAILS

3 OF 8

SHEET

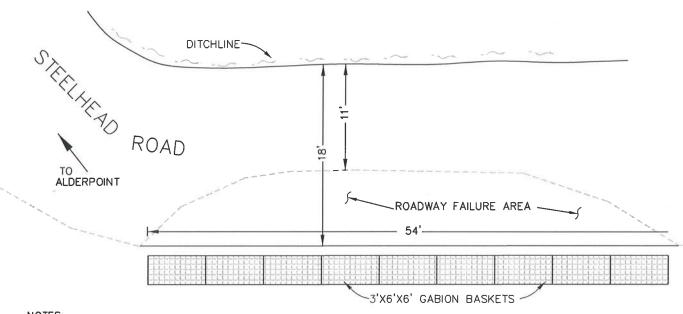


NOTES:

1. LOCATION OF GABIONS TO BE VERIFIED PRIOR TO CONSTRUCTION


2. NOT A PRODUCT OF SURVEY

**PLAN** 

Scole: 1"=10'±

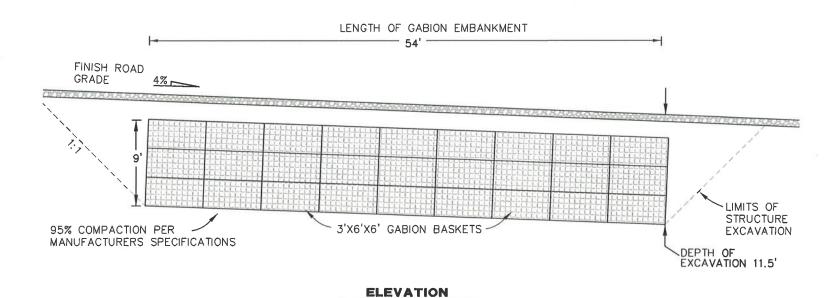


Scale: 1"=10'±

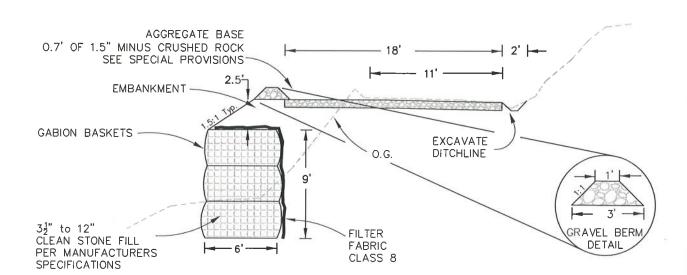

# TYPICAL SECTION

Scale: 1"=4'±

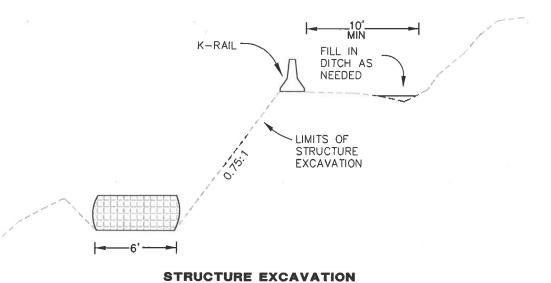

Scale: 1"=4'±



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ROAD NAME: HARRIS ROAD AND STEELH	EAD ROAD	DESIGN S	ECTION	COUNTY OF HUMBOLDT	
ROAD NO: 88020 &8C080	MILE POST: 1,16 & 1,00	ENGINEERING DIVISION		DEPARTMENT OF PUBLIC WORKS	
PROJECT NO.: FEMA 4301-DR CA-PW-1048	CAL DES ID:023-00000	DESIGNED BY:	MMS	STORM DAMAGE REPAIR TO HARRIS RD 1,16 & STEELHEAD RD 1,00	
CONTRACT NO.: 217382 & 217343		DRAWN BY:	MMS		
DRAWING FILE NAME: L:\2017 Storm Dama	ge\Harris Road PM 1.16\Design\217382_C2	REVIEWED BY:	JAB	HARRIS ROAD	
PLOT DATE: 4/17/2019		APPROVED BY:	TRS	TYPICAL SECTIONS AND DETAILS	

SHEET 4 OF 8

### SURVEY CONTROL COORDINATES LIST


POINT NUMBER	EASTING	NORTHING	POINT ELEVATION	DESCRIPTION
1	4910.2285'	4791.9404'	5010.130'	SET80D&SHINER
2	4964.8191'	4894.3442'	5003,370'	SET80D&SHINER
3	5000.0000'	5000.00001	5000.000'	SET80D&SHINER
4	5031.7232'	5179,9114'	4989,407'	SET80D&SHINER


#### SURVEY NOTES:


- 1. The purpose of this survey is to determine topography for a storm damage road repair site at PM 1.16 of Harris Road.
- Underground utilities research was not performed. We located underground cable route posts and utility poles. The existence of other utilities is unknown.
- 3.Only trees greater than 12 inches in diameter were located. Other trees exist in surveyed area and are not shown.
- The basis of bearings shown hereon are based on holding a compass bearing of N10°E between point CP3 & CP4.
- 5.The basis of elevations shown hereon is based upon an assumed elevation of 5000.00 feet at point CP3.
- 6.The right of way in this area is prescriptive. The centerline of the present day road pavement is accepted as the centerline of the right—of—way being 40 feet wide, 20 feet each side of centerline.
- 7.Distances shown hereon are in U.S. survey feet and decimals thereof.

## PROJECT LAYOUT


DESCRIPTION	NORTHING	EASTING		
B.O.P 1+30 Conform	5007.2653	5000.2439		
BEGIN WALL -TOE AT FACE	4997.8857	4985.7292		
END WALL-TOE AT FACE	5177.8927	5034.6603		
E.O.P 3+30 Conform	5193.6628	5021.3443		

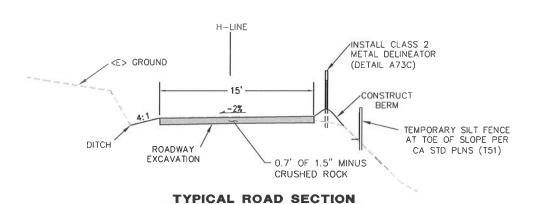

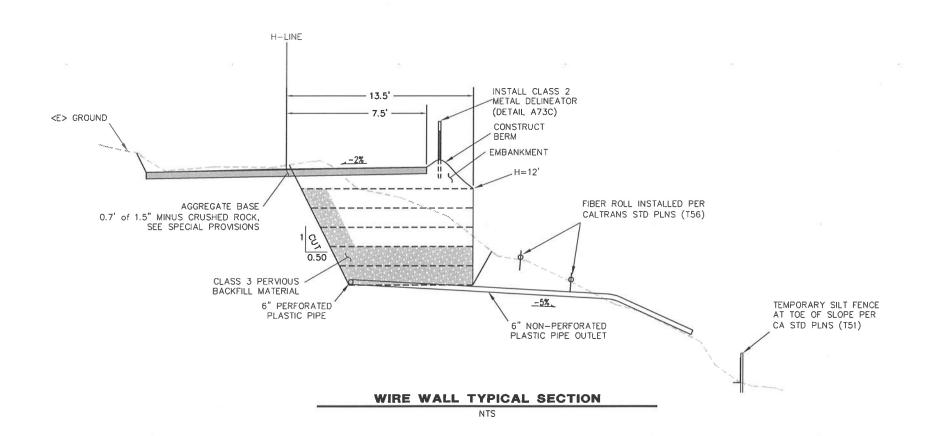

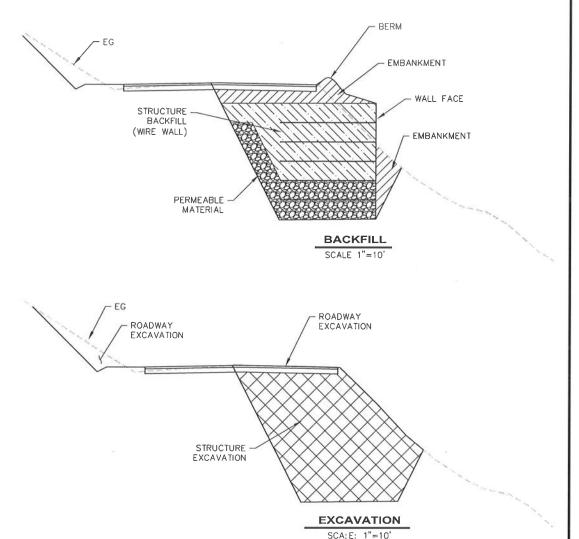


# EXCAVATION AND BACKFILL TYPICAL SECTIONS

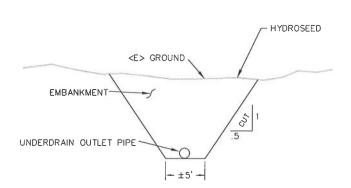

## UNDERDRAIN OUTLET TYPICAL SECTION

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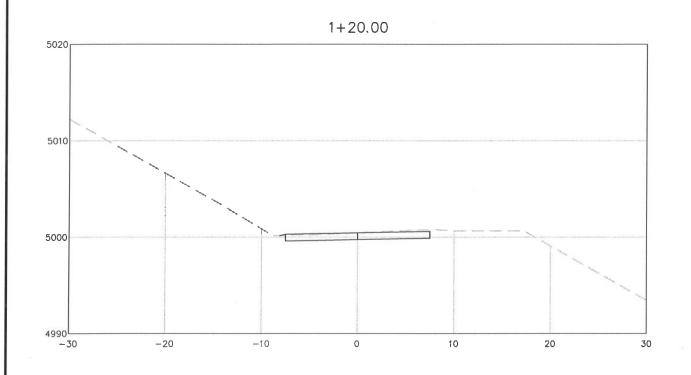
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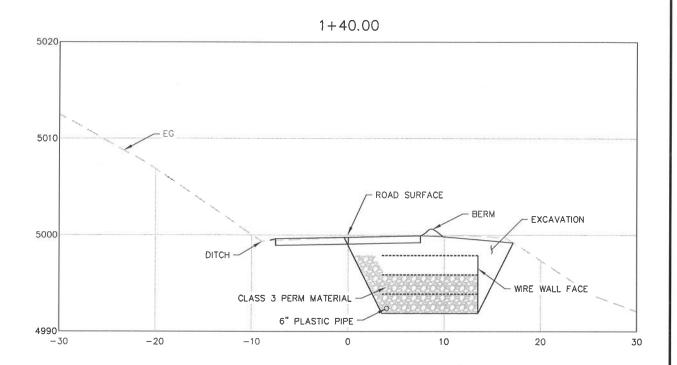
	ROAD NAME: HARRIS ROAD AND STEELH	EAD ROAD	DESIGN SECTION		COUNTY OF HUMBOL
	ROAD NO: 88020 & 8C080	MILE POST: 1.16 & 1.00	ENGINEERING		DEPARTMENT OF PUBLIC
	PROJECT NO.: FEMA 4301 DR CA-PW-1048	CAL OES ID:023-00000	DESIGNED BY:	MMS	STORM DAMAGE REPAIR TO HARRIS RD 1.16
ĺ	CONTRACT NO.: 217382 & 217343		DRAWN BY:	MMS	
	DRAWING FILE NAME: L:\2017 Storm Dama	ige\Harris Road PM 1.16\Design\217382_C2	REVIEWED BY:	JAB	HARRIS ROAD
	PLOT DATE: 4/17/2019		APPROVED BY:	TRS	SECTION VIEW (STA 1+20
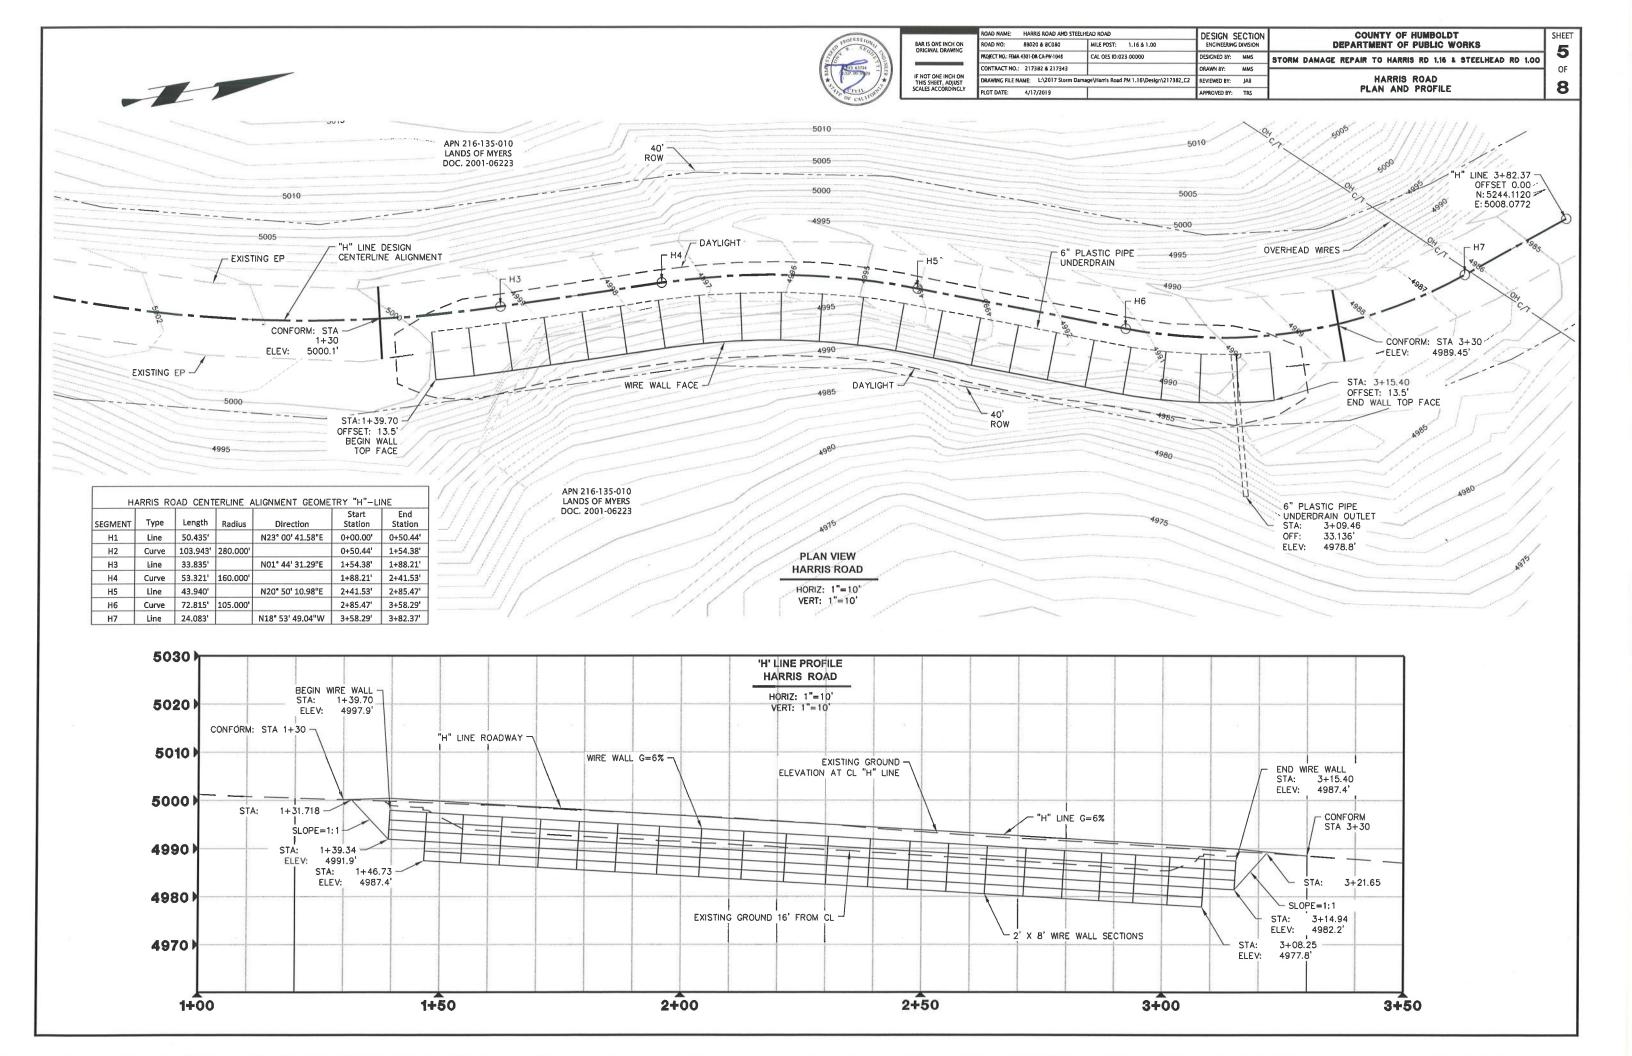
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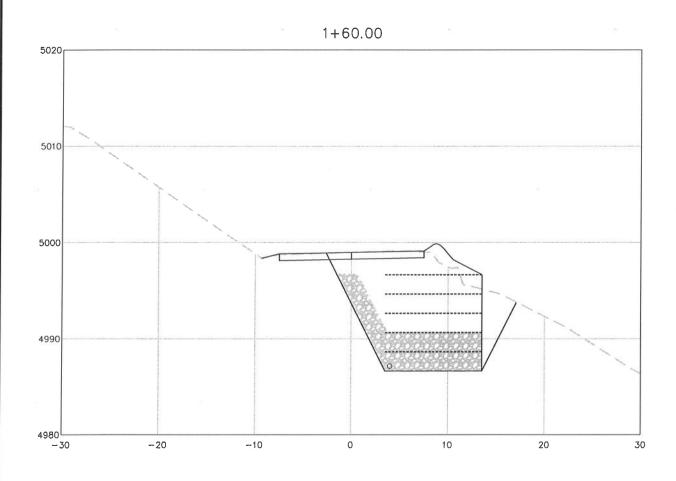
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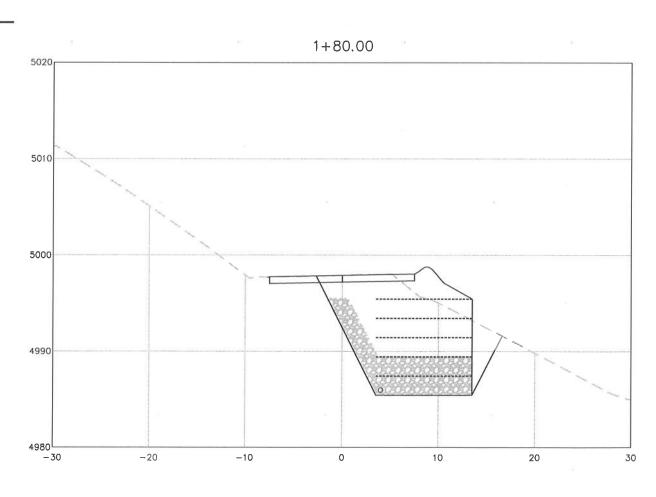




## WWW SECTION VIEW

SCALE: 1":5'








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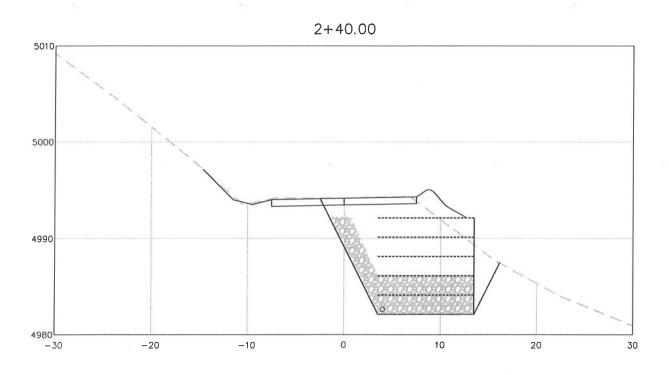
ROAD NAME:	HARRIS ROAD AND STEELH	EAD ROAD	DESIGN S	ECTION	COUNTY OF HUMBOLDT		
ROAD NO:	88020 & 8C080	MILE POST: 1,16 & 1.00	ENGINEERING DIVISION		DEPARTMENT OF PUBLIC WORKS		
PROJECT NO.: FEMA 43	301-DR-CA-PW-1048	CAL OES ID:023-00000	DESIGNED BY:	MMS	STORM DAMAGE REPAIR TO HARRIS RD 1.16 & STEELHEAD RD 1.00		
CONTRACT NO.:	217382 & 217343		DRAWN BY:	MMS	OT STATE OF THE PART OF THE MED AS THE CONTRACT OF THE MED AS THE		
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PLOT DATE:	4/17/2019		APPROVED BY:	TRS	SECTION VIEW (STA 2+00 TO 2+60)		


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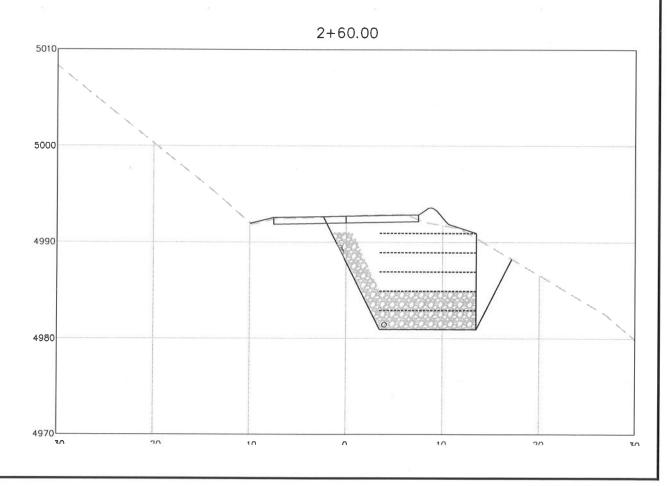
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	DESIGN SECTION ENGINEERING DIVISION			HARRIS ROAD AND STEELHEAD ROAD	DAD NAME:
			1.16 8 1.00	88020 & 8C080 MILE POST:	AD NO:
STORM DAMAGE	MMS	DESIGNED BY:	:023-00000	4 4301-DR-CA-PW-1048 CAL OES ID:0	DJECT NO.: FEMA
OTOMIN DAMAG	MMS	DRAWN BY:		: 217382 & 217343	ONTRACT NO.
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SEC	TRS	APPROVED BY:		4/17/2019	OT DATE:

COUNTY OF HUMBOLDT
DEPARTMENT OF PUBLIC WORKS

AGE REPAIR TO HARRIS RD 1.16 & STEELHEAD RD 1.00

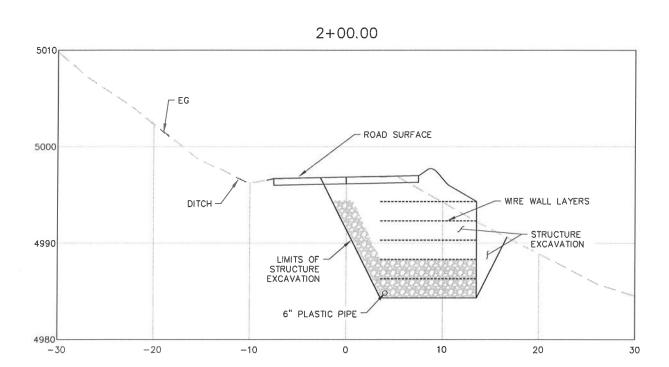HARRIS ROAD
SECTION VIEW (STA 2+80 TO 3+40)

SHEET
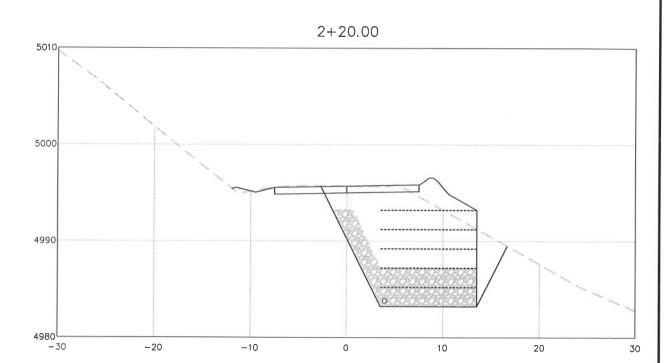
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OF

