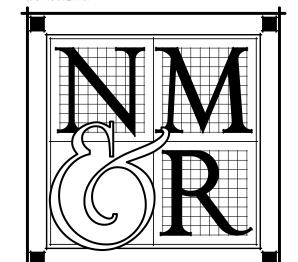


HUMBOLDT COUNTY JAIL MEDICAL SHOWER

901 5TH STREET - EUREKA, CALIFORNIA

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LICENSE STAMPS

MEDICAL SHOWER

ADA UPGRADES

FOR

HUMBOLDT

COUNTY

901 5TH STREET

EUREKA, CALIFORNIA

SHEET TITLE

COVER SHEET

DRAWING STATUS

CONSTRUCTION

DOCUMENTS

CONSULTANTS

GENERAL NOTES

GENERAL:

- 1. ALL WORK AND MATERIALS SHALL BE IN FULL ACCORDANCE WITH ALL APPLICABLE ADOPTED ORDINANCES AND CODES. ANY DISCREPANCIES BETWEEN THESE CODES AND THE CONSTRUCTION DOCUMENTS SHOULD IMMEDIATELY BE BROUGHT TO THE ATTENTION OF THE COUNTY. THE CONSTRUCTION DOCUMENTS SHALL NOT BE CONSTRUED AS TO PERMIT WORK THAT DOES COMPLY WITH THESE CODES.
- DIMENSIONS SHALL TAKE PRECEDENCE OVER ITEMS AS GRAPHICALLY DEPICTED IN THESE DRAWINGS. DO NOT SCALE DRAWINGS. DIMENSIONS NOTED AS "CLEAR" (CLR) ARE TAKEN TO THE FACE OF FINISH MATERIALS. VERIFY DIMENSIONS OF PREFABRICATED AND MANUFACTURED ITEMS AND COORDINATE ROUGH OPENINGS ACCORDINGLY.
- WHERE CONSTRUCTION DETAILS ARE NOT SHOWN OR NOTED FOR ANY PART OF THE WORK, THE DETAILS SHALL BE THE SAME AS FOR OTHER SIMILAR WORK SHOWN ON DRAWINGS, IF SIMILAR WORK IS NOT DETAILED IN DRAWINGS, WORK SHALL FOLLOW INDUSTRY STANDARDS AND
- ALL CONSTRUCTION SHALL BE IN STRICT CONFORMANCE WITH MANUFACTURER'S LATEST PUBLISHED SPECIFICATIONS AND INSTRUCTIONS. ALL DISCREPANCIES BETWEEN THESE SPECIFICATIONS AND INSTRUCTIONS AND THE CONTRACT DOCUMENTS, SHALL BE BROUGHT TO THE ATTENTION OF THE COUNTY IN WRITING PRIOR TO COMMENCING WORK.

MANUFACTURER'S RECOMMENDATIONS AS ACCEPTABLE TO THE COUNTY.


VERIFY ALL DIMENSIONS, EXISTING UTILITY LOCATIONS, AND EXISTING CONDITIONS AFFECTED BY THE CONTRACT PRIOR TO STARTING CONSTRUCTION. ANY DISCREPANCIES OR INCONSISTENCIES FOUND SHALL BE BROUGHT TO THE COUNTY'S ATTENTION BEFORE WORK PROCEEDS.

CONTRACTOR NOTICE


- ALL WORK SHALL BE IN ACCORDANCE WITH APPLICABLE ADOPTED ORDINANCES, BUILDING CODES, AND FIRE PREVENTION CODES. REFER TO THE CODE SUMMARY FOR A LIST OF KNOWN APPLICABLE CODES. DISCREPANCIES BETWEEN THESE CODES AND THE CONSTRUCTION DOCUMENTS, IF DISCOVERED, SHALL PROMPTLY BE BROUGHT TO THE ATTENTION OF THE ARCHITECT. THE CONSTRUCTION DOCUMENTS SHALL NOT BE CONSTRUED AS PERMITTING WORK THAT DOES NOT COMPLY WITH APPLICABLE CODES.
- DIMENSIONS SHALL TAKE PRECEDENCE OVER LOCATIONS OF ITEMS AS GRAPHICALLY DEPICTED IN THESE DRAWINGS. DIMENSIONS ARE TO FACE OF STUDS, CMU, OR SLAB, AND TO CENTERLINES OF STEEL MEMBERS, UNLESS NOTED OTHERWISE. DO NOT SCALE THESE DRAWINGS. DIMENSIONS NOTED AS "CLEAR" (CLR) ARE TAKEN TO THE FACE OF FINISH MATERIALS. VERIFY DIMENSIONS OF PREFABRICATED AND MANUFACTURED ITEMS AND COORDINATE ROUGH OPENINGS ACCORDINGLY.
- WHERE CONSTRUCTION DETAILS ARE NOT SHOWN OR NOTED FOR ANY PART OF THE WORK, THE DETAILS SHALL BE THE SAME AS FOR OTHER SIMILAR WORK SHOWN ON THESE DRAWINGS. IF SIMILAR WORK IS NOT DETAILED IN DRAWINGS, WORK SHALL FOLLOW INDUSTRY STANDARDS AND MANUFACTURER'S RECOMMENDATIONS AS ACCEPTABLE TO THE OWNER.
- ALL CONSTRUCTION SHALL BE IN CONFORMANCE WITH MANUFACTURER'S LATEST PUBLISHED SPECIFICATIONS AND INSTRUCTIONS. ALL DISCREPANCIES BETWEEN THESE SPECIFICATIONS AND INSTRUCTIONS AND THE CONTRACT DOCUMENTS SHALL BE BROUGHT TO THE ATTENTION OF THE ARCHITECT PRIOR TO COMMENCING AFFECTED PORTIONS OF THE
- AT WALLS INDICATED AS BEING OF FIRE-RATED CONSTRUCTION WHERE PROTECTION OF OPENINGS REQUIRED, MAINTAIN FIRE-RESISTIVE WALL CONSTRUCTION AT BUILT-IN FIXTURES AS REQUIRED BY APPLICABLE
- VERIFY ALL DIMENSIONS, EXISTING UTILITY LOCATIONS, AND EXISTING CONDITIONS AFFECTED BY THE WORK OF THIS PROJECT PRIOR TO STARTING CONSTRUCTION. ANY DISCREPANCIES OR INCONSISTENCIES FOUND SHALL BE BROUGHT TO THE ARCHITECT'S ATTENTION BEFORE WORK PROCEEDS.

SITE PLAN

4TH STREET

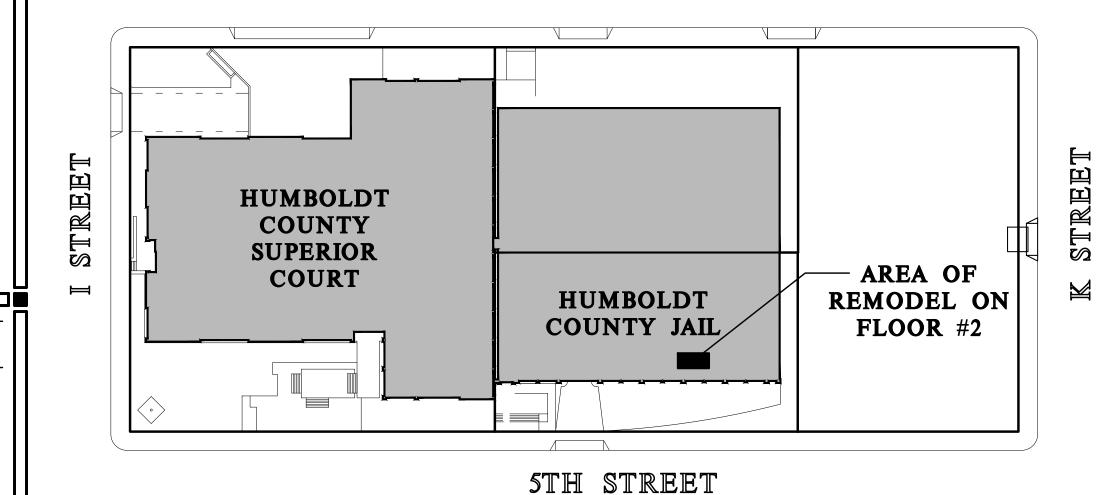



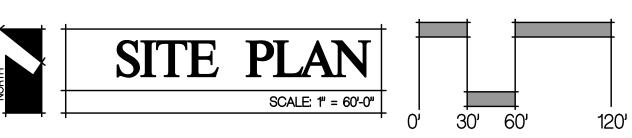

PROJECT DATA

PROJECT DESCRIPTION:

THE HUMBOLDT COUNTY JAIL MEDICAL SHOWER PROJECT WILL REMODEL APPROXIMATELY 150 SQUARE FEET ON THE SECOND FLOOR OF THE EXISTING HUMBOLDT COUNTY JAIL, LOCATED AT 901 5TH STREET, EUREKA, CALIFORNIA. THE EXISTING MEDICAL SHOWER ROOM IS REMODELED FOR A NEW SHOWER. THE ADJACENT SLEEPING ROOM IS REMODELED TO INCLUDE A BUNK AND TOILET/SINK COMBINATION UNIT. THE PROJECT INCLUDES: DEMOLITION, CONCRETE, MASONRY, DETENTION DOORS/FRAMES, FINISHES, HVAC AND

BUILDING ANALYSIS:

HUMBOLDT COUNTY JAIL WAS ORIGINALLY CONSTRUCTED IN 1995.

OCCUPANCY CLASSIFICATION / USE: BUILDING CONSTRUCTION TYPE: NUMBER OF STORIES:

4. ACTUAL BUILDING HEIGHT: 5. BUILDING AREA: AREA OF PROJECT: SEPARATED OR NON-SEP. USE:

8. ALLOWABLE AREA PER CBC: 9. AREA INCREASE: 10. HEIGHT INCREASE: 11. FIRE SPRINKLER:

12. FIRE ALARM: 13. OTHER FIRE PROTECTION: 14. SMOKE CONTROL SYSTEM: 15. ORIGINAL CONSTRUCTION DATE:

16. HIGH FIRE SEVERITY ZONE: 17. EMERGENCY RESPONDER RADIO:

WITH THE LATEST REGULATIONS OF:

WITH THE LATEST REGULATIONS OF:

YES / AUTOMATIC YES / KITCHEN

I-3 (COUNTY JAIL) / B

200 SQUARE FEET

59,808 S.F. (I-3) / 3,184 S.F. (B)

SEPARATED USE BUILDING

TYPE I-A

66'-10"

4 STORIES

UNLIMITED

CODES / STANDARDS

APPLICABLE CODES: ALL WORK PERFORMED & PRODUCTS FURNISHED SHALL COMPLY AS APPLICABLE

• TITLE 19 C.C.R., PUBLIC SAFETY, STATE FIRE MARSHAL REGULATIONS • 2016 BUILDING STANDARDS ADMINISTRATIVE CODE, PART 1, TITLE 24 C.C.R. • 2016 CALIFORNIA BUILDING CODE (CBC), PART 2, TITLE 24 C.C.R. • 2016 CALIFORNIA ELECTRICAL CODE (CEC), PART 3, TITLE 24 C.C.R. 2016 CALIFORNIA MECHANICAL CODE (CMC), PART 4, TITLE 24 C.C.R. • 2016 CALIFORNIA PLUMBING CODE (CPC), PART 5, TITLE 24 C.C.R. • 2016 CALIFORNIA ENERGY CODE, PART 6, TITLE 24 C.C.R. • 2016 CALIFORNIA FIRE CODE, PART 9, TITLE 24 C.C.R. • 2016 CALIFORNIA EXISTING BUILDING CODE, PART 10, TITLE 24 C.C.R. • 2016 CALIFORNIA GREEN BUILDING STANDARDS CODE, PART 11, TITLE 24 C.C.R.

• 2016 CALIFORNIA REFERENCED STANDARDS CODE, PART 12, TITLE 24 C.C.R. APPLICABLE STANDARDS: ALL WORK PERFORMED & PRODUCTS FURNISHED SHALL COMPLY AS APPLICABLE

• 2016 NFPA 13 AUTOMATIC SPRINKLER SYSTEMS (CALIFORNIA AMENDED) • 2013 NFPA 14 INSTALLATION OF STANDPIPE AND HOSE SYSTEMS (CALIFORNIA

• 2013 NFPA 20, PUMPS FOR FIRE PROTECTION • 2013 NFPA 24, FIRE SERVICE MAINS (CALIFORNIA AMENDED) 2013 NFPA 72 NATIONAL FIRE ALARM CODE (CALIFORNIA AMENDED)

DEFERRED SUBMITTALS

DRAWING INDEX

DWG. # DESCRIPTION


M220

GENERAL	
G001	COVER SHEET
<u>ARCHITECTUF</u>	RAL
A200	OVERALL FLOOR PLAN & ACCESS/ WORK PROTOCOLS
A210	DEMO & NEW FLOOR & REFLECTED CEILING PLANS
A901	INTERIOR ELEVATIONS & DETAILS
A902	DETAILS

VICINITY MAP

FIRST FLOOR HVAC PLAN

SECOND FLOOR HVAC PLAN

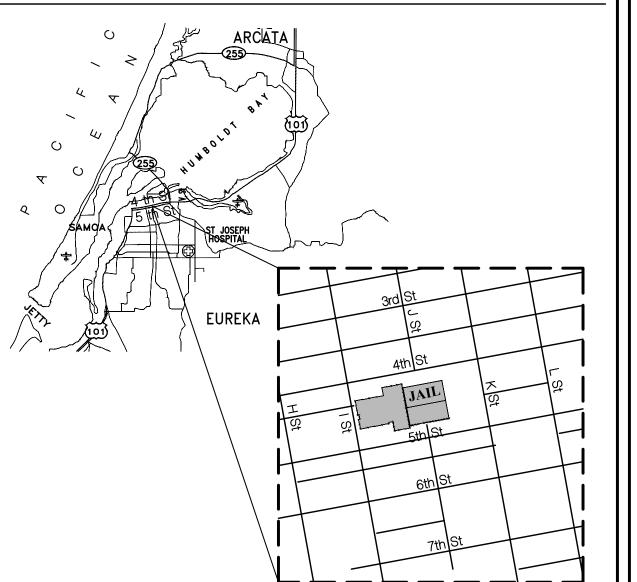

FIRE INSPECTION

SPRINKLERS & RATED WALL ASSEMBLIES


REVISIONS Sym. Description By Date

Drawn By	AMP
Checked By	DRC
Date Drawn	10-04-2018
Scale	AS NOTED
Job No.	17-6430

SHEET No.

1. FIRE ALARM MODIFICATIONS FOR FIRE SMOKE DAMPER

1. FIRE DEPARTMENT TO PERFORM INSPECTION & APPROVAL OF FIRE ALARM, FIRE

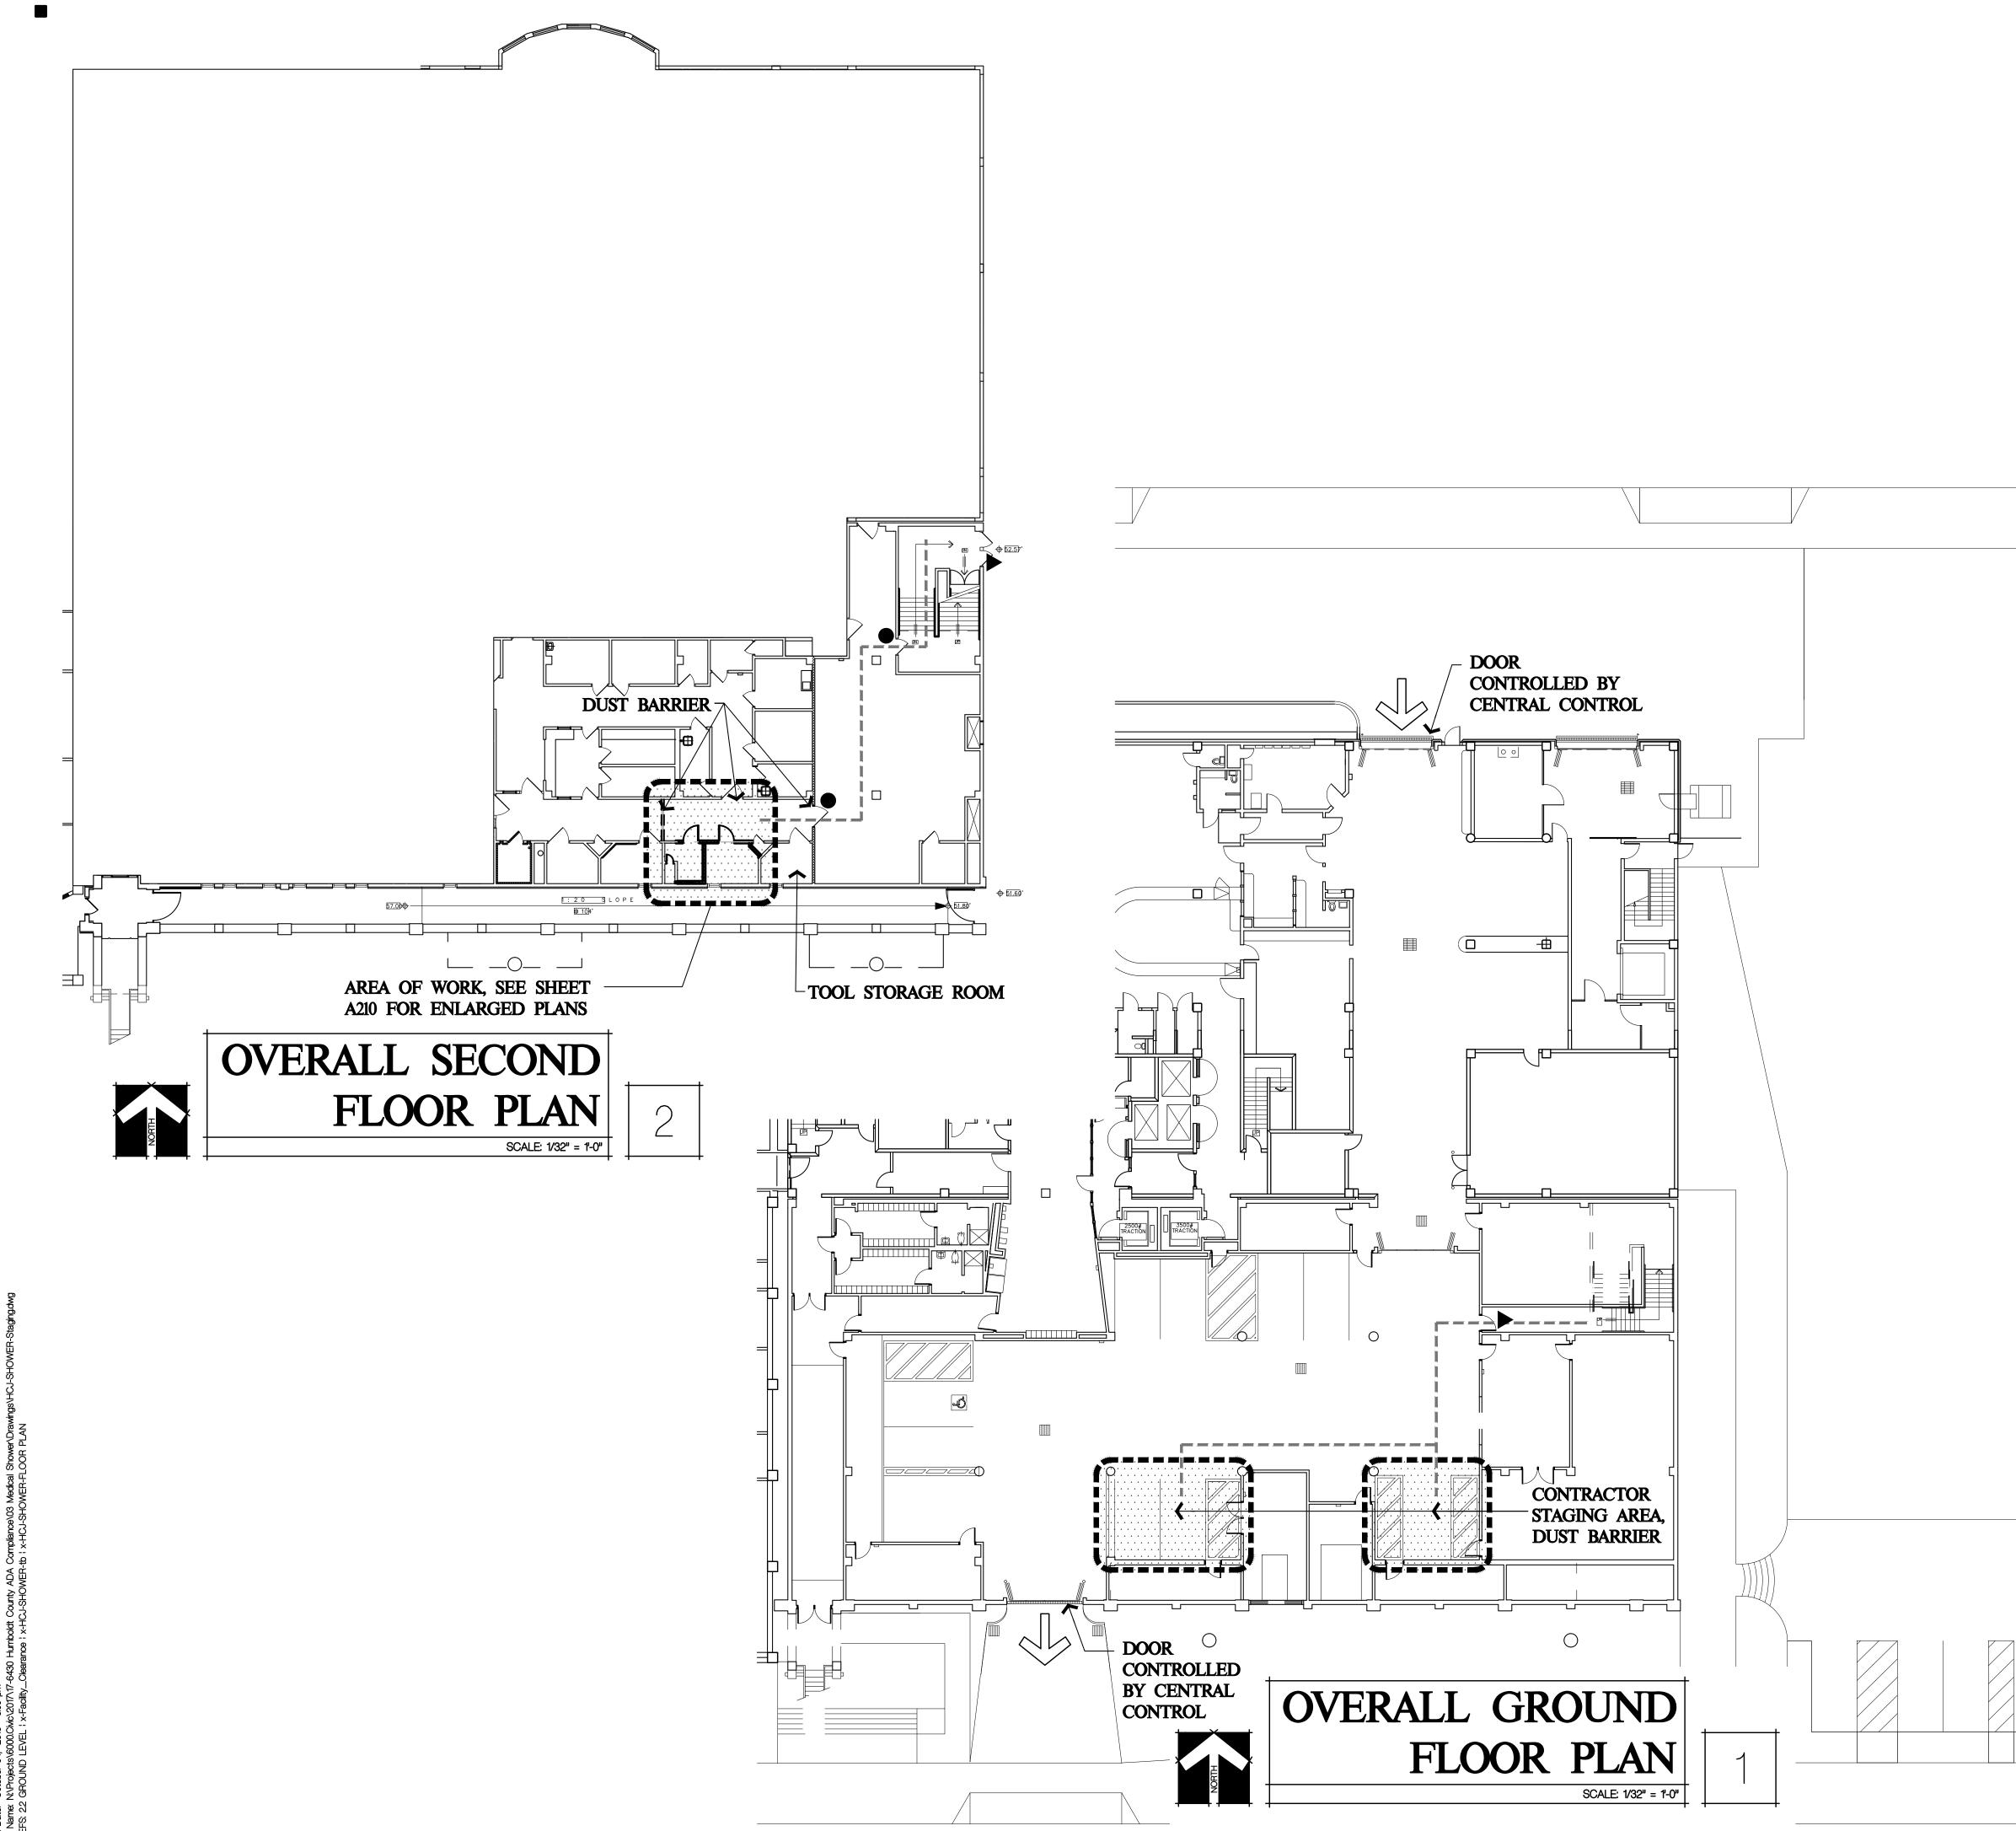

FACILITY CLEARANCE & CONTRACTOR ACCESS PROTOCOL

- 1. PRIOR TO FACILITY ACCESS, CONTRACTOR AND ALL SUB-CONTRACTORS AND EMPLOYEES WHO MAY BE WORKING INSIDE SHALL SUBMIT A "FACILITY CLEARANCE APPLICATION FORM" AVAILABLE FOR PICK-UP AT THE SECOND FLOOR FACILITY ADMINISTRATION RECEPTION AREA, LOCATED ON THE 5TH STREET SIDE OF THE FACILITY. THE CORRECTIONAL FACILITY WILL REVIEW THE APPLICATIONS AND CREATE A PRE-APPROVED CONTRACTOR LIST THAT WILL BE LOCATED AT THE PRE-PROCESSING CONTRACTOR CHECK-IN. CONTRACTOR MAY OBTAIN A COPY OF THE PRE-APPROVED LIST FROM ADMINISTRATION.
- 2. THE MAIN CONTRACTOR ACCESS SHALL BE THROUGH THE DOUBLE DOORS LOCATED IN STAIRWELL, WHICH OPENS TO THE DIRT PARKING LOT SIDE OF THE CORRECTIONAL FACILITY, AND PROCEED DOWN TO THE SALLY-PORT. SECONDARY CONTRACTOR ACCESS SHALL BE THROUGH THE 4TH STREET BI-FOLD DOORS ONLY TO BRING TOOLS OR EQUIPMENT INSIDE THE SALLY-PORT.
- ONCE INSIDE THE SALLY-PORT, CONTRACTOR TO ENTER THE FACILITY THROUGH THE DOUBLE DOOR VESTIBULE NEXT TO PRE-BOOKING.
- CONTRACTOR WILL MEET WITH THE DUTY SHIFT SUPERVISOR IN PROCESSING AND PRESENT THEIR PERSONAL IDENTIFICATION, EITHER A CALIFORNIA DRIVER'S LICENSE OR PASSPORT AND INFORM THE SHIFT SUPERVISOR OF THEIR WORK ASSIGNMENT AND LOCATION WITHIN THE FACILITY.
- THE SHIFT SUPERVISOR WILL CHECK THE PRE-APPROVED CONTRACTOR LIST AND ASSIGN ALL CONTRACTORS "CLIP-ON VISITOR PASSES" WHICH SHALL BE VISIBLY WORN BY ALL CONTRACTORS AND EMPLOYEES WHILE INSIDE THE FACILITY, FOR SAFETY AND SECURITY
- 6. THE SHIFT SUPERVISOR WILL INFORM AND ADVISE CENTRAL CONTROL AND THE LOA'S OFFICE OF THE LOCATION OF WORK. IN THE EVENT OF AN EMERGENCY, ALL FACILITY GUIDELINES AND EVACUATIONS SHALL BE FOLLOWED PER CORRECTIONAL FACILITY POLICIES AND PROCEDURES.
- 7. CONTRACTOR WILL MEET WITH A WORK CREW LEADER OR CORRECTIONAL OFFICER WHO WILL ESCORT THEM TO THEIR APPROPRIATE WORK LOCATION. ALL TOOLS AND EQUIPMENT SHALL BE IDENTIFIED AND INVENTORIED FOR SAFETY AND SECURITY.
- 8. UPON COMPLETION OF WORK SHIFT, CONTRACTORS AND ALL TOOLS AND EQUIPMENT SHALL BE ACCOUNTED FOR. ALL TOOLS SHALL BE REMOVED FROM THE FACILITY OR PLACED IN A DESIGNATED SECURE LOCATION. THE SECURE LOCATION WILL BE DESIGNATED BY THE SHIFT SUPERVISOR OR SECURITY ESCORT.
- 9. CONTRACTORS SHALL EXIT THROUGH PROCESSING AND MUST CHECK OUT WITH THE SHIFT SUPERVISOR.
- 10. CONTRACTOR SHALL SHOW PERSONAL IDENTIFICATION, AND ONCE VERIFIED BY SHIFT SUPERVISOR, MAY EXIT THE CORRECTIONAL FACILITY THROUGH THE SALLY-PORT.

CONTRACTOR WORK ACCESS SHIFTS

CONTRACTOR WORK SHIFTS MONDAY THROUGH SUNDAY:

ACCESS FROM: 7:00PM TO 9:00PM

FACILITY LOCKDOWN FROM: 9:00PM TO 7:00AM

CONTRACTOR WORK REQUIREMENTS

- 1. WORK THAT PRODUCES EXCESSIVE NOISE LEVELS SHALL BE SCHEDULED TO BE PREFORMED ON WEEKENDS TO MINIMIZE INTERRUPTIONS FOR JAIL STAFF.
- 2. COORDINATE CONCRETE POURS WITH JAIL STAFF TO BE PREFORMED OUTSIDE OF NORMAL OPERATION HOURS, ALLOWING FOR MINIMAL SHUT-DOWN OF THE INTAKE
- CONTRACTOR TRAFFIC BETWEEN THE STAGING AREA AND THE AREA OF REMODEL SHALL BE MINIMIZED IN AN EFFORT TO ALLOW THE INTAKE AREA TO OPERATE NORMALLY DURING THE ENTIRE PERIOD OF THE CONSTRUCTION.


LEGEND

- DOOR CONTROLLED BY CENTRAL CONTROL
- DOOR CONTROLLED BY KEY ISSUED TO CONTRACTOR FROM OWNER

- - - - - ACCESS PATH FOR CONTRACTOR

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CONSULTANTS

LICENSE STAMPS

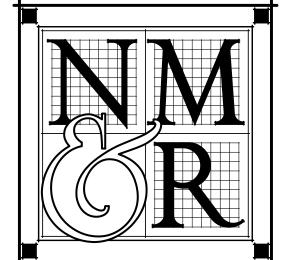

PROJECT NAME

MEDICAL SHOWER

ADA UPGRADES

FOR

HUMBOLDT COUNTY JAIL

901 5TH STREET EUREKA, CALIFORNIA

SHEET TITLE
OVERALL FLOOR PLAN
& ACCESS/ WORK

DRAWING STATUS
CONSTRUCTION
DOCUMENTS

PROTOCOLS

REVISIONS
Sym. Description By Date

Drawn By

Checked By

DRC

Date Drawn

10-04-2018

Scale


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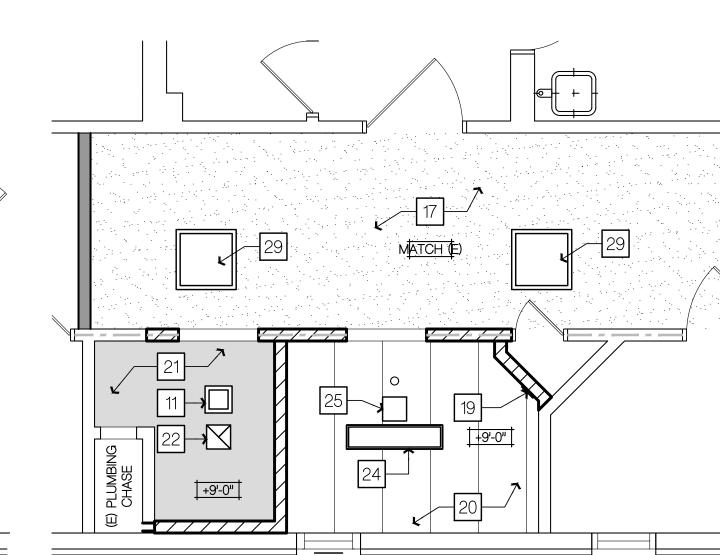
A200



DEMO FLOOR PLAN SCALE: 1/4" = 1'-0"

_48x60 CLF

FLOOR PLAN SCALE: 1/4" = 1'-0"

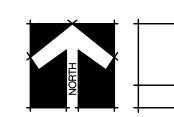




DEMO CEILING PLAN

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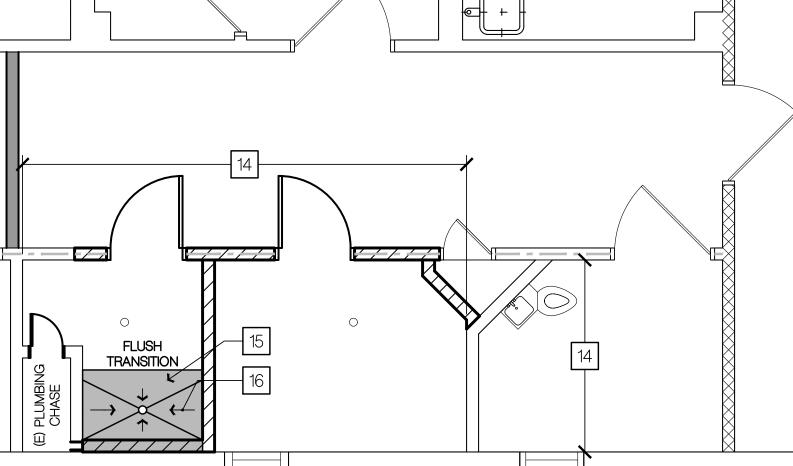






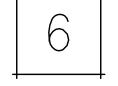

SCALE: 1/4" = 1'-0"





DEMOLITION SHEET NOTES | FLOOR PLAN SHEET NOTES

A REMOVE CMU WALL COMPLETELY

B REMOVE SHOWER INSERT COMPLETELY

C SAWCUT AND REMOVE 8" CONCRETE SLAB

ALL ITEMS ARE EXISTING, UNLESS NOTED AS NEW

D REMOVE COMBI UNIT & HANDRAIL COMPLETELY

SECURITY/TAMPER RESISTANT FASTENERS

REMOVE VINYL FLOORING & COVE BASE, PREP FLOOR FOR RESINOUS SURFACING F ADJUST FLOOR DRAIN TO PROVIDE A SMOOTH TRANSITION AT NEW FLOORING. VERIFY FLOOR DRAIN IS SECURED WITH

G INSTALL FULL HEIGHT 2X0 LEIVIF CLIVITY ON SECURE SIDE, USE SECURITY FASTNERS I INSTALL FULL HEIGHT 2X6 TEMPORARY WALL WITH 1 1/8" PLYWOOD

SAW CUT AND REMOVE SUSPENDED PLASTER CEILING AND ALL CEILING MOUNTED FIXTURES COMPLETELY AS SHOWN

REMOVE EXISTING PAGING DEVICE AND OUTLET BOX. INTERCEPT J EXISTING WIRE FOR REUSE REMOVE HVAC GRILLE AND SHORTEN LENGTH OF DUCT FOR NEW GRILL LOCATION

REMOVE ILLUMINATED LIGHT SWITCH, OUTLET BOX, CONDUIT AND └ | WIRE BACK TO LIGHITNG FIXTURE

M FIRE SPRINKLER HEAD, PROTECT FROM DEMO AND FOR INSTALLATION OF NEW CEILING

REMOVE EXISTING FIRE ALARM SMOKE DETECTOR AND SECURITY COVER. SAVE FOR REINSTALLATION

DISCONNECT AND REMOVE EXISTING TV AND RECEPTACLE DEVICES.REMOVE WIRE AND CABLE BACK TO LAST REMAINING OUTLETS, INSTALL BLANK SECURITY COVER PLATES ON EXISTING

R REMOVE (E) ACCESS DOOR

S CORE DRILL HOLE IN CMU WALL FOR NEW CONDUIT

DOOR HARDWARE

AIRTEQ 640 FMC

TRIMCO K0050 x 16" H

SOUTHERN STEEL

FIRE RATED GLASS

AIRTEQ 612

AIRTEQ 614

AIRTEQ 650

METCO - MATCH EXISTING KEYING

US32D

US32D US32D

630

262

DOORS 101A & 102A - RATING 45 MIN

RAISED PULL

FLUSH PULL

FLOOR STOP

KICKPLATE

LOCKSET

1-1/2 PAIR HINGES

DOOR 102A ONLY: 1 EA FOOD PASS

GLAZING 45 MIN

1 EA

1 EA

1 EA

ALL ITEMS ARE NEW, UNLESS NOTED AS (E) OR EXISTING

6" FULL HEIGHT CMU WALL. PROVIDE REINFORCING PER DETAIL 1/A901. PROVIDE STEEL EMBEDMENT AT (E) FLOOR AND END OF WALL PER DETAIL 1/A901, AVOID (E) REINFORCING.

2 16" x 36" ACCESS DOOR

3 WALL MOUNTED DETENTION MIRROR

4 ACCESSIBLE COMBINATION TOILET-LAVATORY UNIT WITH GRAB BAR AND CLOSURE STRIP, INCLUDE CLOSURE PANEL BETWEEN WALL AND COMBINATION UNIT. SEE DETAIL 10/A901.

5 48" SECURITY GRAB BAR - SEE DETAIL 7/A901

FLOOR DRAIN & GRATE, PROVIDE SECURITY/TAMPER RESISTANT FASTENERS

7 (E) WINDOW FRAME TO REMAIN. PREP, PRIME & PAINT

8 SECURITY BUNK - SEE DETAIL 2/A902

9 NEW 3'-0" x 7'-0" DOOR - SEE DETAIL 6/A901

10 SECURITY TOWEL HOOK

PROVIDE NEW SURFACE MOUNTED LED MAXIMUM SECURITY SHOWER LIGHT. KENALL #SQC-A-0-7-23L40K-DCC-1-MVOLT-9/1-1 AND CONNECT TO EXISTING LIGHTING CIRCUIT

12 NOT USED

13 NOT USED

14 RESINOUS SURFACING AT FLOOR AND 8" HIGH BASE

15 8" CONCRETE SLAB, TYP - SEE DETAIL 1/A901 & 1/A902

16 SLOPE SHOWER FLOOR TO DRAIN 2% MAX IN ANY DIRECTION

SUSPENDED CEMENT PLASTER SECURITY CEILING WITH SECURITY METAL LATH

NEW INTERCOM. DETENTION GRADE EMERGENCY PUSH BUTTON WITH STAINLESS STEEL FACE PLATE, INSTALLED WITH SECURITY FASTENERS. CONNECT TO EXISTING INTERCOM WIRING

19 NEW HVAC SUPPLY GRILLE ATTACHED TO (E) DUCT. MATCH SIZE OF DEMOLISHED GRILLE

20 24" WIDE SECURITY METAL PLANK CEILING - SEE DETAIL 3/A902

RESINOUS SURFACING O/ SUSPENDED CEMENT PLASTER SECURITY CEILING WITH SECURITY METAL LATH

SECURITY EXHAUST GRILLE, ROUTE DUCT IN FLOOR SPACE ABOVE CEILING AND OUT TO SOUTH EXTERIOR WALL AS SHOWN

INSTALL NEW ILLUMINATED LIGHT SWITCH WITH CONDUIT AND WIRE 23 to New Light fixture. Mount between 15" Min AFF to Bottom. OF BOX TO 48" MAX AFF TO TOP OF BOX FOR A FORWARD

24 1' x 4', SURFACE MOUNTED, 3 LAMP MAXIMUM SECURITY FLUORESCENT FIXTURE WITH NIGHT LIGHT MANUFACTURER: FAILSAFE #FUSLS12332120 80/94 EB81-LNL-SF3-VRSD 120V LAMPS: 3-F032T8 SP35 1-LED NL

25 REINSTALL EXISTING FIRE ALARM SMOKE DETECTOR AND SECURITY COVER IN NEW CEILING. RECONNECT TO EXISTING FIRE ALARM

26 SEMI RECESSED ANTI-LIGATURE TOILET PAPER HOLDER

27 RECESSED, ADA FOLDING SHOWER SEAT

CONNECT TO EXISTING CIRCUIT

28 CUSTOM STAINLESS STEEL CLOSURE PANEL, FLUSH WITH LAV.

29 30" X 30" 1-HR FIRE RATED DETENTION CEILING ACCESS MATCH JAIL KEYING

ELECTRICAL NOTES

ALL CONDUIT SHALL BE GALVANIZED RIGID STEEL, ANSI C80.1, UL6 WITH THREADED RIGID STEEL CONDUIT COUPLINGS.

ELECTRICAL OUTLET BOXES SHALL BE CONCRETE MASONRY TYPE WHERE INSTALLED IN CMU WALLS. SURFACE BOXES SHALL BE UL 514A, TYPE FD, CAST TYPE WITH SECURITY COVERS AND FASTENERS.

GROUND ALL METALLIC CONDUIT SYSTEMS, CABINETS, EQUIPMENT AND LIGHTING FIXTURES IN ACCORDANCE WITH CEC ARTICLE 250.86

FIRE SEAL ALL CONDUIT PENETRATION THROUGH FIRE RATED ASSEMBLIES. FOR ONE HOUR CMU WALLS PROVIDE UL SYSTEM C-AJ-1013 PENETRATION ASSEMBLY.

GENERAL NOTES

WATER MUST REMAIN ON FOR A MINIMUM OF 10 SECONDS AT

2. OPERABLE FIXTURES AT LAVATORY, SHOWER, AND WATER CLOSET ARE A MAXIMUM 5 LBS. OPERATIONAL FORCE.

. ALL PENETRATIONS THROUGH RATED WALLS SHALL BE PROPERLY

PROVIDE SHORING DESIGN BY LICENSED ENGINEER. INSTALLED BY CONTRACTOR.


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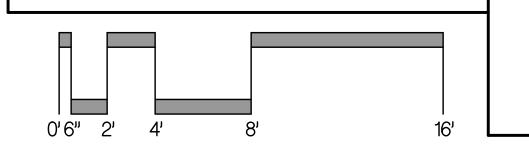
ALL ITEMS ARE NEW, UNLESS NOTED AS (E) OR EXISTING CMU WALL

> 1 HOUR RATED CMU WALL (E) CMU WALL

(E) 1 HOUR RATED CMU WALL (E) 2 HOUR RATED WALL

SCALE: 1/4" = 1'-0" - <u>NOTE:</u> CONNECT 1/2" TEMPERED, 1/2" CW, 4" SS, AND 2" VENT IN - <u>NOTE:</u> CONNECT 4" SS & 2" TEMPERED WATER EXISTING THERMOSTATIC MIXING VALVE **VENT BELOW SLAB** LEONARD TM20 LOCATED IN EXISTING BOILER ROOM. COORDINATE WITH FACILITY STAFF 48 HOURS TO INSTALL PLUMBING. —— 2" DIA CONDUIT FOR PNEUMATIC VALVE HOSE LINE TEMPERED WATER EXISTING THERMOSTATIC MIXING VALVE LEONARD TM20 LOCATED IN EXISTING BOILER ROOM



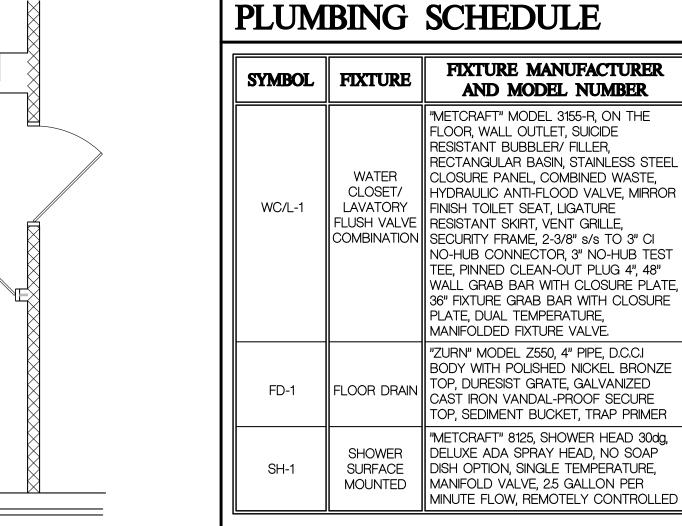



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CONSULTANTS

PROJECT NAME MEDICAL SHOWER ADA UPGRADES FOR

> HUMBOLDT COUNTY

901 5TH STREET **EUREKA, CALIFORNIA**


SHEET TITLE **DEMO & NEW** FLOOR & REFLECTED **CEILING PLANS**

DRAWING STATUS CONSTRUCTION DOCUMENTS

	REVISIONS				
5	Sym.	Description	Ву	Date	


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LICENSE STAMPS

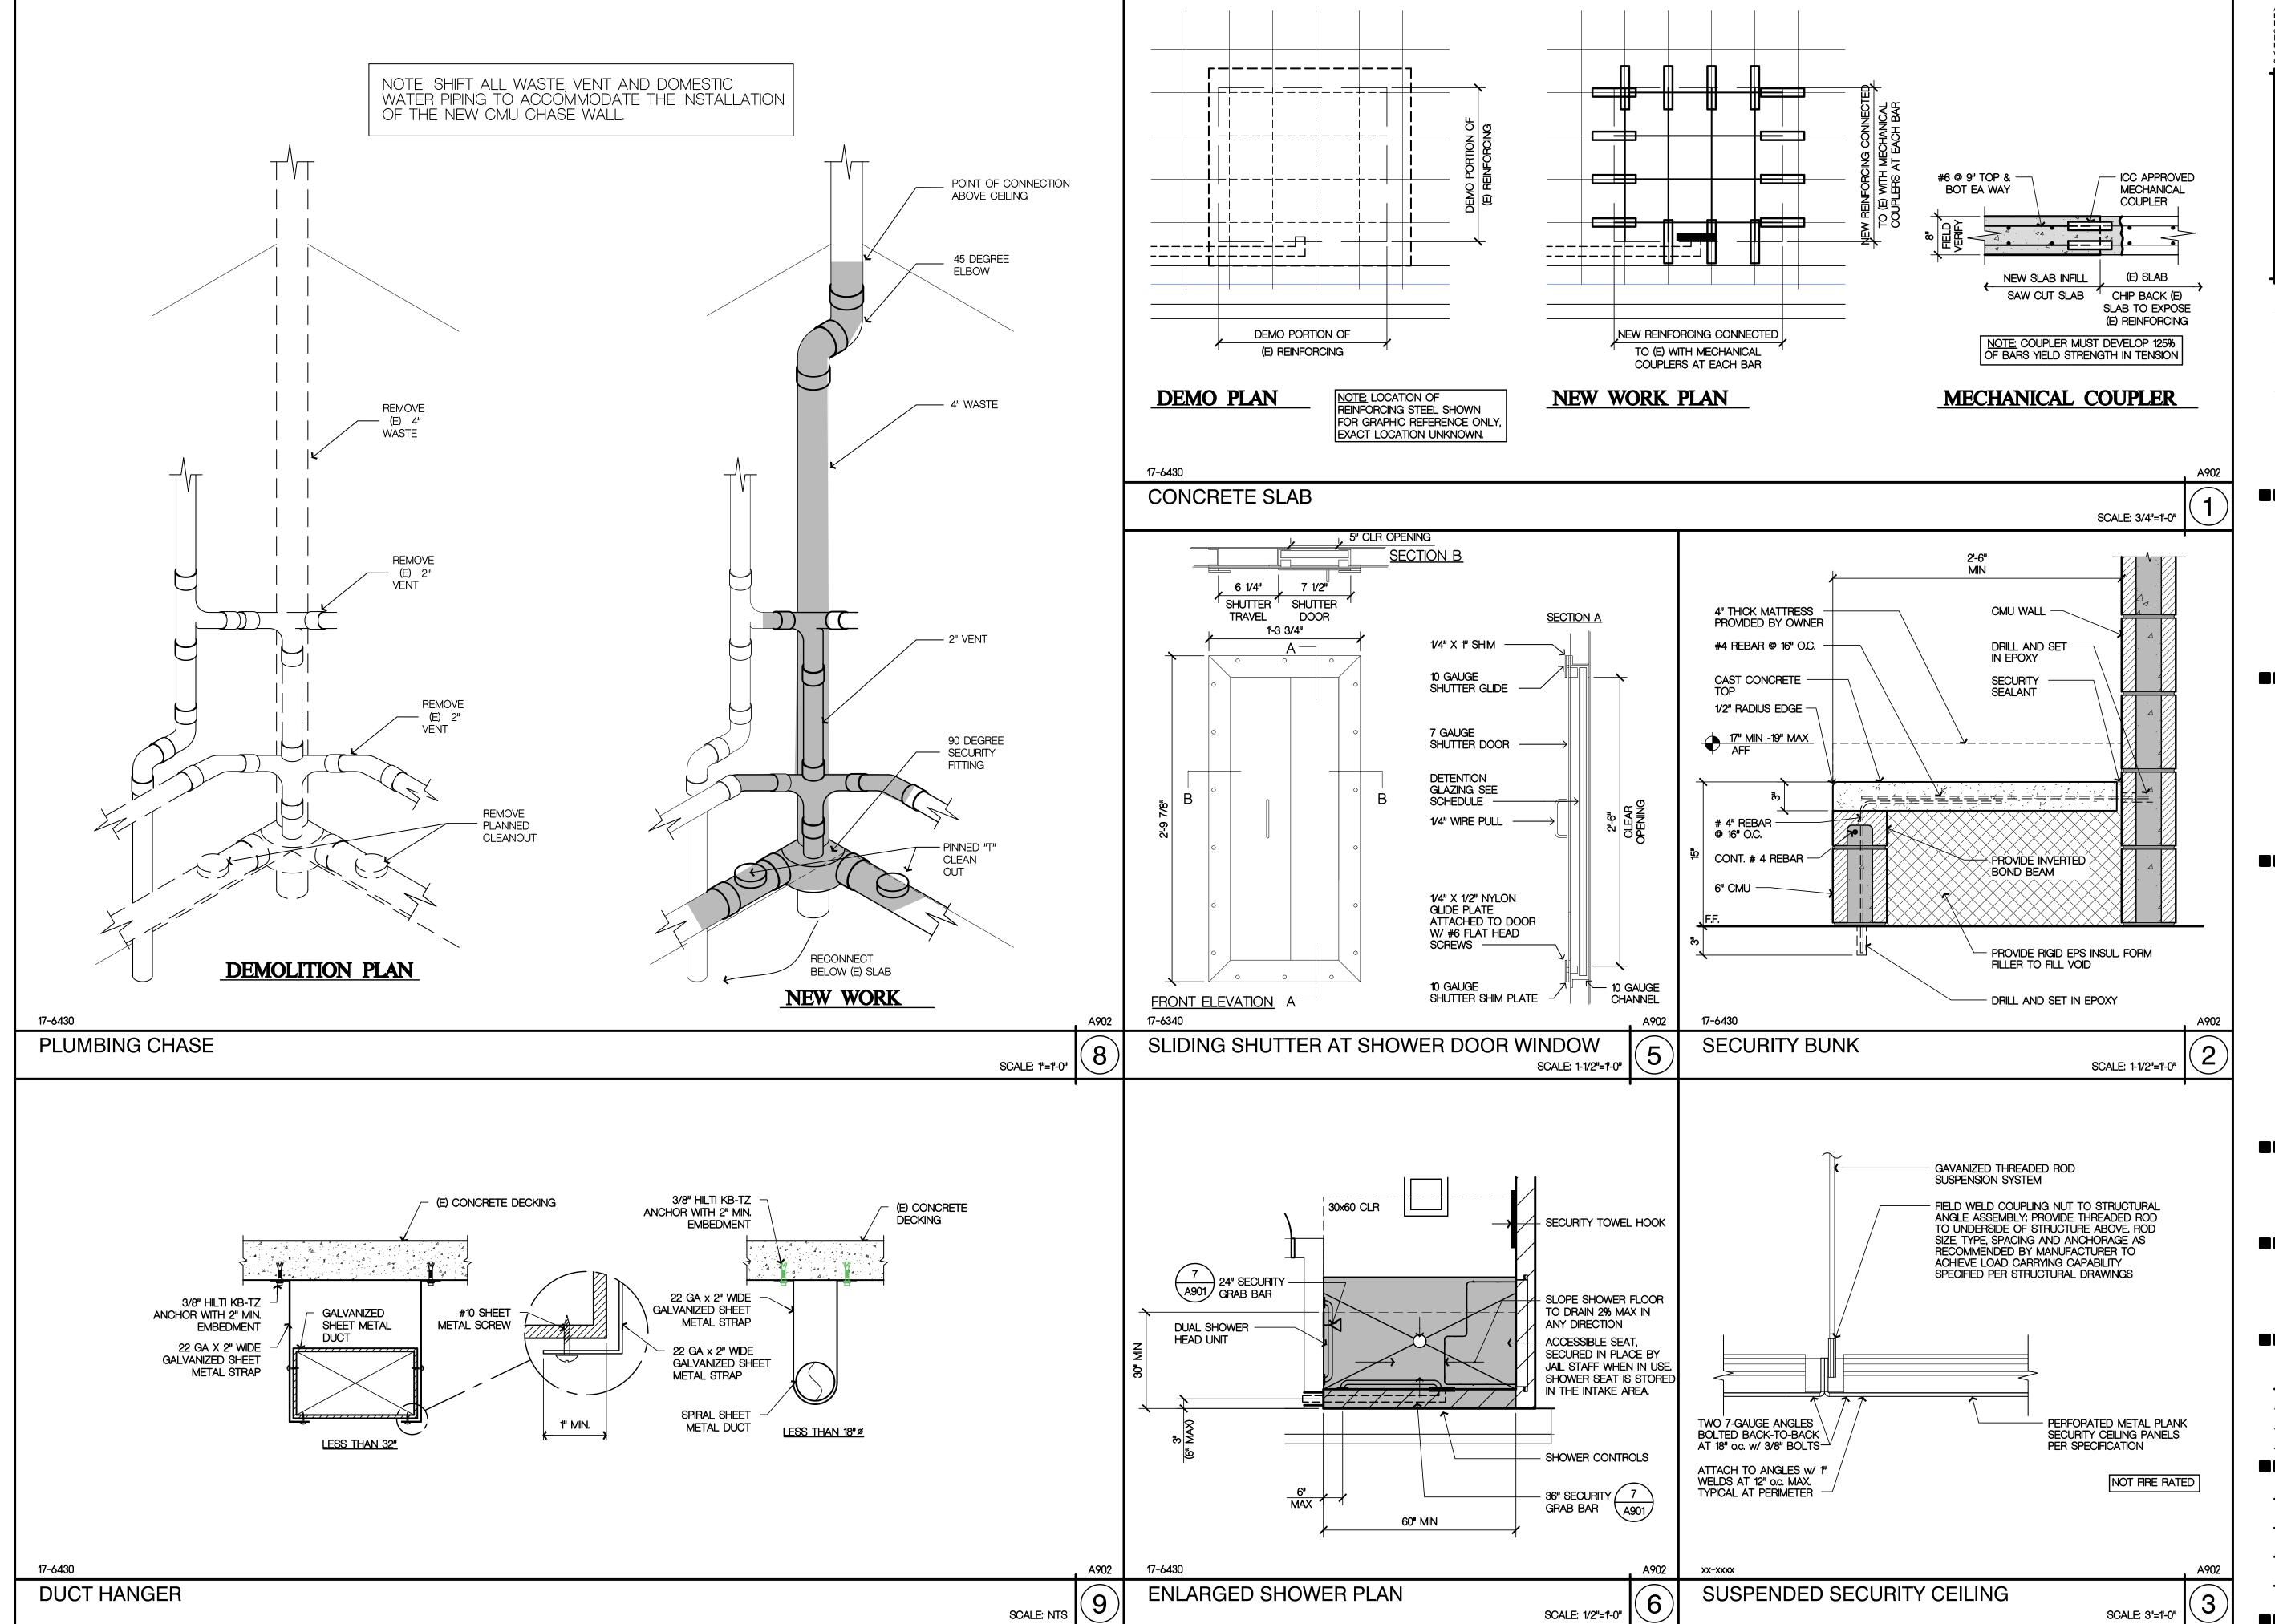

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Drawn By

Checked By

Date Drawn

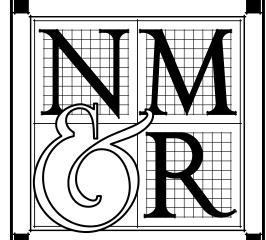10-04-2018

Scale


AS NOTED

Job No.


17-6430


SHEET No.

4902

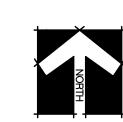

FIRST FLOOR MECHANICAL PLAN

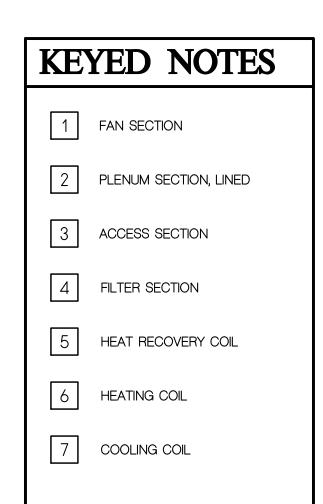

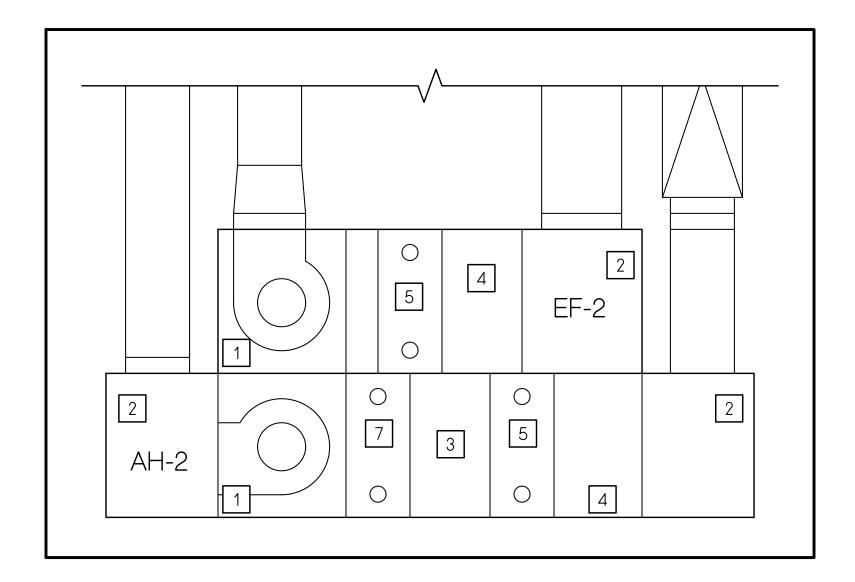



MECHANICAL ROOM SECTION

EXISTING AH-2 ORIGINAL EXISTING EF-2 ORIGINAL DESIGN DATA **DESIGN DATA**

MAXIMUM AIR CAPACITY - CFM TOTAL STATIC PRESSURE - 'H20 3023 OUTLET VELOCITY - FPM 990 3279 FAN SPEED - RPM TIP SPEED - FPM MINIMUM MOTOR - HP 89.5 MINIMUM NOTOR EFFICIENCY YES INLET VANE DAMPERS 13' FC FAN WHEEL TYPE INTERNALLY ISOLATED - OPEN SPRINGS COIL TO FIT UNIT MINIMUM COIL AREA - SQ. FT. CAPACITY - MBH GLYCOL SOLUTION - %

71.4 10% GLYCOL SOLUTION - GPM LEAVING GLYCOL TEMPERATURE - F. 49.1 44.9 ENTERING GLYCOL TEMPERATURE - F. GLYCOL PRESSURE LOSS - FT. H20 70 49.5 ENTERING AIR TEMPERATURE - F. LEAVING AIR TEMPERATURE - F. 0.73 AIR PRESSURE DROP - 1420 MATCH MARK NO. CAPACITY 6R/14F MINIMUM ROWS/FINS PER INCH P/8 SERVED BY PUMP

YES 2" DISPOSABLE FILTERS FILTER AREA - SQ. FT. DESIGN WEIGHT CARRIER 'UniFLX33' CASE SIZE

MAXIMUM AIR CAPACITY - CFM MINIMUM OUTSIDE AIR - % 100 TOTAL STATIC PRESSURE - 'H20 2500 OUTLET VELOCITY - FPM 3577 FAN SPEED - RPM 11484 TIP SPEED - FPM MINIMUM MOTOR - HP 89.5 YES MINIMUM NOTOR EFFICIENCY -% INLET VANE DAMPERS 14' AF FAN WHEEL TYPE YES INTERNALLY ISOLATED - OPEN SPRINGS COIL TO FIT UNIT MINIMUM COIL AREA - SQ. FT. 8.9 71.4 CAPACITY - MBH GLYCOL SOLUTION - % 10% GLYCOL SOLUTION - GPM 49.1 ENTERING GLYCOL TEMPERATURE - F. LEAVING GLYCOL TEMPERATURE - F. 44.9 0.9 GLYCOL PRESSURE LOSS - FT. H20 ENTERING AIR TEMPERATURE - F. 30 46.8 LEAVING AIR TEMPERATURE - F. 0.8 AIR PRESSURE DROP - 'H20 EF/2 MATCH MARK NO. CAPACITY 8R/14F MINIMUM ROWS/FINS PER INCH P/8 SERVED BY PUMP COIL TO FIT UNIT YES CH WATER MINIMUM AREA - SQ. FT. 6.7 FACE VELOCITY - FPM 438 COOLING CAPACITY - MBH TOTAL/SENSIBLE 127/115

LEAVING CHILLED WATER - F 11.4 CHILLED WATER PRESSURE LOSS - FT. H20. 6R/8F MINIMUM ROWS/FINS PER INCH 2" DISPOSABLE FILTERS YES FILTER AREA - SQ. FT. 7.2 SMOKE DETECTOR SHUT DOWN YES 2050 DESIGN WEIGHT CARRIER 'UniFLX33' CASE SIZE

82/64.6

55.1/53.6 0.55 25.4

ENTERING AIR - F. db/F. wb

AIR PRESSURE DROP - 'H20 CHILLED WATER - GPM ENTERING CHILLED WATER - F.

LEAVING AIR - F. db/F. wb

EXISTING CVV BOX ORIGINAL DESIGN DATA


	MARK NO.	CVV/1	CVV/1	CVV/1
	TYPE SYSTEM INFECTIOUS MODE AIR CAPACITY AIR INLET DIAMETER - INCHES MINIMUM STATIC PRESSURE - 'H20	REHEAT ISOL. 280 375 10" 0.333	REHEAT ANTERM. 281 250 10" 0.344	REHEAT ISOL. 28: 375 10" 0.273
REHEAT COIL	FINNED LENGTH x HEIGHT - INCHES CAPACITY - MBH ENTERING AIR - F. LEAVING AIR - F. HEATING WATER - GPM ENTERING HEATING WATER - F. HW PRESSURE LOSS - FT. H20	12"×12" 22.1 41.8 90 1.1 180 0.21	12"×12" 22.1 41.8 90 1.1 180 0.29	12"x12" 22.1 41.8 90 1.1 180 0.19
	2" DISPOSABLE PRE-FILTER - 24" x 12" HEPA FILTER SIZE - 24" x 12" x 12" HEPA FILTER EFFICIENCY - % DESIGN WEIGHT - LB. COIL BRANCH PIPE SIZES - INCHES	YES YES 99.99% 57 3/4"	YES YES 99.99% 42 3/4"	YES YES 99.99% 57 3/4"

EXISTING VAV BOX ORIGINAL DESIGN DATA

MARK NO.	VAV/15	VAV/16	VAV/17	VAV/18	VAV/19	VAV/20	VAV/21
TYPE	REHEAT	REHEAT	REHEAT	REHEAT	REHEAT	REHEAT	REHEAT
SYSTEM	CELL 284	EXAM 267	EXAM 268	DENTAL 167	ADM 272	CELLS 274-279	RECEPT. 290
MAXIMUM AIR CAPACITY - CFM	400	400	250	600	300	1025	365
HEATING AIR VOLUME -CFM	200	200	100	200	100	500	150
AIR INLET DIAMETER - INCHES	7"	7"	5"	7"	6"	יי10"	6"
MINIMUM STATIC PRESSURE - 'H20	0.16	0.16	0.115	0.36	0.16	0.345	0.25
REHEAT COIL CAPACITY- MBH	9.1	9.1	5.6	9.1	5.6	21.0	6.4
ENTERING AIR -F.	42.4	42.4	44.2	44.2	44.2	44.2	44.2
LEAVING AIR - F.	84.5	84.5	97.7	84.5	56.1	83.1	90
HEATING WATER - GPM	0.5	0.5	0.5	0.5	0.5	2	0.5
ENTERING HEATING WATER - F.	180	180	180	180	180	180	180
HW PRESSURE LOSS - FT. H20	0.24	0.24	0.17	0.24	0.17	0.17	1.12
DESIGN WEIGHT - LB.	65	65	50	65	50	50	65
COIL BRANCH PIPE SIZES - INCHES	1/2"	1/2"	1/2"	1/2"	1/2"	1/2"	1"

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CONSULTANTS

LICENSE STAMPS

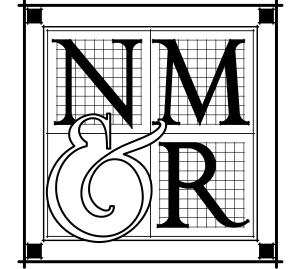

PROJECT NAME MEDICAL SHOWER ADA UPGRADES FOR

HUMBOLDT COUNTY JAIL

901 5TH STREET EUREKA, CALIFORNIA


SHEET TITLE FIRST FLOOR **HVAC PLAN**

DRAWING STATUS CONSTRUCTION DOCUMENTS

Sym. Description By Date

Drawn By	KSK/AMP
Checked By	DRC
Date Drawn	10-04-2018
Scale	AS NOTED
Job No.	17-6430

M210

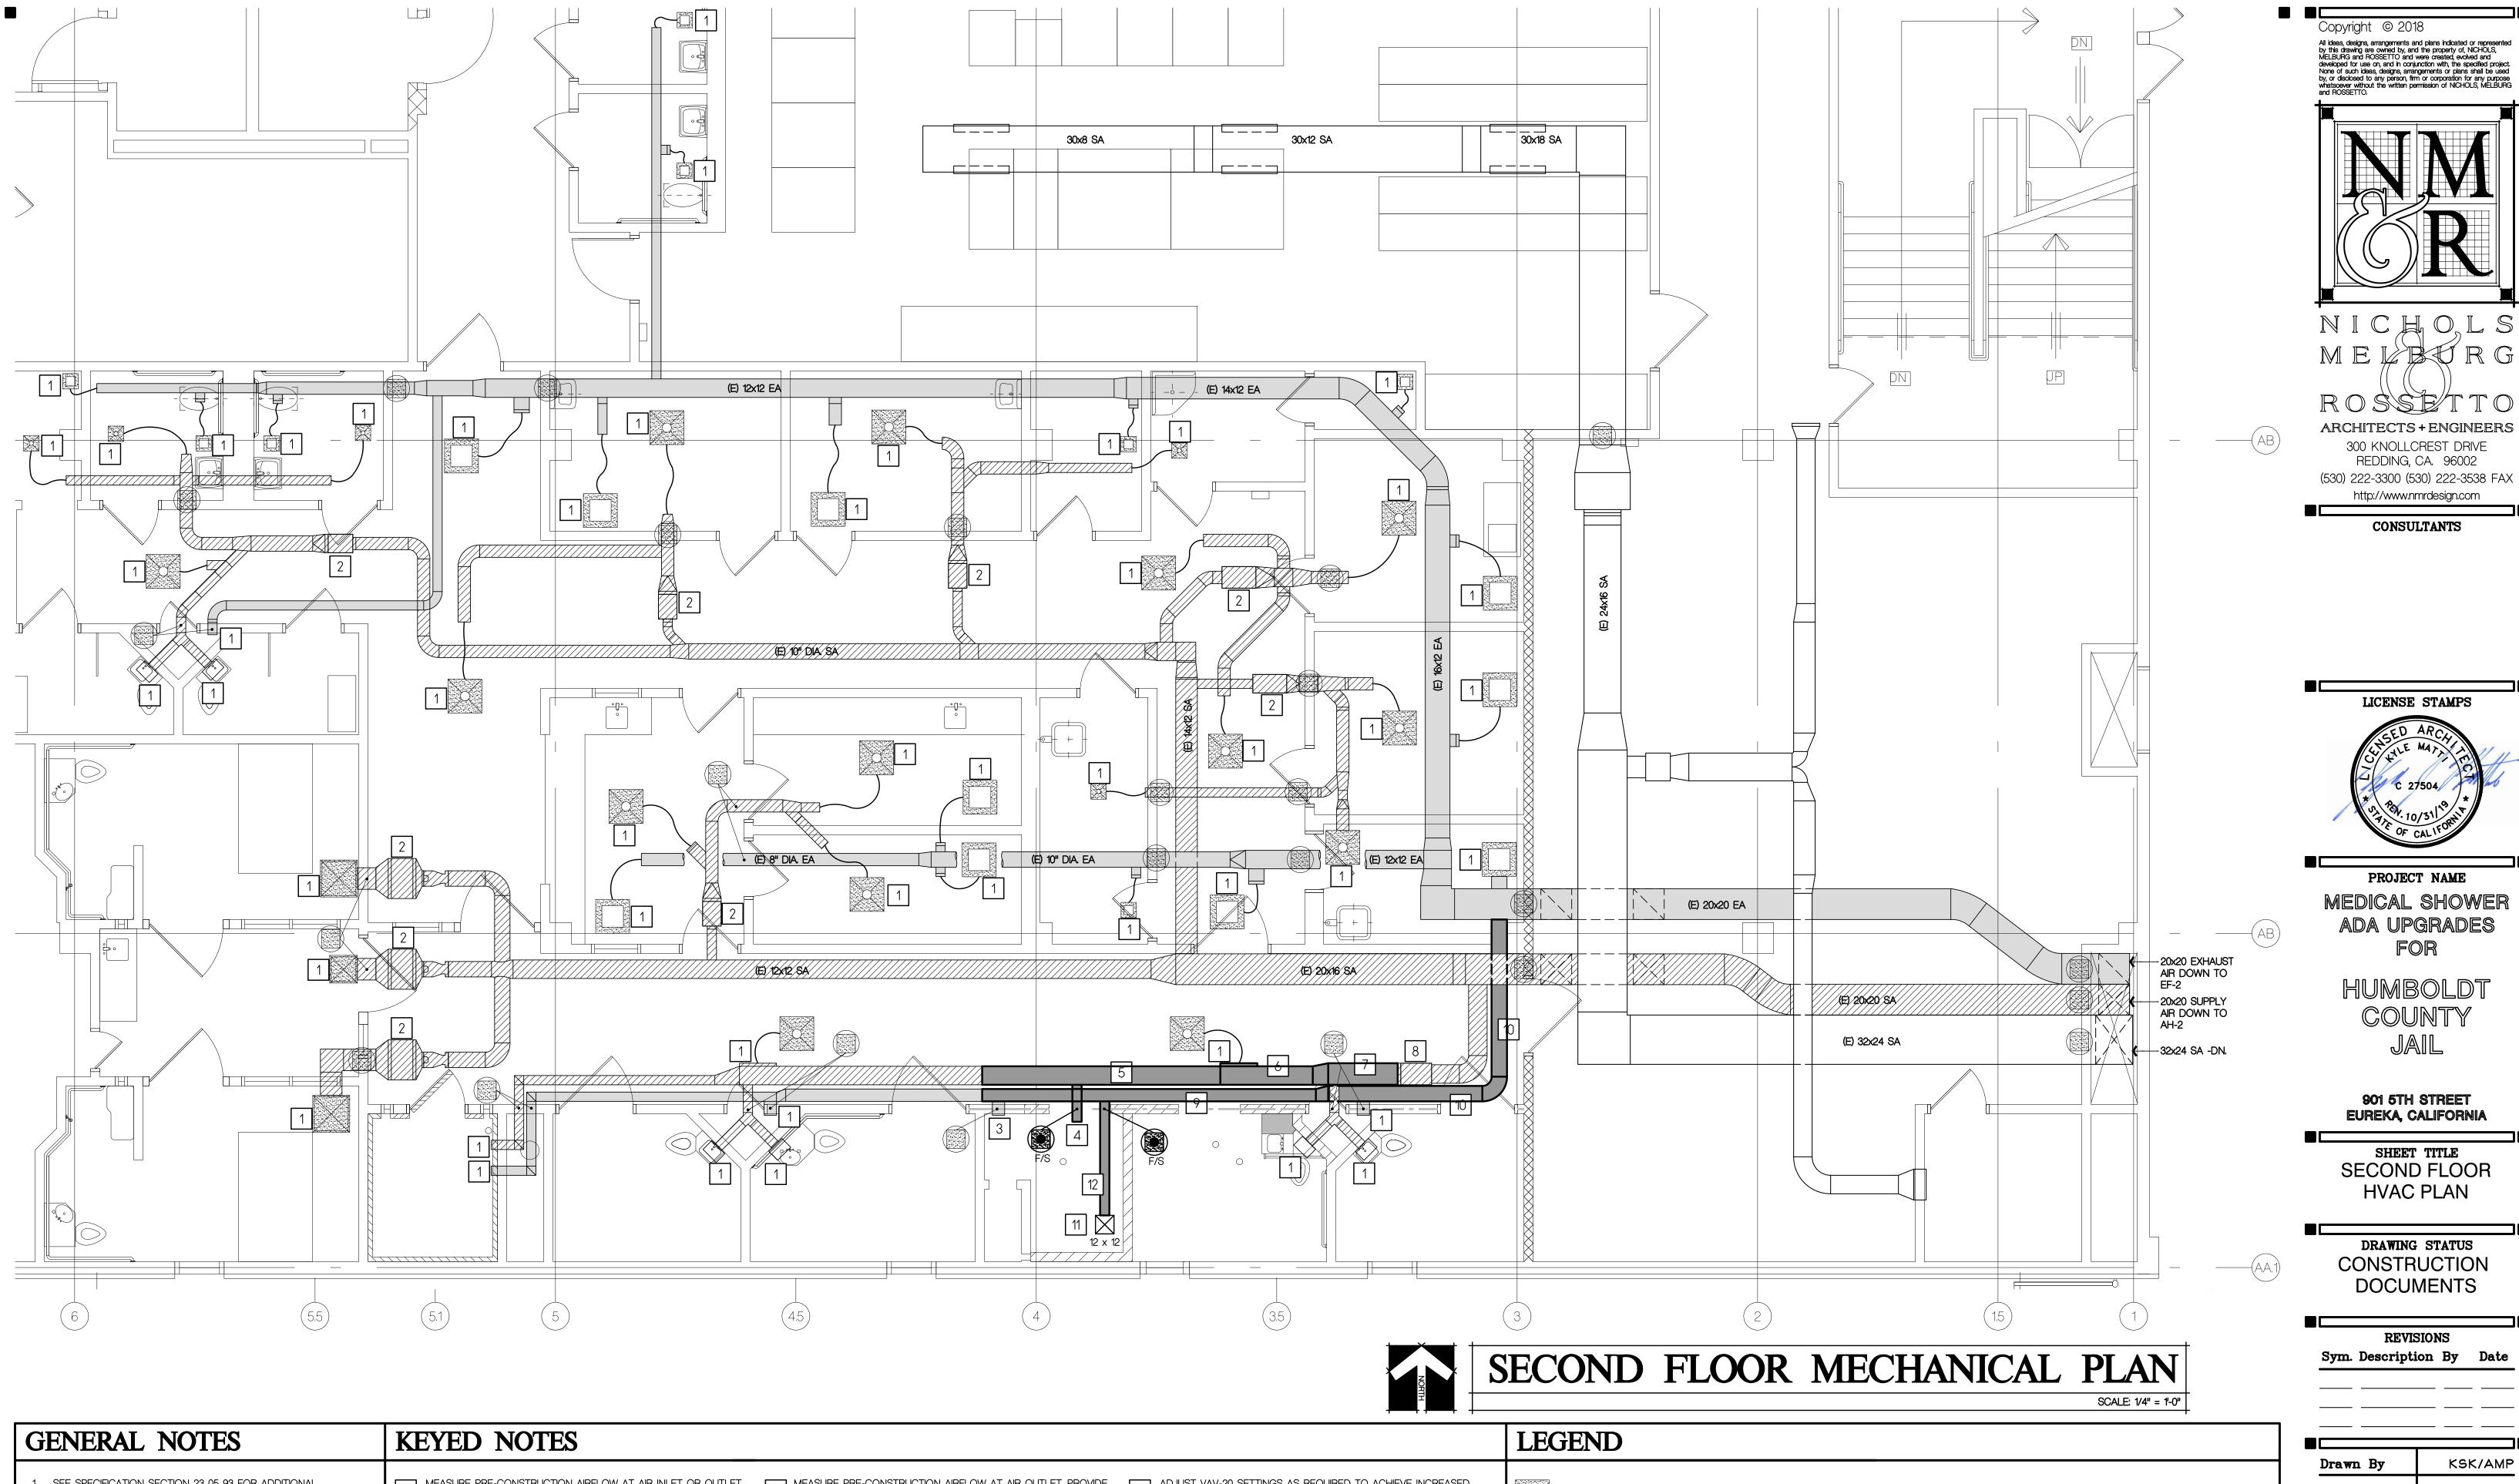

KSK/AMP Drawn By Checked By Date Drawn 10-04-2018

CONSULTANTS

FOR

COUNTY

901 5TH STREET

SHEET TITLE

HVAC PLAN

DRAWING STATUS

REVISIONS

AS NOTED Scale Job No. 17-6430

SHEET No.

1,	SEE SPECIFICATION SECTION 23 05 93 FOR ADDITIONAL

- INFORMATION.
- SEE M210 FOR (EXISTING) EF-2 AND AH-2 ORIGINAL DESIGN
- SEE M210 FOR (EXISTING) CVV BOX AND VAV BOX ORIGINAL DESIGN DATA
- 4. PROTECT OPENINGS AND PENETRATIONS AT FIRE RATED
- MEASURE PRE-CONSTRUCTION AIRFLOW AT AIR INLET OR OUTLET. AT COMPLETION OF PROJECT, BALANCE SYSTEM TO MAINTAIN PRE-CONSTRUCTION AIRFLOW RATES.
- 2 COORDINATE WITH FACILITY PERSONNEL TO SET VAV BOX AT CURRENT AIRFLOW SETTING FOR COOLING AIRFLOW, DURING BOTH PRE-CONSTRUCITON AIRFLOW TESTING AND POST-CONSTRUCTION
- MEASURE PRE-CONSTRUCTION AIRFLOW AT AIR INLET OR OUTLET. PROVIDE NEW EXHAUST GRILLE AND BRANCH DUCT, SIZED FOR 150 CFM AND LOCATED OVER NEW SHOWER. INCREASE EXHAUST AIRFLOW IN ROOM TO 200 CFM DURING SYSTEM BALANCING (150 CFM FROM NEW GRILLE, 50 CFM FROM EXISTING GRILLE). PROVIDE NEW BALANCE DAMPER IN NEW EXHAUST BRANCH DUCT.
- MEASURE PRE-CONSTRUCTION AIRFLOW AT AIR OUTLET. PROVIDE NEW SUPPLY GRILLE, BRANCH DUCT, AND VOLUME DAMPER, AS REQUIRED TO INCREASE AIRFLOW. INCREASE SUPPLY AIRFLOW IN ROOM TO 200 CFM DURING SYSTEM BALANCING.
- REPLACE PORTION OF EXISTING 12/8 SUPPLY AIR DUCT WITH 12/12 SUPPLY AIR DUCT. MAKE ALL REQUIRED MODIFICATIONS TO DUCT TRANSITIONS AND BRANCHES.
- REPLACE PORTION OF EXISTING 12/12 SUPPLY AIR DUCT WITH 14/12 SUPPLY AIR DUCT. MAKE ALL REQUIRED MODIFICATIONS TO DUCT TRANSITIONS AND BRANCHES.
 - 7 REPLACE PORTION OF EXISTING 14/12 SUPPLY AIR DUCT WITH 14/14 SUPPLY AIR DUCT. MAKE ALL REQUIRED MODIFICATIONS TO DUCT TRANSITIONS AND BRANCHES.
- ADJUST VAV-20 SETTINGS AS REQUIRED TO ACHIEVE INCREASED AIRFLOW REQUIREMENTS.
- PREPLACE PORTION OF EXISTING 8/8 EXHAUST AIR DUCT WITH 10/10 EXHAUST AIR DUCT. MAKE ALL REQUIRED MODIFICATIONS TO DUCT TRANSITIONS AND BRANCHES.
- REPLACE PORTION OF EXISTING 10/8 EXHAUST AIR DUCT WITH 12/10 EXHAUST AIR DUCT. MAKE ALL REQUIRED MODIFICATIONS TO DUCT TRANSITIONS AND BRANCHES.
- NEW DETENTION GRILL SEE SPECIFICATION SECTION 23 00 00 FOR GRILLE INFORMATION

(E) CEILING MOUNTED EXHAUST GRILLE

(E) CEILING DIFFUSER

(E) FIRE/SMOKE DAMPER

NEW FIRE/SMOKE DAMPER - SEE

SPECIFICATION SECTION 23 00 00

NEW DUCT

(E) DUCT

(E) SUPPLY DUCT

(E) EXHAUST DUCT

12 NEW 8/8 GA DUCT