SUPPLEMENTAL INFORMATION NUMBER:

For Planning Commission Agenda of:

	Continued Hearing Item	Item Number:			
	Public Hearing Item	Item Number:			
	Department Report	Item Number:			
	Old Business	Item Number:			
Re:					
Record Number:					
Assessor's Parcel Number (APN):					
Area:					

Attached for the Planning Commission's record and review is the following supplementary information:



FACILITY IS UNMANNED AND NOT FOR HUMAN HABITATION, ACCESSIBILITY

ACCESS AND REQUIREMENTS ARE NOT REQUIRED, IN ACCORDANCE WITH

EXCEPTION 1 & SECTION 1134B.2.1, EXCEPTION 4.


CALIFORNIA STATE ADMINISTRATIVE CODE, PART 2, TITLE 24, SECTION 1103B.1

USID#: 276950

SITE NUMBER: CCL02143 SITE NAME: ARCATA

> **FOSTER AVENUE ARCATA, CA 95521 JURISDICTION: HUMBOLDT COUNTY** APN: 505-151-006

SITE TYPE: PREMANUFACTURED WALK-IN

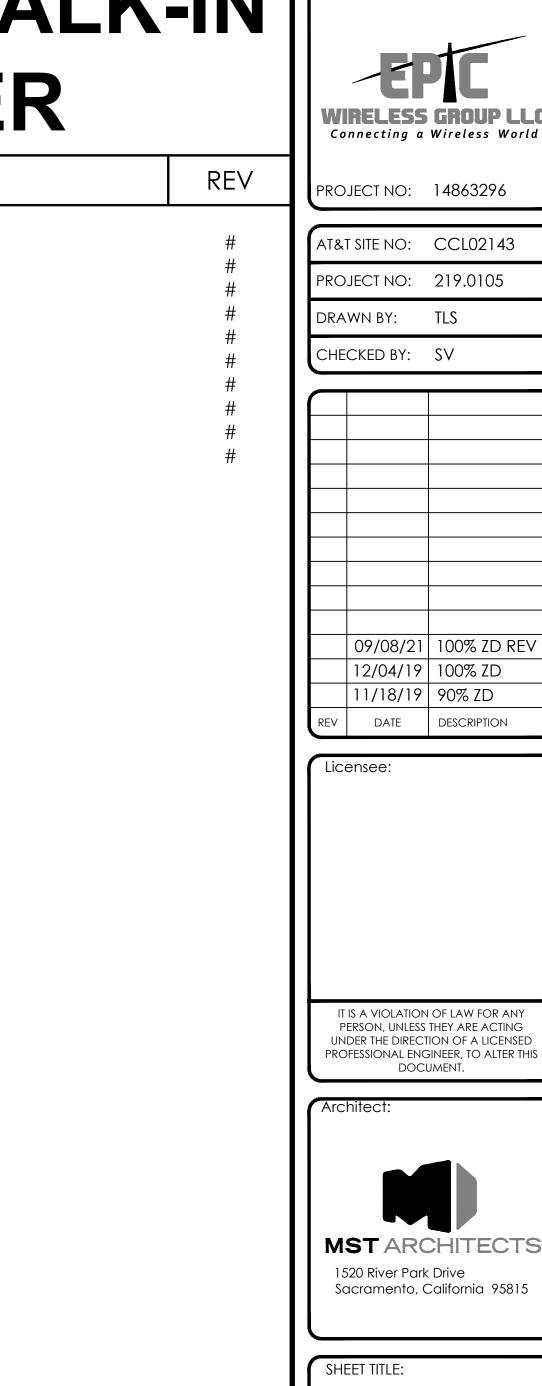

Issued For:

CCL02143

ARCATA

FOSTER AVENUE ARCATA, CA 9552

PREPARED FOR


San Ramon, California 94583

DESCRIPTION

CABINET / FAUX WATER TOWER

THE JOBSITE AND SHALL IMMEDIATELY NOTIFY THE ARCHITECT/ENGINEER IN WRITING OF ANY DISCREPANCIES BEFORE PROCEEDING WITH THE WORK OR

MATERIAL ORDERS OR BE RESPONSIBLE FOR THE SAME.

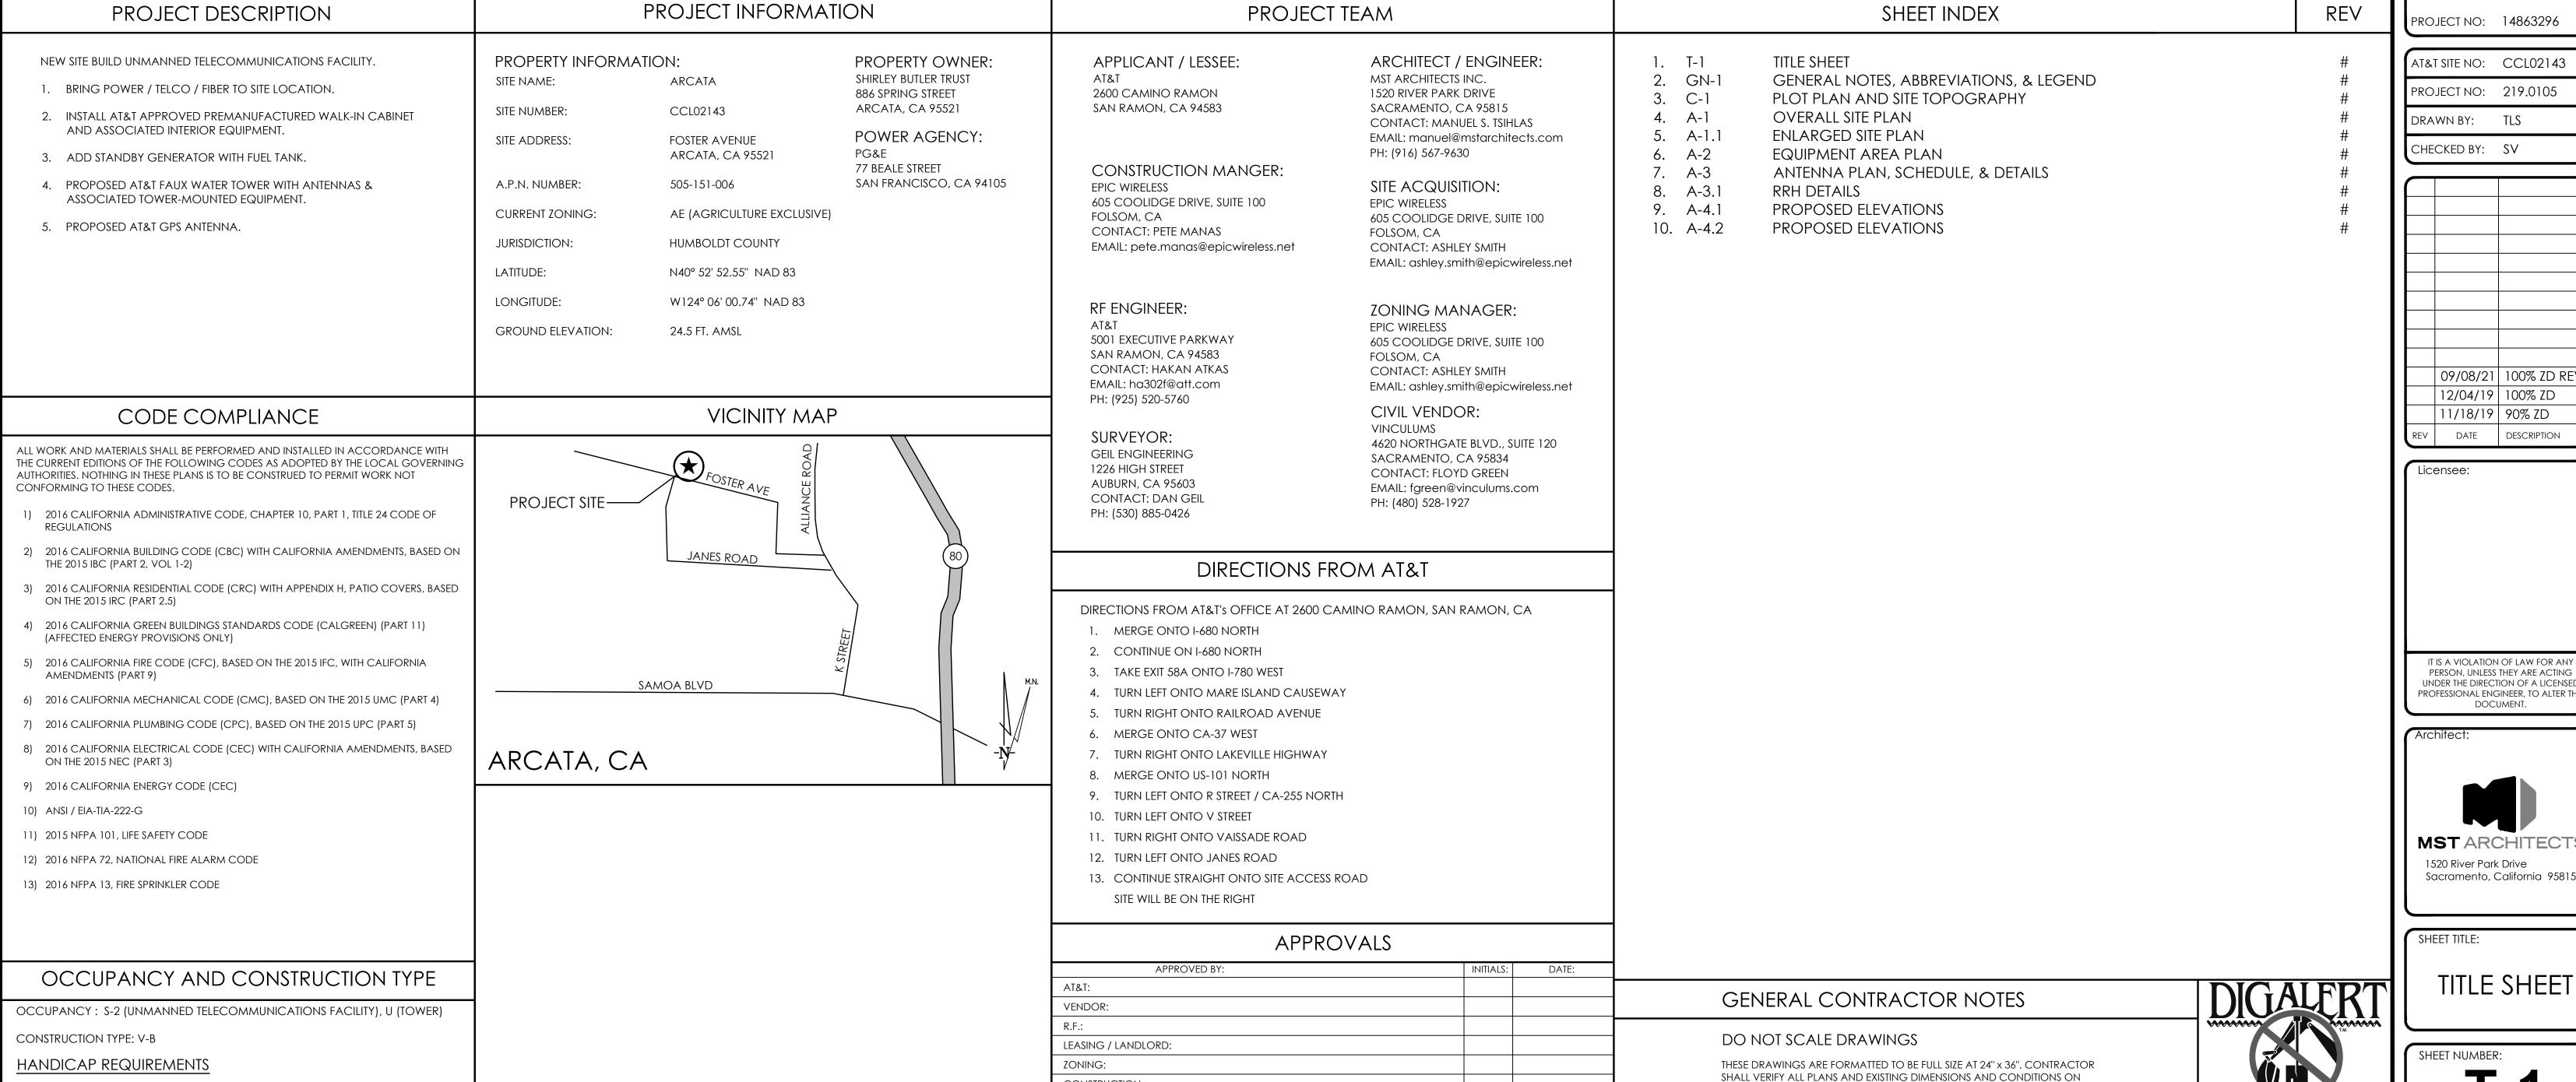

CONSTRUCTION:

POWER / TELCO:

PG&E:

GENERAL CONSTRUCTION NOTES:

- PLANS ARE INTENDED TO BE DIAGRAMMATIC OUTLINE ONLY, UNLESS NOTED OTHERWISE. THE WORK SHALL INCLUDE FURNISHING MATERIALS, EQUIPMENT, APPURTENANCES AND LABOR NECESSARY TO COMPLETE ALL INSTALLATIONS AS INDICATED ON THE DRAWINGS.
- 2. THE CONTRACTOR SHALL OBTAIN, IN WRITING, AUTHORIZATION TO PROCEED BEFORE STARTING WORK ON ANY ITEM NOT CLEARLY DEFINED OR IDENTIFIED BY THE CONTRACT DOCUMENTS.
- 3. CONTRACTOR SHALL CONTACT USA (UNDERGROUND SERVICE ALERT) AT (800) 227-2600, FOR UTILITY LOCATIONS, 48 HOURS BEFORE PROCEEDING WITH ANY EXCAVATION, SITE WORK OR CONSTRUCTION.
- 4. THE CONTRACTOR SHALL INSTALL ALL EQUIPMENT AND MATERIALS IN ACCORDANCE WITH MANUFACTURER'S RECOMMENDATIONS UNLESS SPECIFICALLY INDICATED OTHERWISE, OR WHERE LOCAL CODES OR REGULATIONS TAKE PRECEDENCE.
- 5. ALL CONSTRUCTION SHALL BE IN ACCORDANCE WITH THE CBC / UBC'S REQUIREMENTS REGARDING EARTHQUAKE RESISTANCE, FOR, BUT NOT LIMITED TO, PIPING, LIGHT FIXTURES, CEILING GRID, INTERIOR PARTITIONS, AND MECHANICAL EQUIPMENT. ALL WORK MUST COMPLY WITH LOCAL EARTHQUAKE CODES AND REGULATIONS.
- 6. REPRESENTATIONS OF TRUE NORTH, OTHER THAN THOSE FOUND ON THE PLOT OF SURVEY DRAWINGS, SHALL NOT BE USED TO IDENTIFY OR ESTABLISH BEARING OF TRUE NORTH AT THE SITE. THE CONTRACTOR SHALL RELY SOLELY ON THE PLOT OF SURVEY DRAWING AND ANY SURVEYOR'S MARKINGS AT THE SITE FOR THE ESTABLISHMENT OF TRUE NORTH, AND SHALL NOTIFY THE ARCHITECT / ENGINEER PRIOR TO PROCEEDING WITH THE WORK IF ANY DISCREPANCY IS FOUND BETWEEN THE VARIOUS ELEMENTS OF THE WORKING DRAWINGS AND THE TRUE NORTH ORIENTATION AS DEPICTED ON THE CIVIL SURVEY. THE CONTRACTOR SHALL ASSUME SOLE LIABILITY FOR ANY FAILURE TO NOTIFY THE ARCHITECT / ENGINEER.
- 7. THE BUILDING DEPARTMENT ISSUING THE PERMITS SHALL BE NOTIFIED AT LEAST TWO WORKING DAYS PRIOR TO THE COMMENCEMENT OF WORK, OR AS OTHERWISE STIPULATED BY THE CODE ENFORCEMENT OFFICIAL HAVING JURISDICTION.
- 8. DO NOT EXCAVATE OR DISTURB BEYOND THE PROPERTY LINES OR LEASE LINES, UNLESS OTHERWISE NOTED.
- ALL EXISTING UTILITIES, FACILITIES, CONDITIONS, AND THEIR DIMENSIONS SHOWN ON THE PLAN HAVE BEEN PLOTTED FROM AVAILABLE RECORDS. THE ARCHITECT / ENGINEER AND THE OWNER ASSUME NO RESPONSIBILITY WHATSOEVER AS TO THE SUFFICIENCY OR THE ACCURACY OF THE INFORMATION SHOWN ON THE PLANS, OR THE MANNER OF THEIR REMOVAL OR ADJUSTMENT. CONTRACTORS SHALL BE RESPONSIBLE FOR DETERMINING EXACT LOCATION OF ALL EXISTING UTILITIES AND FACILITIES PRIOR TO START OF CONSTRUCTION. CONTRACTORS SHALL ALSO OBTAIN FROM EACH UTILITY COMPANY DETAILED INFORMATION RELATIVE TO WORKING SCHEDULES AND METHODS OF REMOVING OR ADJUSTING EXISTING UTILITIES.
- 10. CONTRACTOR SHALL VERIFY ALL EXISTING UTILITIES, BOTH HORIZONTAL AND VERTICALLY, PRIOR TO THE START OF CONSTRUCTION. ANY DISCREPANCIES OR DOUBTS AS TO THE INTERPRETATION OF PLANS SHOULD BE IMMEDIATELY REPORTED TO THE ARCHITECT / ENGINEER FOR RESOLUTION AND INSTRUCTION, AND NO FURTHER WORK SHALL BE PERFORMED UNTIL THE DISCREPANCY IS CHECKED AND CORRECTED BY THE ARCHITECT / ENGINEER. FAILURE TO SECURE SUCH INSTRUCTION MEANS CONTRACTOR WILL HAVE WORKED AT HIS/HER OWN RISK AND EXPENSE.
- 11. ALL NEW AND EXISTING UTILITY STRUCTURES ON SITE AND IN AREAS TO BE DISTURBED BY CONSTRUCTION SHALL BE ADJUSTED TO FINISH ELEVATIONS PRIOR TO FINAL INSPECTION OF WORK.
- 12. ANY DRAIN AND/OR FIELD TILE ENCOUNTERED / DISTURBED DURING CONSTRUCTION SHALL BE RETURNED TO IT'S ORIGINAL CONDITION PRIOR TO COMPLETION OF WORK. SIZE, LOCATION AND TYPE OF ANY UNDERGROUND UTILITIES OR IMPROVEMENTS SHALL BE ACCURATELY NOTED AND PLACED ON "AS-BUILT" DRAWINGS BY GENERAL CONTRACTOR, AND ISSUED TO THE ARCHITECT / ENGINEER AT COMPLETION OF PROJECT.
- 13. ALL TEMPORARY EXCAVATIONS FOR THE INSTALLATION OF FOUNDATIONS, UTILITIES, ETC., SHALL BE PROPERLY LAID BACK OR BRACED IN ACCORDANCE WITH CORRECT OCCUPATIONAL SAFETY AND HEALTH ADMINISTRATION (OSHA) REQUIREMENTS.
- 14. INCLUDE MISC. ITEMS PER AT&T SPECIFICATIONS

APPLICABLE CODES, REGULATIONS AND STANDARDS:

SUBCONTRACTOR'S WORK SHALL COMPLY WITH ALL APPLICABLE NATIONAL, STATE, AND LOCAL CODES AS ADOPTED BY THE LOCAL AUTHORITY HAVING JURISDICTION (AHJ) FOR THE LOCATION.

THE EDITION OF THE AHJ ADOPTED CODES AND STANDARDS IN EFFECT ON THE DATE OF CONTRACT AWARD SHALL GOVERN THE DESIGN.

SUBCONTRACTOR'S WORK SHALL COMPLY WITH THE LATEST EDITION OF THE FOLLOWING STANDARDS:

- AMERICAN CONCRETE INSTITUTE (ACI) 318, BUILDING CODE REQUIREMENTS FOR STRUCTURAL CONCRETE
- AMERICAN INSTITUTE OF STEEL CONSTRUCTION (AISC), MANUAL OF STEEL CONSTRUCTION, ASD, NINTH EDITION
- TELECOMMUNICATIONS INDUSTRY ASSOCIATION (TIA) 222-H, STRUCTURAL STANDARD FOR STRUCTURAL ANTENNA TOWER AND ANTENNA SUPPORTING STRUCTURES
- INSTITUTE FOR ELECTRICAL AND ELECTRONICS ENGINEERS (IEEE) 81, GUIDE FOR MEASURING EARTH RESISTIVITY, GROUND IMPEDANCE, AND EARTH SURFACE POTENTIALS OF A GROUND SYSTEM IEEE 1100 (1999) RECOMMENDED PRACTICE FOR POWERING AND GROUNDING OF ELECTRICAL EQUIPMENT.

-IEEE C62.41, RECOMMENDED PRACTICES ON SURGE VOLTAGES IN LOW VOLTAGE AC POWER CIRCUITS (FOR LOCATION CATEGORY "C3" AND "HIGH SYSTEM EXPOSURE")

TIA 607 COMMERCIAL BUILDING GROUNDING AND BONDING REQUIREMENTS FOR TELECOMMUNICATIONS TELCORDIA GR-63 NETWORK

- EQUIPMENT-BUILDING SYSTEM (NEBS): PHYSICAL PROTECTION TELCORDIA GR-347 CENTRAL OFFICE POWER WIRING
- TELCORDIA GR-1275 GENERAL INSTALLATION REQUIREMENTS
- TELCORDIA GR-1503 COAXIAL CABLE CONNECTIONS

ANY AND ALL OTHER LOCAL & STATE LAWS AND REGULATIONS

FOR ANY CONFLICTS BETWEEN SECTIONS OF LISTED CODES AND STANDARDS REGARDING MATERIAL, METHODS OF CONSTRUCTION, OR OTHER REQUIREMENTS, THE MOST RESTRICTIVE SHALL GOVERN. WHERE THERE IS CONFLICT BETWEEN A GENERAL REQUIREMENT AND A SPECIFIC REQUIREMENT, THE SPECIFIC REQUIREMENT SHALL GOVERN.

ABBREVIATIONS A.B. **ANCHOR BOLT** IN. (") INCH(ES) ABV. INTERIOR ANTENNA CABLE COVER ASSEMBLY ACCA POUND(S) ADD'L ADDITIONAL LAG BOLTS ABOVE FINISHED FLOOR LINEAR FEET (FOOT **ABOVE FINISHED GRADE** LONG(ITUDINAL) ALUM. ALUMINUM MASONRY ALTERNATE MAXIMUM ANT. ANTENNA M.B. MACHINE BOLT APPRX. APPROXIMATE(LY) **MECHANICAL** ARCH. ARCHITECT(URAL) MANUFACTURER AMERICAN WIRE GAUGE AWG. MINIMUM BLDG. BUILDING MISCELLANEOUS BLOCK BLK. METAL BLKG. BLOCKING NEW NUMBER B.N. **BOUNDARY NAILING** NOT TO SCALE N.T.S. BTCW. BARE TINNED COPPER WIRE O.C. ON CENTER B.O.F. **BOTTOM OF FOOTING** OPNG. OPENING **BACK-UP CABINET** B/U PRECAST CONCRETE CAB. PCS PERSONAL COMMUNICATION SERVICES CANTILEVER(ED PLYWOOD C.I.P. **CAST IN PLACE** POWER PROTECTION CABINET CEILING PRIMARY RADIO CABINET CLR. CLEAR P.S.F. POUNDS PER SQUARE FOOT COL. COLUMN P.S.I. POUNDS PER SQUARE INCH CONC. CONCRETE PRESSURE TREATED CONN. CONNECTION(OR) PWR. POWER (CABINET) CONST. CONSTRUCTION QUANTITY CONT. CONTINUOUS RAD.(R) **RADIUS** PENNY (NAILS) REFERENCE DOUBLE DBL. REINFORCEMENT(ING) DEPT. DEPARTMENT REQUIRED DOUGLAS FIR RIGID GALVANIZED STEEL DIA. DIAMETER SCH. SCHEDULE DIAG. DIAGONAL SHEET DIM. **DIMENSION** SIMILAR DWG. **DRAWING(S SPECIFICATIONS** DWL. DOWEL(S) SQUARE STAINLESS STEE **ELEVATION** STANDARD ELECTRICAL **ELEVATOR** STRUCTURAL ELECTRICAL METALLIC TUBING **TEMPORARY** TEMP. E.N. **EDGE NAIL** THICK(NESS) ENG. **ENGINEER** TOE NAIL EQ. EQUAL TOP OF ANTENNA EXP. **EXPANSION** T.O.C. TOP OF CURB EXST.(E) EXISTING TOP OF FOUNDATION **EXTERIOR** T.O.P. TOP OF PLATE (PARAPET) FAB. FABRICATION(OR) T.O.S. TOP OF STEEL F.F. FINISH FLOOR T.O.W. TOP OF WALL F.G. FINISH GRADE TYPICAL FINISH(ED) **UNDER GROUND** FLR. FLOOR UNDERWRITERS LABORATORY FDN. **FOUNDATION** U.N.O. **UNLESS NOTED OTHERWISE** F.O.C. FACE OF CONCRETE VERIFY IN FIELD F.O.M. FACE OF MASONRY WIDE (WIDTH) F.O.S. FACE OF STUD WITH F.O.W. FACE OF WALL WOOD F.S. FINISH SURFACE WEATHERPROOF FT.(') FOOT (FEET) WEIGHT **FOOTING** CENTERLINE **GROWTH (CABINET** PLATE, PROPERTY LINE GAUGE GALVANIZE(D) GROUND FAULT CIRCUIT INTERRUPTER GLUE LAMINATED BEAM GLB. (GLU-LAM) GLOBAL POSITIONING SYSTEM **GROUND** HEADER HDR. **HANGER** HGR. ISOLATED COPPER GROUND BUS SYMBOLS LEGEND **GROUT OR PLASTER** (E) BRICK BLDG. SECTION (E) MASONRY **WALL SECTION** CONCRETE EARTH GRAVEL **PLYWOOD** Sand **ELEVATION PLYWOOD** SAND (E) STEEL DOOR SYMBOL MATCH LINE WINDOW SYMBOL GROUND CONDUCTOR OVERHEAD SERVICE CONDUCTORS TILT-UP PANEL MARK TELEPHONE CONDUIT PROPERTY LINE POWER CONDUIT COAXIAL CABLE — ELEVATION DATUM CHAIN LINK FENCE **WOOD FENCE** GRID/COLUMN LINE (P) ANTENNA DIMENSION ITEM (P) RRU (P) DC SURGE SUPRESSION KEYNOTE, CONSTRUCTION ITEM (F) ANTENNA WALL TYPE MARK (F) RRU

OFFICE

ROOM NAME

ROOM NUMBER

(E) EQUIPMENT

Issued For:

CCL02143 ARCATA

FOSTER AVENUE ARCATA, CA 9552



San Ramon, California 94583

Vendor:



PROJECT NO: 14863296

AT&T SITE NO: CCL02143

PROJECT NO: 219.0105

DRAWN BY: TLS

CHECKED BY: SV

1			•
		09/08/21	100% ZD REV 1
		12/04/19	100% ZD
		11/18/19	90% ZD
	REV	DATE	DESCRIPTION

IT IS A VIOLATION OF LAW FOR ANY PERSON, UNLESS THEY ARE ACTING

UNDER THE DIRECTION OF A LICENSED PROFESSIONAL ENGINEER, TO ALTER THIS

DOCUMENT.

Architect:



MST ARCHITECTS


1520 River Park Drive
Sacramento, California 95815

GENERAL NOTES,
ABBREVIATIONS, &
LEGEND

SHEET NUMBER:

GN-1

Lease Area Description DATE OF SURVEY: 11-06-19 Geil Engineering BOUNDARY SHOWN IS BASED ON MONUMENTATION FOUND AND RECORD Engineering * Surveying * Planning INFORMATION. THIS IS NOT A BOUNDARY SURVEY. THIS IS A SPECIALIZED All that certain lease area being a portion of that certain parcel as is described in Grant Deed filed for record at SURVEYED BY OR UNDER DIRECTION OF: KENNETH D. GEIL, R.C.E. 14803 1226 High Street TOPOGRAPHIC MAP WITH PROPERTY LINES AND EASEMENTS BEING A Auburn, California 95603-5015 GRAPHIC DEPICTION BASED ON INFORMATION GATHERED FROM VARIOUS Document No. 1998-9211-3, Official Records of Humboldt Phone: (530) 885-0426 * Fax: (530) 823-1309 LOCATED IN THE COUNTY OF HUMBOLDT, STATE OF CALIFORNIA SOURCES OF RECORD AND AVAILABLE MONUMENTATION FOUND DURING THE PROJECT County, California; being a portion of Sections 20 and 29, FIELD SURVEY. NO EASEMENTS WERE RESEARCHED OR PLOTTED. PROPERTY Township 6 North, Range 1 East, Humboldt Meridan, County of A.T.& T. Mobility AREA BEARINGS SHOWN ARE BASED UPON MONUMENTS FOUND AND RECORD INFORMATION. THIS LINES AND LINES OF TITLE WERE NOT INVESTIGATED NOR SURVEYED. NO Humboldt, State of California and being more particularly IS NOT A BOUNDARY SURVEY. PROPERTY MONUMENTS WERE SET. described as follows: Project No./Name: CCL02143 / ARCATA ELEVATIONS SHOWN ON THIS PLAN ARE BASED UPON U.S.G.S. N.A.V.D. 88 DATUM. ABOVE Commencing at brass cap monument stamped SL #8 as is MEAN SEA LEVEL. Project Site Location: Foster Avenue shown on those certain Records of Survey filed for record at Arcata, CA 95521 THESE DRAWINGS AND/OR THE ACCOMPANYING SPECIFICATION AS Book 12 of Surveys at Page 13 (Referenced as Point #8) and N.G.V.D. 1929 CORRECTION: SUBTRACT XXX' FROM ELEVATIONS SHOWN. Humboldt County INSTRUMENTS OF SERVICE, ARE THE EXCLUSIVE PROPERTY OF GEIL Book 64 of Surveys at Page 111 (Referenced as Point #14), ENGINEERING AND THEIR USE AND PUBLICATION SHALL BE RESTRICTED TO from which a similar monument bears South xxx feet; thence CONTOUR INTERVAL: n.a. Date of Observation: 11-06-19 THE ORIGINAL SITE AND CARRIER FOR WHICH THEY ARE PREPARED. REUSE, GEIL ENGINEERING
INGINEERING * SURVEYING * PLANNING
1226 HIGH STREET
AUBURN, CALIFORNIA 95603
phone: (530) 885-0426
fax: (530) 823-1309 from said point of commencement North 71°22'30" East 65.82 SAMOA BLVD. REPRODUCTION OR PUBLICATION BY ANY METHOD, IN WHOLE OR IN PART, IS feet to the True Point of Beginning; thence from said True Point of Beginning South 70°05'57" East 45.00 feet; thence CONTRACTOR IS RESPONSIBLE TO VERIFY LEASE AREA PRIOR TO CONSTRUCTION. Equipment/Procedure Used to Obtain Coordinates: Trimble Pathfinder PROHIBITED EXCEPT BY WRITTEN PERMISSION FROM GEIL ENGINEERING TITLE Pro XL post processed with Pathfinder Office software. TO THESE PLANS AND/OR SPECIFICATIONS SHALL REMAIN WITH GEIL ASSESSOR'S PARCEL NUMBER: 505-151-006-000 South 19.54.03" West 40.00 feet; thence North 70.05.57" ENGINEERING WITHOUT PREJUDICE AND VISUAL CONTACT WITH THEM SHALL Type of Antenna Mount: Proposed Monopine West 45.00 feet; thence North 19.54.03" East 20.00 feet to a CONSTITUTE PRIMA FACIE EVIDENCE OF ACCEPTANCE OF THESE OWNER(S): SHIRLEY BUTLER TRUST point hereafter referred to as Point A; thence continuing RESTRICTIONS. Coordinates (Center Lease Area) North 19'54'03" East 20.00 feet to the point of beginning. Latitude: N 40° 52' 52.55" (NAD83) N 40° 52' 53.09" (NAD27) ARCATA, CA VICINITY MAP Longitude: W 124° 06' 00.74" (NAD83) W 124° 06' 56.51" (NAD27) Together with a non-exclusive easement for access and utility purposes twenty feet in width the centerline of which is described as follows: beginning at a the above described ELEVATION of Ground at Structure (NAVD88) 24.5' AMSL Point "A"; thence from said point of beginning North 70°05'57" West 4.23 feet; thence along a curve to the left CERTIFICATION: I, the undersigned, do hereby certify elevation listed above is based on a field survey done under my supervision and that having a radius of 25.0 feet and a chord of South 77°27'33" the accuracy of those elevations meet or exceed 1—A Standards as West 26.82 feet; thence South 45°01'03" West 7.30 more or defined in the FAA ASAC Information Sheet 91:003, and that they are less to the public right of way. true and accurate to the best of my knowledge and belief. Also together with a non-exclusive easement for access and utility purposes, over and across the Westerly 10.0 feet of the aforementioned parcel of land. Kenneth D. Geil California RCE 14803 APN: 505-151-003-000 [']EL:26.21' EL:25.03' PROPOSED 10.0' NON— EXCLUSIVE ACCESS & UTILITY EASEMENT + EL:25,25′ TOP=62. EL:24.99' TOP=72.0' APN: 505-151-004-000 APN: 505-151-006-000 COORDINATE POINT APN: 505-151-001-000 PROPOSED 10.00 NON— EXCLUSIVE ACCESS & UTILITY EASEMENT EL:24.79' PROPOSED A.T.& T. MOBILITY LEASE AREA TELCO. POLE PROPOSED 20.0' NON-EXCLUSIVE ACCESS & UTILITY EASEMENT + EL:24.50' 40' RR R/W SEE PROJECT/AREA ENLARGEMEN/ (APN: 505-151-005-000) TOP=69.5 ✓ APN: 505−151−005−000 TOP=62.5 TELCO. POLE-___ SCALE 1" = 20OVERALL SITE PLAN PROJECT AREA ENLARGEMENT SCALE 1" = 100'

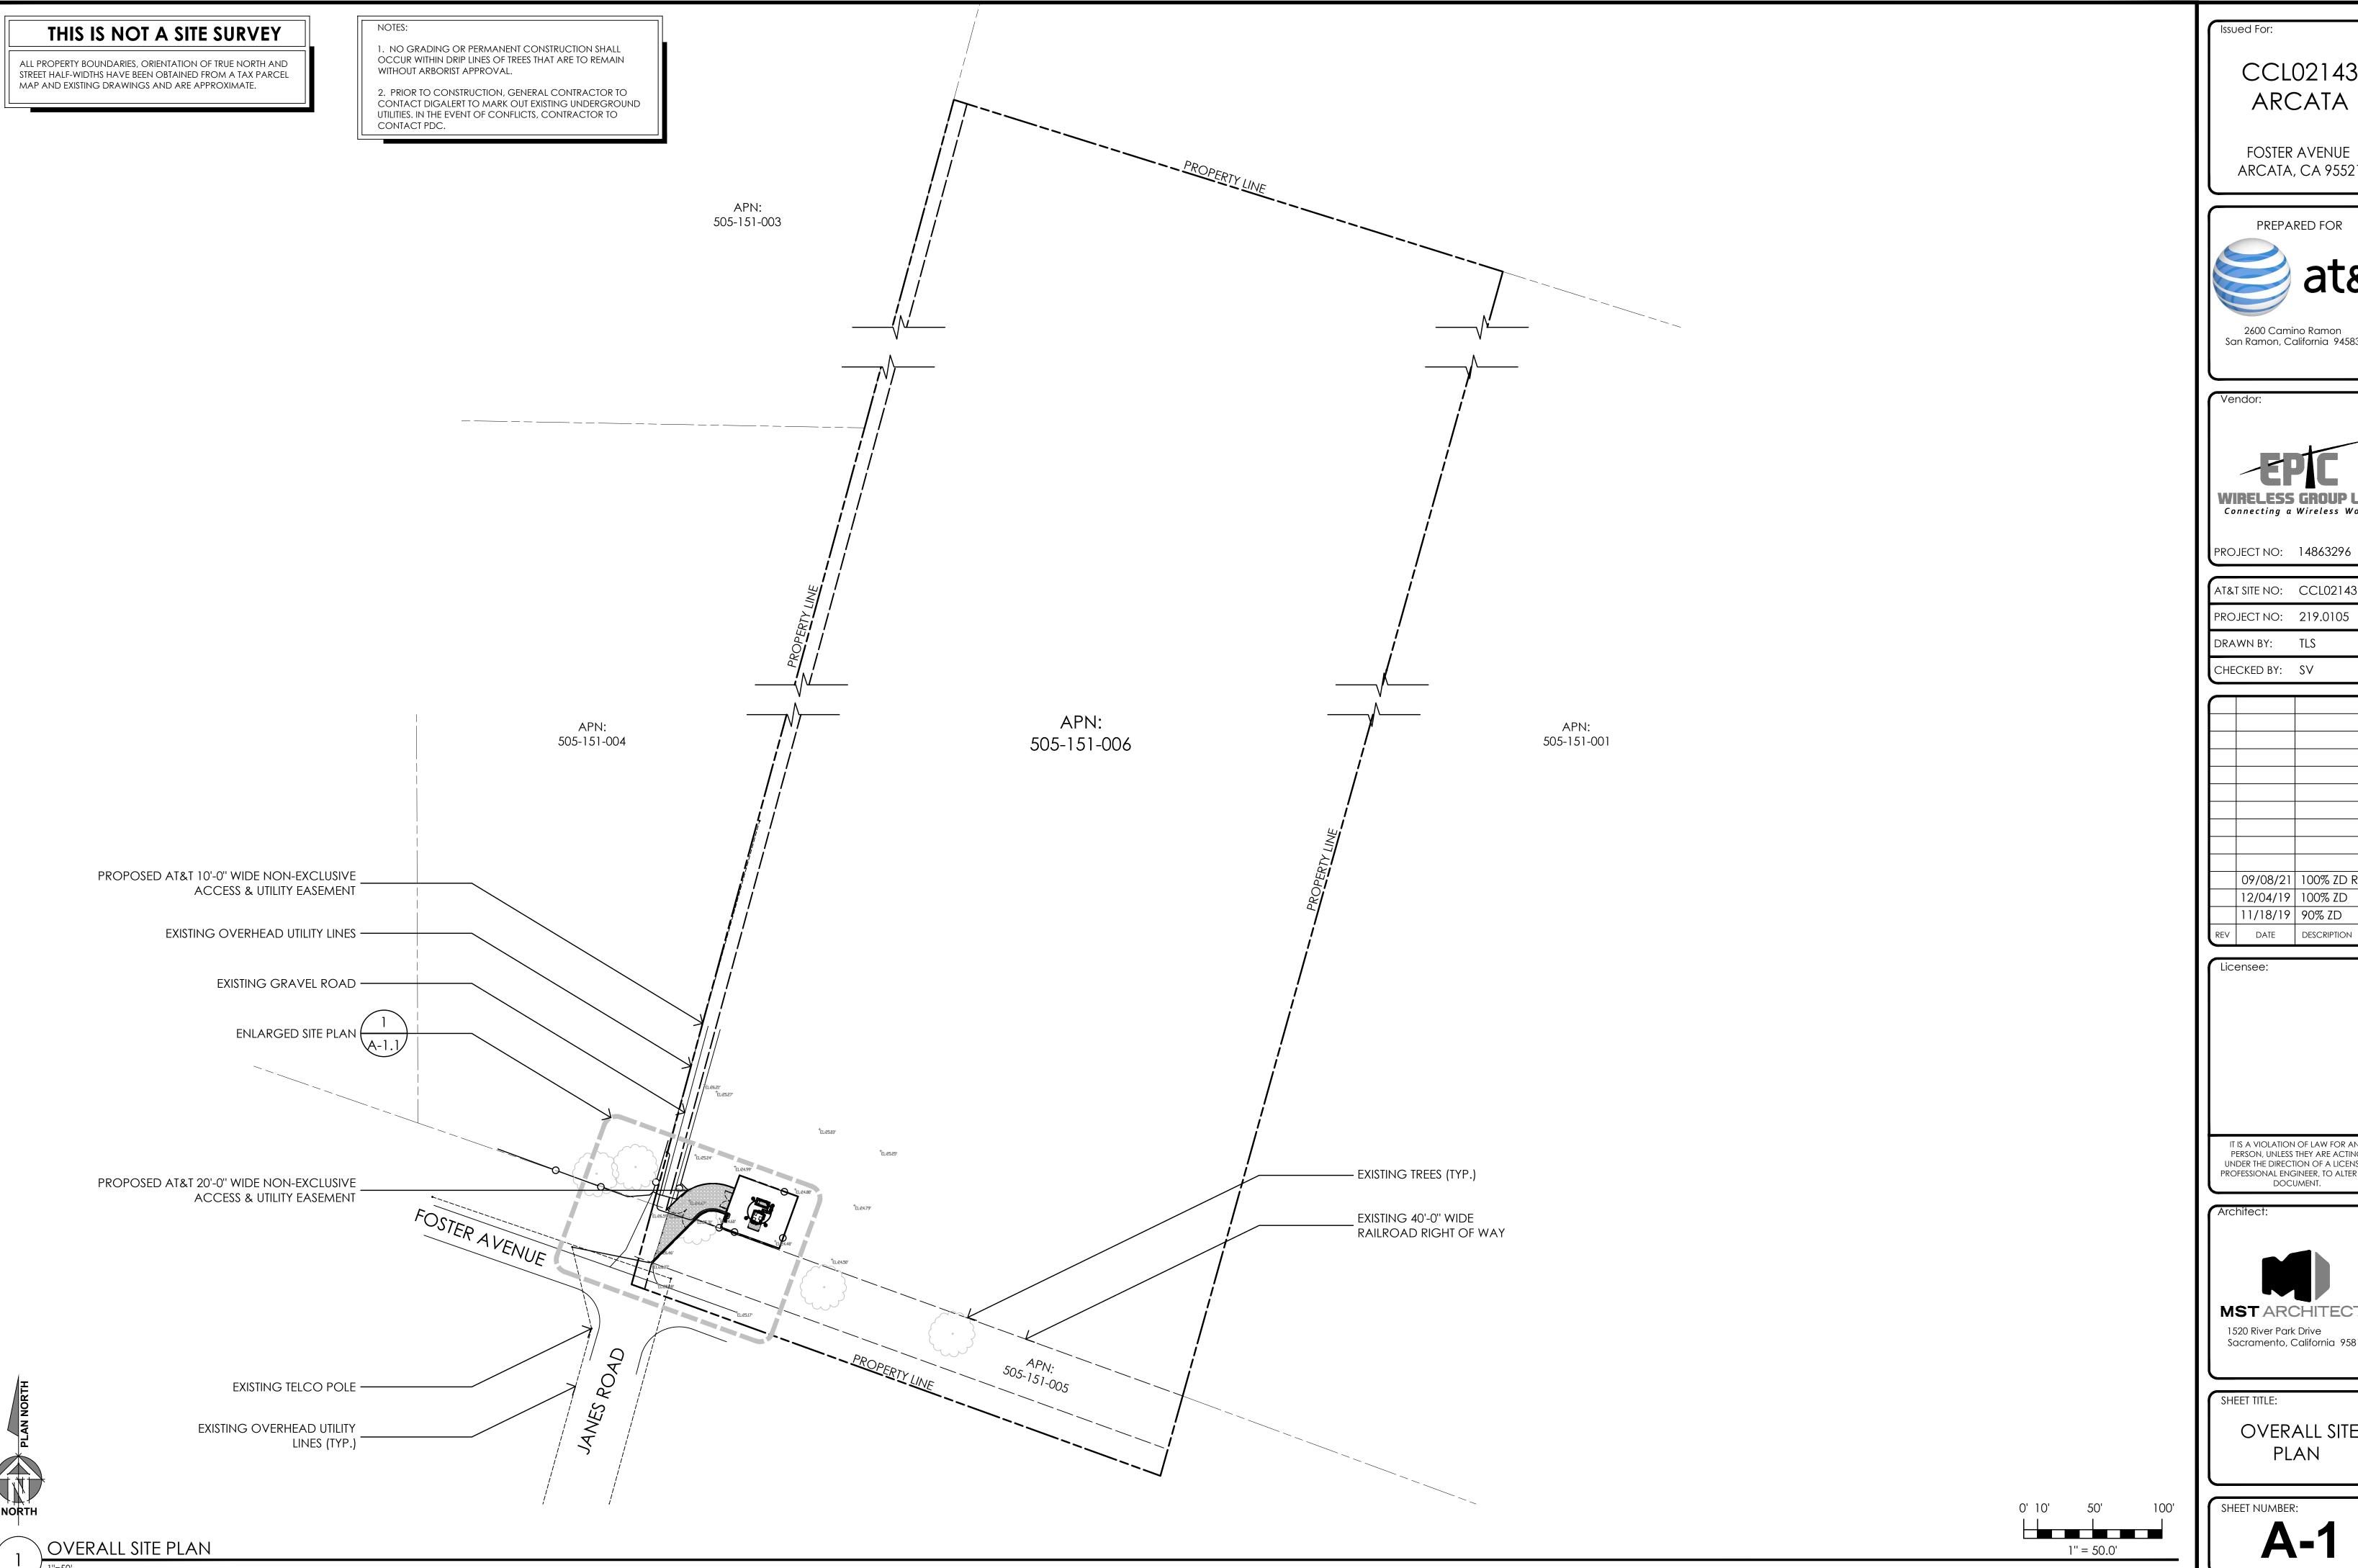

Issued For:

CCL02143 ARCATA

FOSTER AVENUE ARCATA, CA 95521



2600 Camino Ramon San Ramon, California 94583



PROJECT NO: 14863296

AT&T SITE NO: CCL02143

PROJECT NO: 219.0105 DRAWN BY: TLS

CHECKED BY: SV

09/08/21 100% ZD REV 12/04/19 100% ZD 11/18/19 90% ZD

Licensee:

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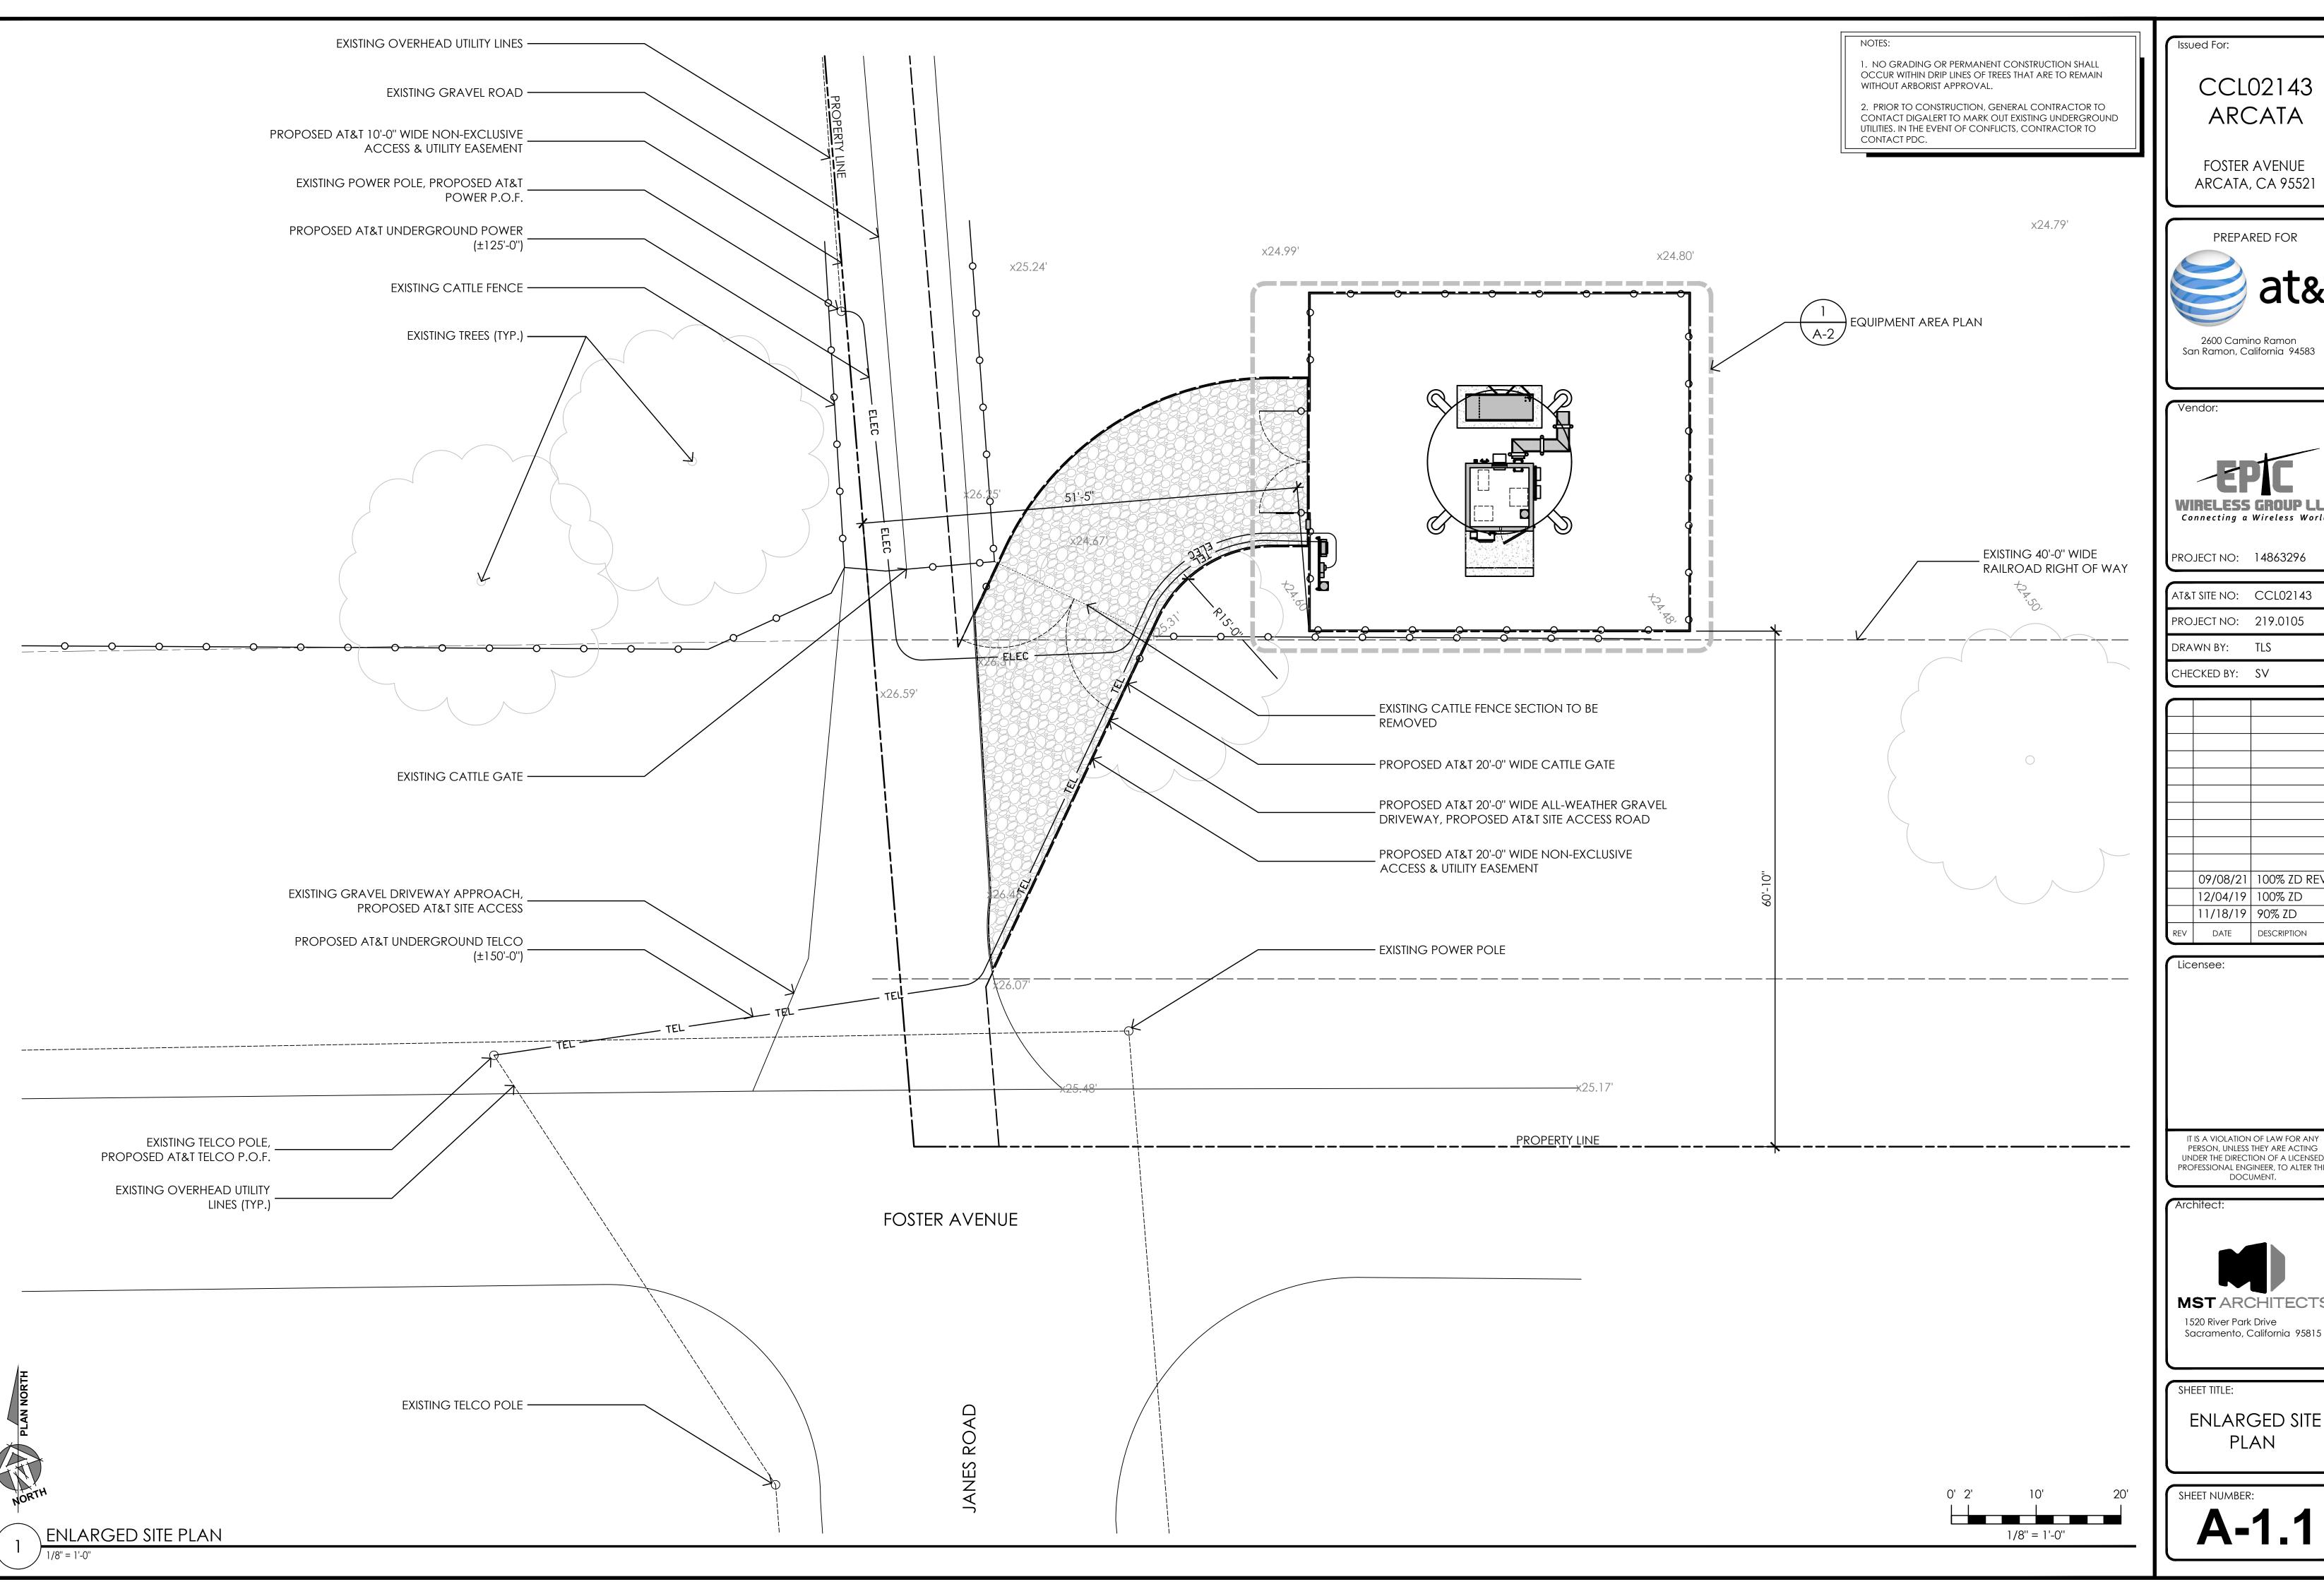
MST ARCHITECTS 1520 River Park Drive Sacramento, California 95815

SHEET TITLE:

OVERALL SITE PLAN

SHEET NUMBER:





Issued For:

CCL02143 ARCATA

FOSTER AVENUE ARCATA, CA 95521





PROJECT NO: 14863296

AT&T SITE NO: CCL02143 PROJECT NO: 219.0105

CHECKED BY: SV

	09/08/21	100% ZD REV 1
	12/04/19	100% ZD
	11/18/19	90% ZD
REV	DATE	DESCRIPTION

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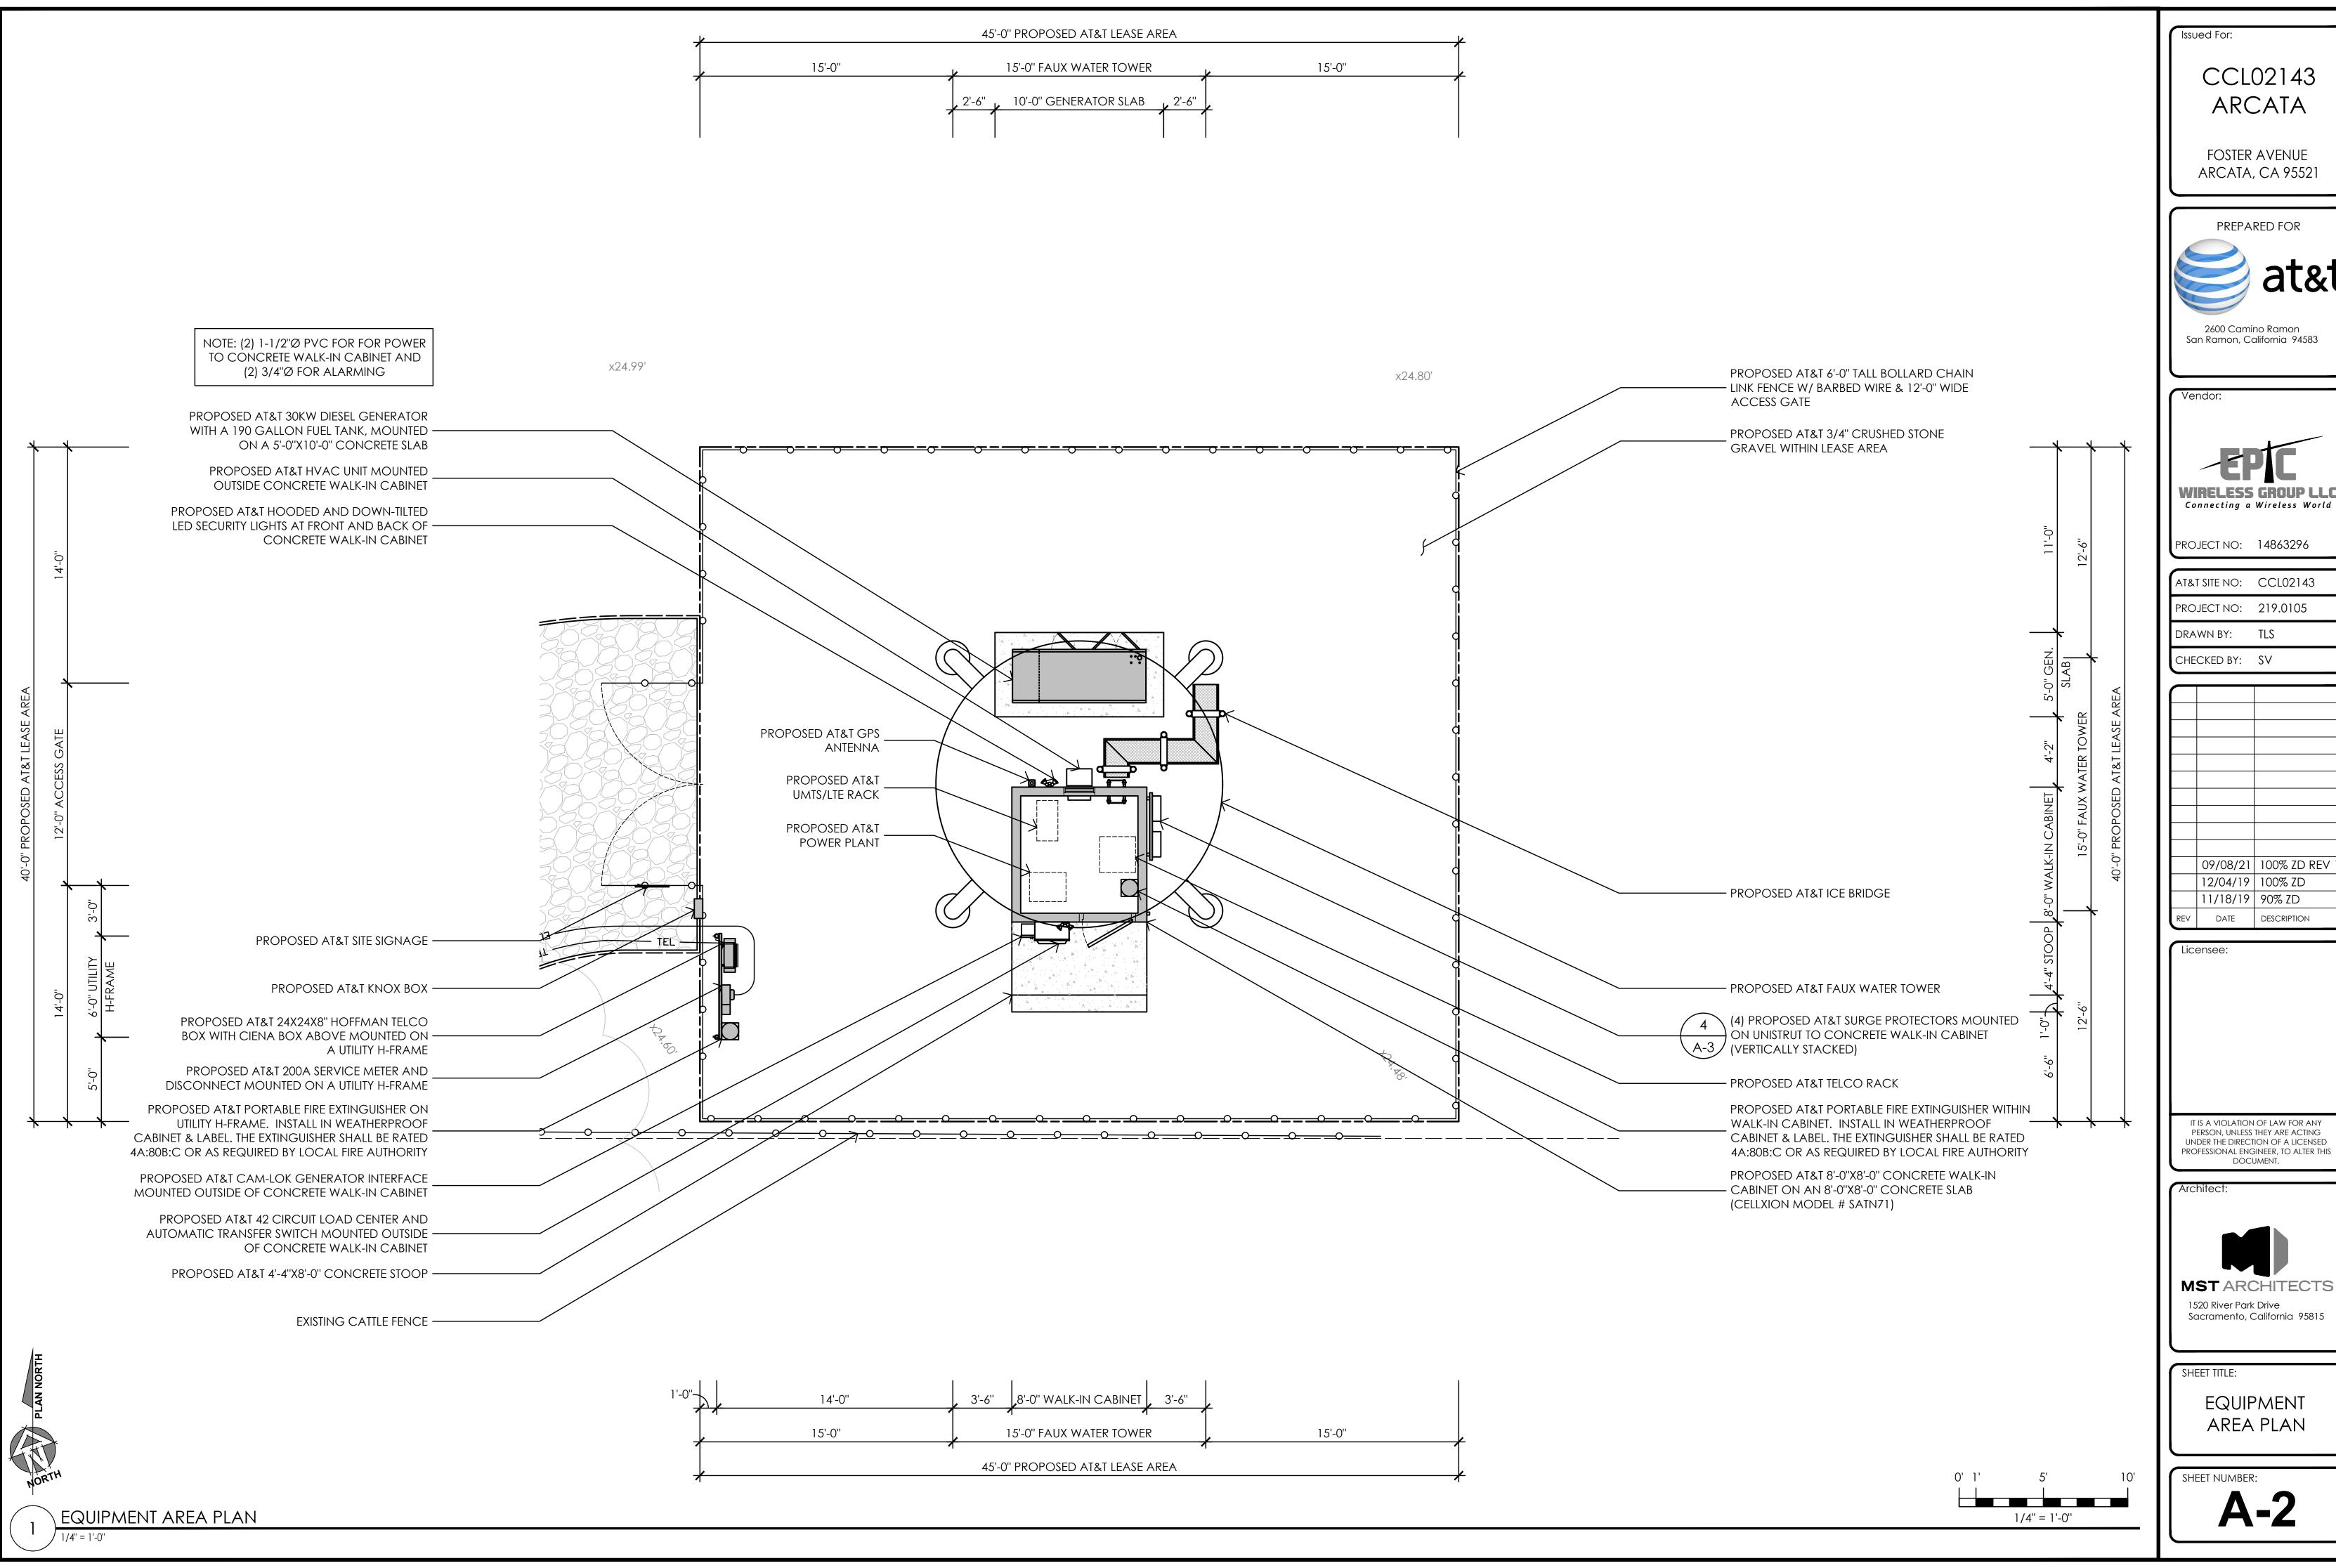


MST ARCHITECTS 1520 River Park Drive Sacramento, California 95815

SHEET TITLE:

ENLARGED SITE PLAN


SHEET NUMBER:



FOSTER AVENUE




AT&T SITE NO: CCL02143

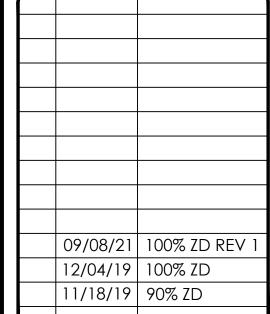


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DC SURGE SUPPRESSION (SQUID)

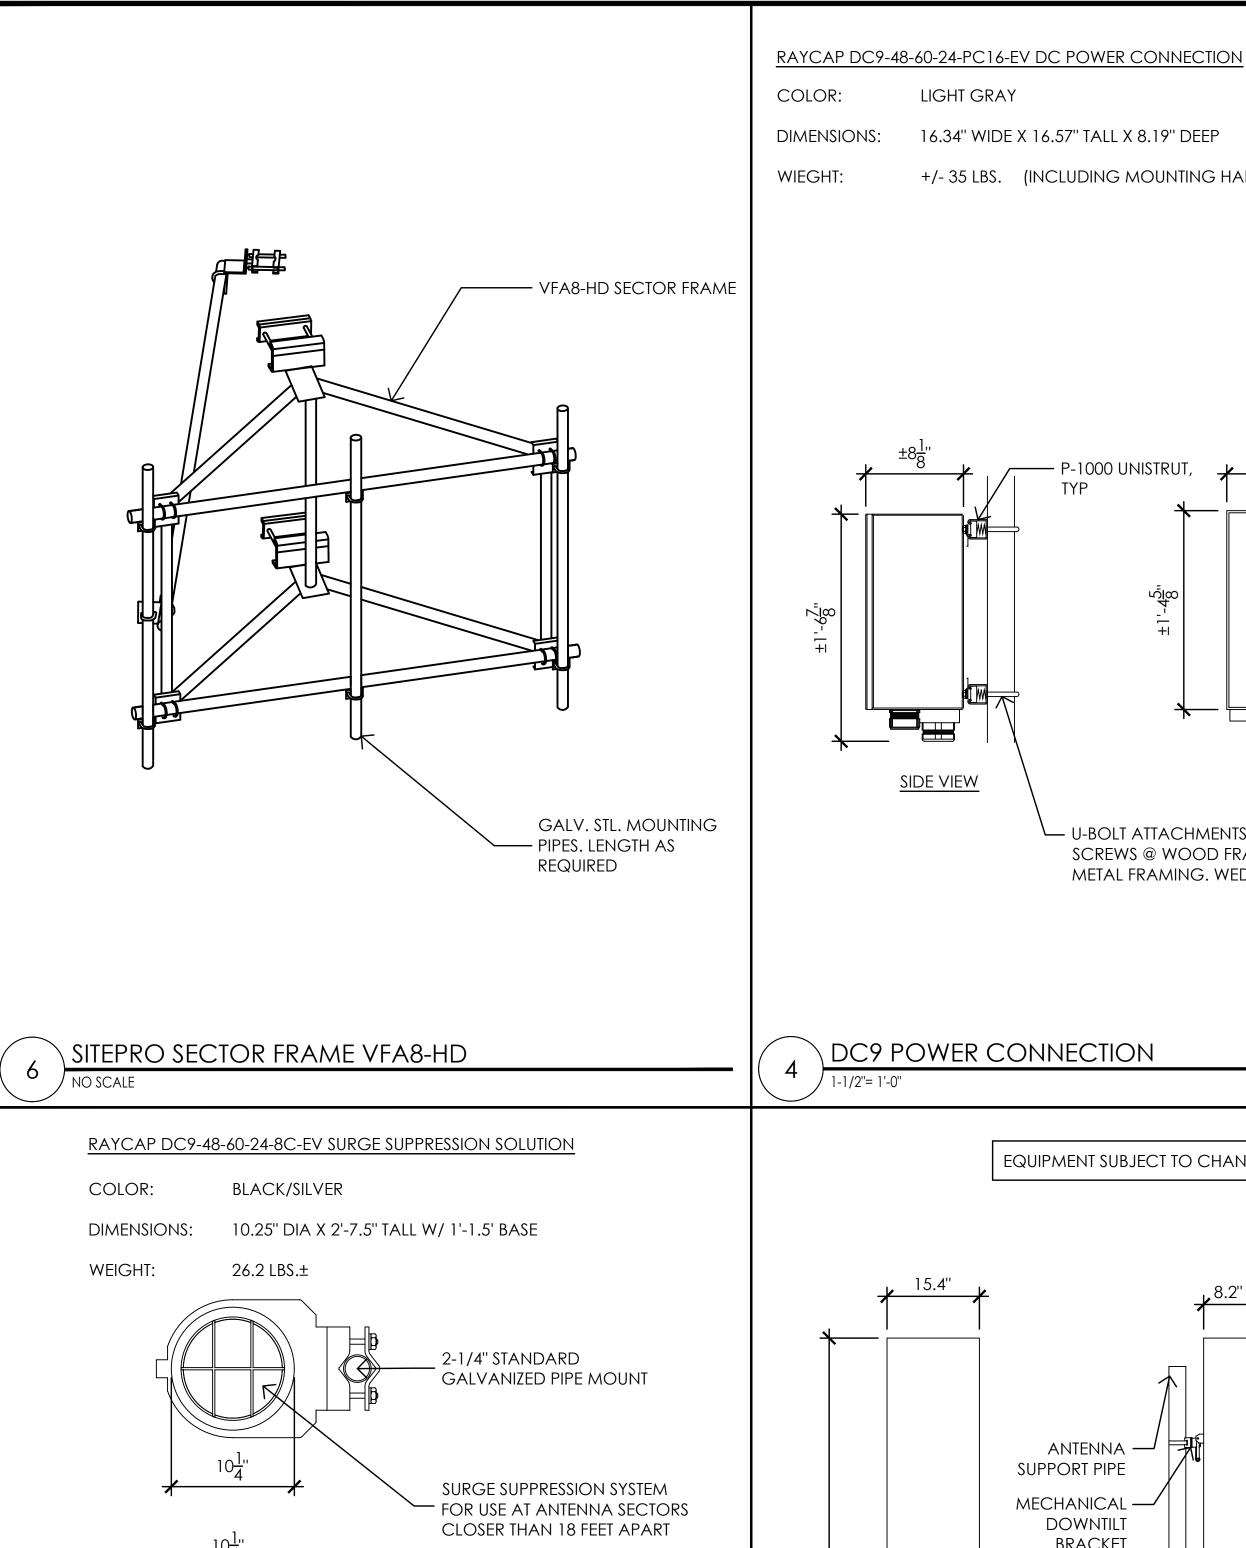

3/4" = 1'-0"

LIGHT GRAY

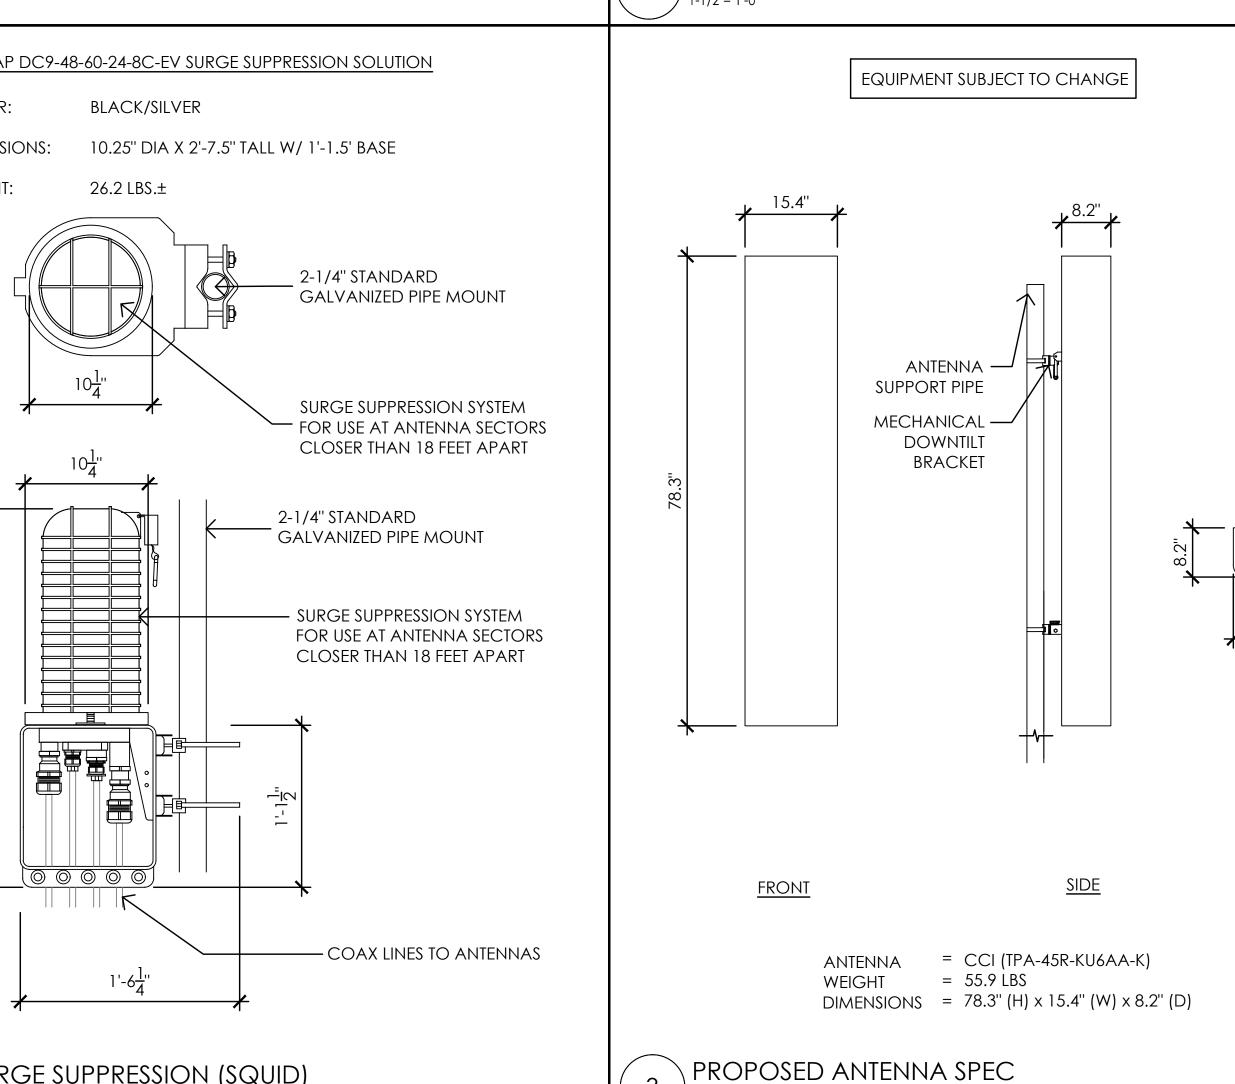SIDE VIEW

16.34" WIDE X 16.57" TALL X 8.19" DEEP

+/- 35 LBS. (INCLUDING MOUNTING HARDWARE)

— P-1000 UNISTRUT,

ر√[∞

FRONT VIEW

15.4"

<u>PLAN</u>


ANTENNA LAYOUT PLAN


U-BOLT ATTACHMENTS @ PIPE MOUNTS. LAG

SCREWS @ WOOD FRAMING. MACH BOLTS @

METAL FRAMING. WEDGE ANCHORS @ CONC.

TYP

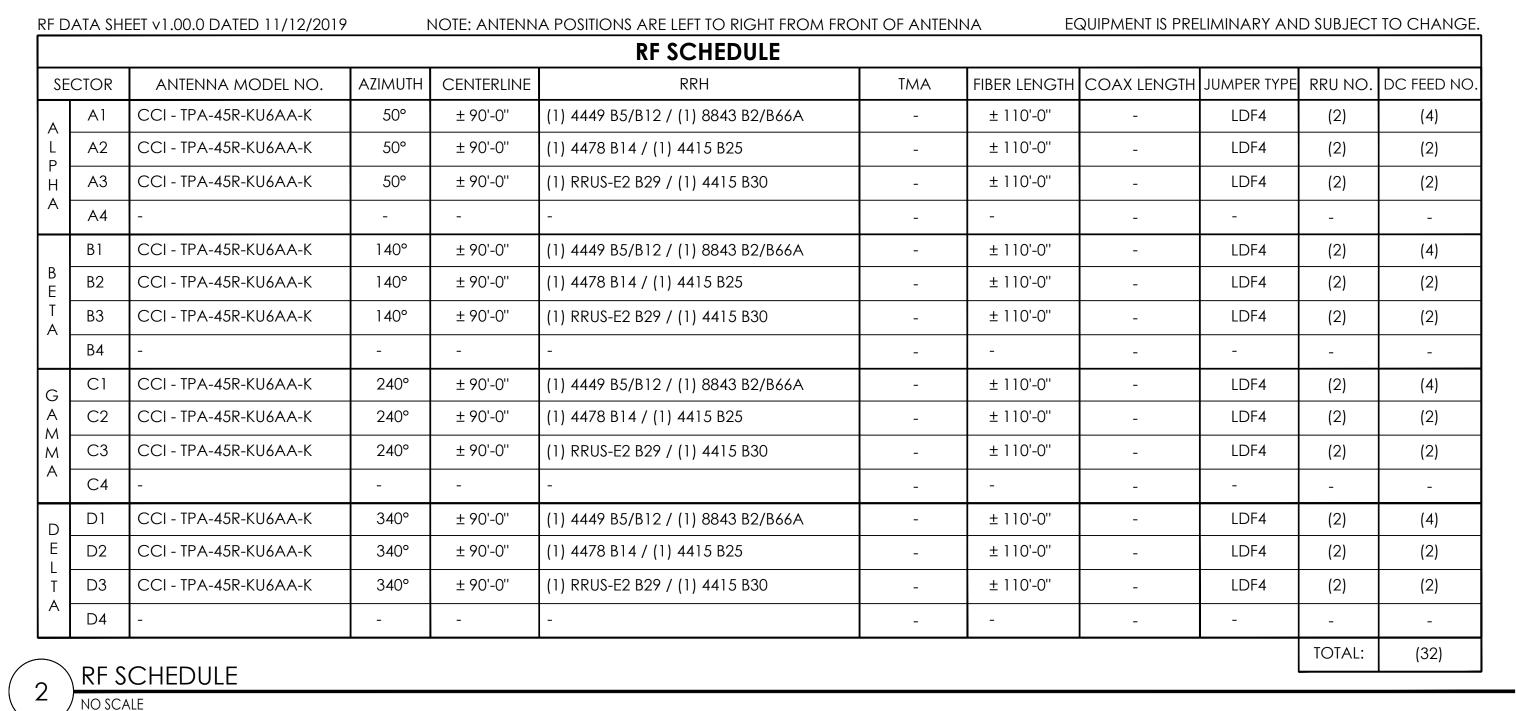

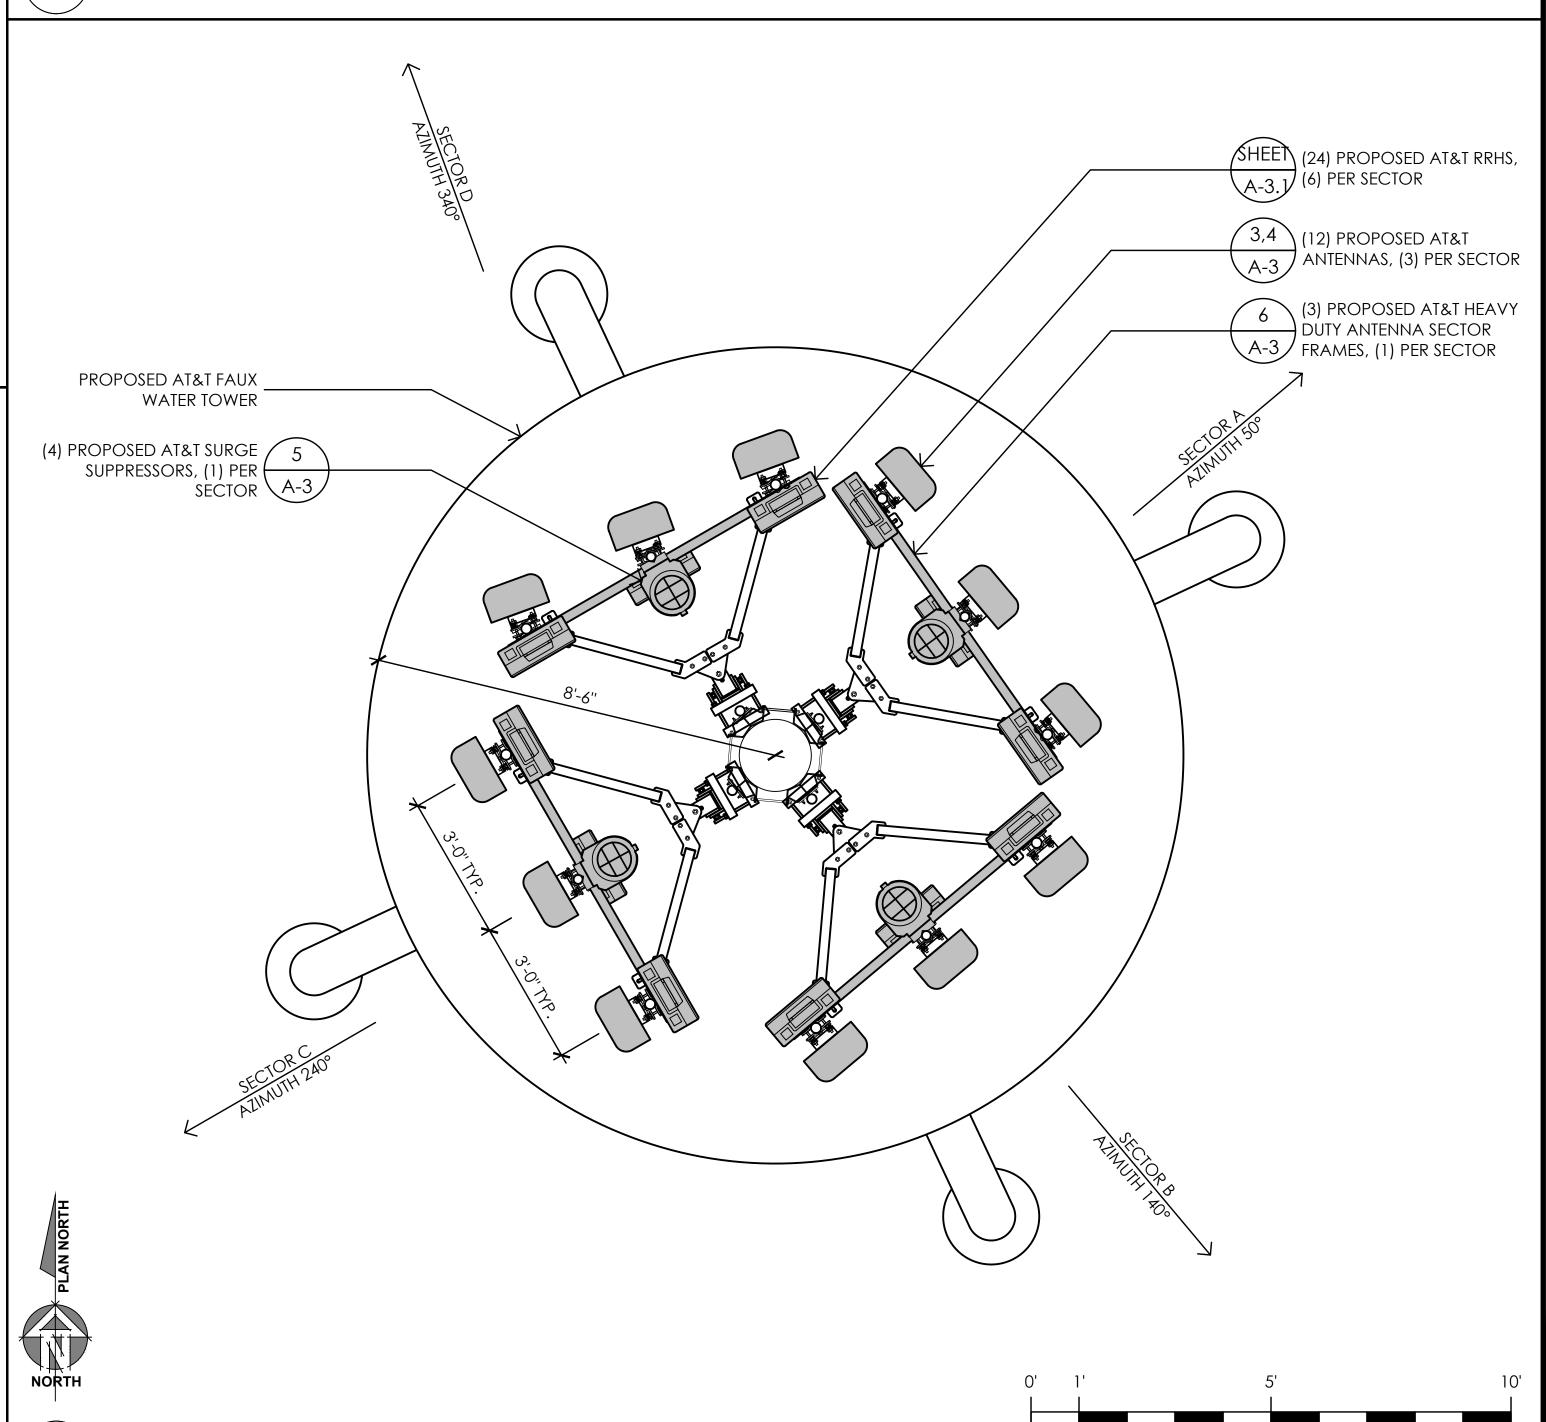

Issued For: CCL02143

ARCATA FOSTER AVENUE

ARCATA, CA 95521



2600 Camino Ramon

San Ramon, California 94583

Vendor:



PROJECT NO: 14863296

AT&T SITE NO: CCL02143 PROJECT NO: 219.0105 DRAWN BY: TLS CHECKED BY: SV

09/08/21 100% ZD REV 12/04/19 100% ZD 11/18/19 90% ZD REV DATE DESCRIPTION

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1520 River Park Drive Sacramento, California 95815

SHEET TITLE: ANTENNA PLAN SCHEDULE, & **DETAILS**

1/2" = 1'-0"

