

FRESHWATER ROAD

250 MISTY HILL LANE, EUREKA, CA 95503 SITE ID: TBD

VICINITY MAP

PROJECT DESCRIPTION

A (N) TOWERCO UNMANNED TELECOMMUNICATION FACILITY CONSISTING OF INSTALLING:

- (N) TOWERCO LEASE AREA W/ (N) VERIZON WIRELESS LEASE AREA INSIDE W/ (N) GROUND MOUNTED EQUIPMENT & DIESEL GENERATOR & (N) UTILITIES TO (N) SITE LOCATION
- (N) TOWERCO MONOPOLE W/ (N) VERIZON WIRELESS ANTENNAS, & ANTENNA EQUIPMENT
- (E) TREES WITHIN LEASE AREA TO BE REMOVED OR TRIMMED AS NEEDED

5000 VALLEYSTONE DRIVE

CARY, NC 27519

PROJECT INFORMATION SITE NAME: VERIZON WIRELESS FRESHWATER ROAD APPLICANT: 2770 SHADELANDS DRIVE, BUILDING 11 VZW MDG LOCATION ID: 5000920338 WALNUT CREEK, CA 94598 SITE ACQUISITION COMPANY: COMPLETE WIRELESS CONSULTING VZW PROJECT ID: 17314976 2009 V STREET SACRAMENTO, CA 95818 HUMBOLDT COUNTY: LEASING CONTACT: ATTN: ROCKY CORDOVA JURISDICTION: HUMBOLDT COUNTY (916) 616-0468 RCORDOVA@COMPLETEWIRELESS.NET 403-081-013 ATTN: STEVE PROO ZONING CONTACT: SITE ADDRESS: 250 MISTY HILL LANE (916) 838-6713 EUREKA, CA 95503 SPROO@COMPLETEWIRELESS.NET **CURRENT ZONING:** RS-B5 - RESIDENTIAL SUBURBAN/ CONSTRUCTION CONTACT: SEAN WALLIN BUILDING SITE COMBINED (916) 591-8574 SWALLIN@COMPLETEWIRELESS.NET CONSTRUCTION TYPE: V-B OCCUPANCY TYPE: U, (UNMANNED COMMUNICATIONS FACILITY) POWER: N 40° 46' 14.74" NAD 83 LATITUDE: N 40.770762° NAD 83 W 124° 05' 18.32" NAD 83 LONGITUDE: W 124.088421° NAD 83 GROUND ELEVATION: 456'AMSL PROPERTY OWNER: RONALD & SARA BIASCA, 2023 TRUST 250 MISTY HILL LANE EUREKA, CA 95503 mTOWER OWNER:

Ryan Slough Myrite Avenue Blue Lake Garbage Rose Burns Doula Rose Burns Doula Redwood Acres Raceway Farias Construction Masterson woodcraft SITE LOCATION SITE LOCATION

Mitchell Grove

CODE COMPLIANCE

ALL WORK & MATERIALS SHALL BE PERFORMED & INSTALLED IN ACCORDANCE WITH THE CURRENT EDITIONS OF THE FOLLOWING CODES AS ADOPTED BY THE LOCAL GOVERNING AUTHORITIES. NOTHING IN THESE PLANS IS TO BE CONSTRUED TO PERMIT WORK NOT CONFORMING TO THESE CODES:

2022 CALIFORNIA ADMINISTRATIVE CODE, PART 1, TITLE 24 C.C.R.

2022 CALIFORNIA BUILDING CODE (CBC), PART 2, VOLUME 1&2, TITLE 24 C.C.R. (2021 INTERNATIONAL BUILDING CODE AND 2022 CALIFORNIA AMENDMENTS)

2022 CALIFORNIA ELECTRICAL CODE (CEC), PART 3, TITLE 24 C.C.R.

(2020 NATIONAL ELECTRICAL CODE AND 2022 CALIFORNIA AMENDMENTS)

2022 CALIFORNIA MECHANICAL CODE (CMC) PART 4, TITLE 24 C.C.R.

(2021 UNIFORM MECHANICAL CODE AND 2022 CALIFORNIA AMENDMENTS)

2022 CALIFORNIA PLUMBING CODE (CPC), PART 5, TITLE 24 C.C.R.

(2021 UNIFORM PLUMBING CODE AND 2022 CALIFORNIA AMENDMENTS) 2022 CALIFORNIA ENERGY CODE (CEC), PART 6, TITLE 24 C.C.R.

2022 CALIFORNIA FIRE CODE, PART 9, TITLE 24 C.C.R.

(2021 INTERNATIONAL FIRE CODE AND 2022 CALIFORNIA AMENDMENTS)

2022 CALIFORNIA GREEN BUILDING STANDARDS CODE, PART 11, TITLE 24 C.C.R. 2022 CALIFORNIA REFERENCED STANDARDS, PART 12, TITLE 24 C.C.R.

ANSI/EIA-TIA-222-H

ALONG WITH ANY OTHER APPLICABLE LOCAL & STATE LAWS AND REGULATIONS

DISABLED ACCESS REQUIREMENTS

THIS FACILITY IS UNMANNED & NOT FOR HUMAN HABITATION. DISABLED ACCESS & REQUIREMENTS ARE NOT REQUIRED IN ACCORDANCE WITH CALIFORNIA STATE BUILDING CODE, TITLE 24 PART 2, SECTION 11B-203.5

SHEET INDEX

SHEET	DESCRIPTION	REV
T-1.1	TITLE SHEET	1
C-1	TOPOGRAPHIC SURVEY	_
C-2	TOPOGRAPHIC SURVEY	_
A-1.1	OVERALL SITE PLAN	1
A-1.2	ENLARGED SITE PLAN	1
A - 1.3	EQUIPMENT PLAN	1
$\left(\begin{array}{c} 4 \\ \hline \end{array} \right)$	FIRE PLAN	1}
A-2.1	ANTENNA PLAN	
A - 3.1	ELEVATIONS	1
A-4.1	DETAILS	_
E-1.1	ELECTRICAL PLAN	_

Issued For

FRESHWATER ROAD

250 MISTY HILL LANE EUREKA, CA 95503







MDG LOCATION ID: 5000920338

PROJECT ID: 17314976

DRAWN BY: SEAD

CHECKED BY: N. GEORGE

APPROVED BY: -


	ISSUE STATUS						
\triangle	03/05/25	CLIENT REV	S.D.				
4	08/19/24	CLIENT REV	T.T.				
3	07/25/24	CLIENT REV	T.T.				
2	07/03/24	ZD 100%	T.T.				
1	06/13/24	CLIENT REV	S.D.				
0	06/06/24	ZD 90%	-				
REV	DATE	DESCRIPTION	CAD				

Licensee:

PRELIMINARY:
NOT FOR
CONSTRUCTION

KEVIN R. SORENSEN S4469

IT IS A VIOLATION OF LAW FOR ANY PERSON, UNLESS THEY ARE ACTING UNDER THE DIRECTION OF A LICENSED PROFESSIONAL ENGINEER, TO ALTER THIS DOCUMENT.

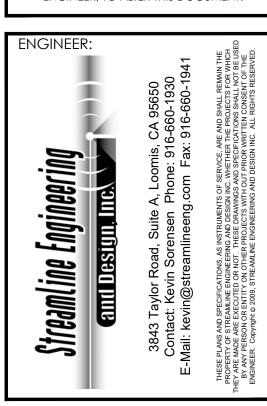

SHEET TITLE:

TITLE SHEET

THESE DRAWINGS AND/OR THE ACCOMPANYING SPECIFICATION AS INSTRUMENTS OF SERVICE, ARE THE DATE OF SURVEY: 05-22-24 EXCLUSIVE PROPERTY OF GEIL ENGINEERING AND THEIR USE AND PUBLICATION SHALL BE RESTRICTED TO THE ORIGINAL SITE AND CARRIER FOR WHICH THEY ARE PREPARED. REUSE, REPRODUCTION OR SURVEYED BY OR UNDER DIRECTION OF: KENNETH D. GEIL, R.C.E. 14803 PUBLICATION BY ANY METHOD, IN WHOLE OR IN PART, IS PROHIBITED EXCEPT BY WRITTEN PERMISSION FROM GEIL ENGINEERING. TITLE TO THESE PLANS AND/OR SPECIFICATIONS SHALL REMAIN WITH GEIL LOCATED IN THE COUNTY OF HUMBOLDT, STATE OF CALIFORNIA ENGINEERING WITHOUT PREJUDICE AND VISUAL CONTACT WITH THEM SHALL CONSTITUTE PRIMA FACIE EVIDENCE OF ACCEPTANCE OF THESE RESTRICTIONS. BEARINGS SHOWN ARE BASED UPON MONUMENTS FOUND AND RECORD INFORMATION. THIS IS NOT A BOUNDARY SURVEY. BOUNDARY SHOWN IS BASED ON MONUMENTATION FOUND AND RECORD INFORMATION. THIS IS NOT A ELEVATIONS SHOWN ON THIS PLAN ARE BASED UPON U.S.G.S. N.A.V.D. 88 BOUNDARY SURVEY. THIS IS A SPECIALIZED TOPOGRAPHIC MAP WITH PROPERTY LINES AND EASEMENTS BEING A GRAPHIC DEPICTION BASED ON INFORMATION GATHERED FROM VARIOUS SOURCES OF RECORD AND DATUM. ABOVE MEAN SEA LEVEL. AVAILABLE MONUMENTATION FOUND DURING THE FIELD SURVEY. NO EASEMENTS WERE RESEARCHED OR F.E.M.A. F.I.R.M. ZONE "X" PER FIRM 06023C0865G DATED 06/21/2017 PLOTTED. PROPERTY LINES AND LINES OF TITLE WERE NOT INVESTIGATED NOR SURVEYED. NO PROPERTY MONUMENTS WERE SET. N.G.V.D. 1929 CORRECTION: SUBTRACT 3.34' FROM ELEVATIONS SHOWN. PROJECT ENGINEERING


G * SURVEYING * PLANNIN


E6 HIGH STREET

N, CALIFORNIA 95603

(e: (530) 885-0426

(530) 823-1309 **AREA** CONTOUR INTERVAL: 1 FT. PIGEON PT RD CONTRACTOR IS RESPONSIBLE TO VERIFY LEASE AREA PRIOR TO CONSTRUCTION. ASSESSOR'S PARCEL NUMBER: 403-081-013 OWNER(S): RONALD & SARA BIASCA, 2023 TRUST 250 MISTY HILL ROAD EUREKA, CA 95503 VICINITY MAP EUREKA, CA _END OF COUNTY RD. CO.RD. #4K140 APN 403-043-057 APN 403-043-047 PARCEL B PER 13/PM/36, ESMT. FOR-INGRESS, EGREŚS, PUBLIC UTILITIES APN 403-043-039 PARCEL A PER 13/PM/36, ESMT. FOR INGRESS, EGRESS, PUBLIC UTILITIES 50.0' INGRESS, EGRESS & PUBLIC — UTILITES RIGHT OF WAY PER 16/PM/89 APN 403-043-040 APN 403-081-012 20' R/W PER 1635/114,~ 1633/1098, 1635/798 APN 403-081-014 APN 403-043-051 APN 403-043-049 TRILLIUM LN. (NON-COUNTY RD) 9 9 9 9 9 10' R/W PER 897/435,/ 1635/798 APN 403-081-016 APN 403-081-015 APN 403-043-055 APN 403-081-01350.0' ESMT. FOR INGRESS, EGRESS, PUBLIC _/ UTILITIES PER 1574/429 SEE SHEET C-2 RN 403-043-042 FOR DETAIL APN 403-081-023 SCALE 1" = 100'OVERALL PROJECT AREA

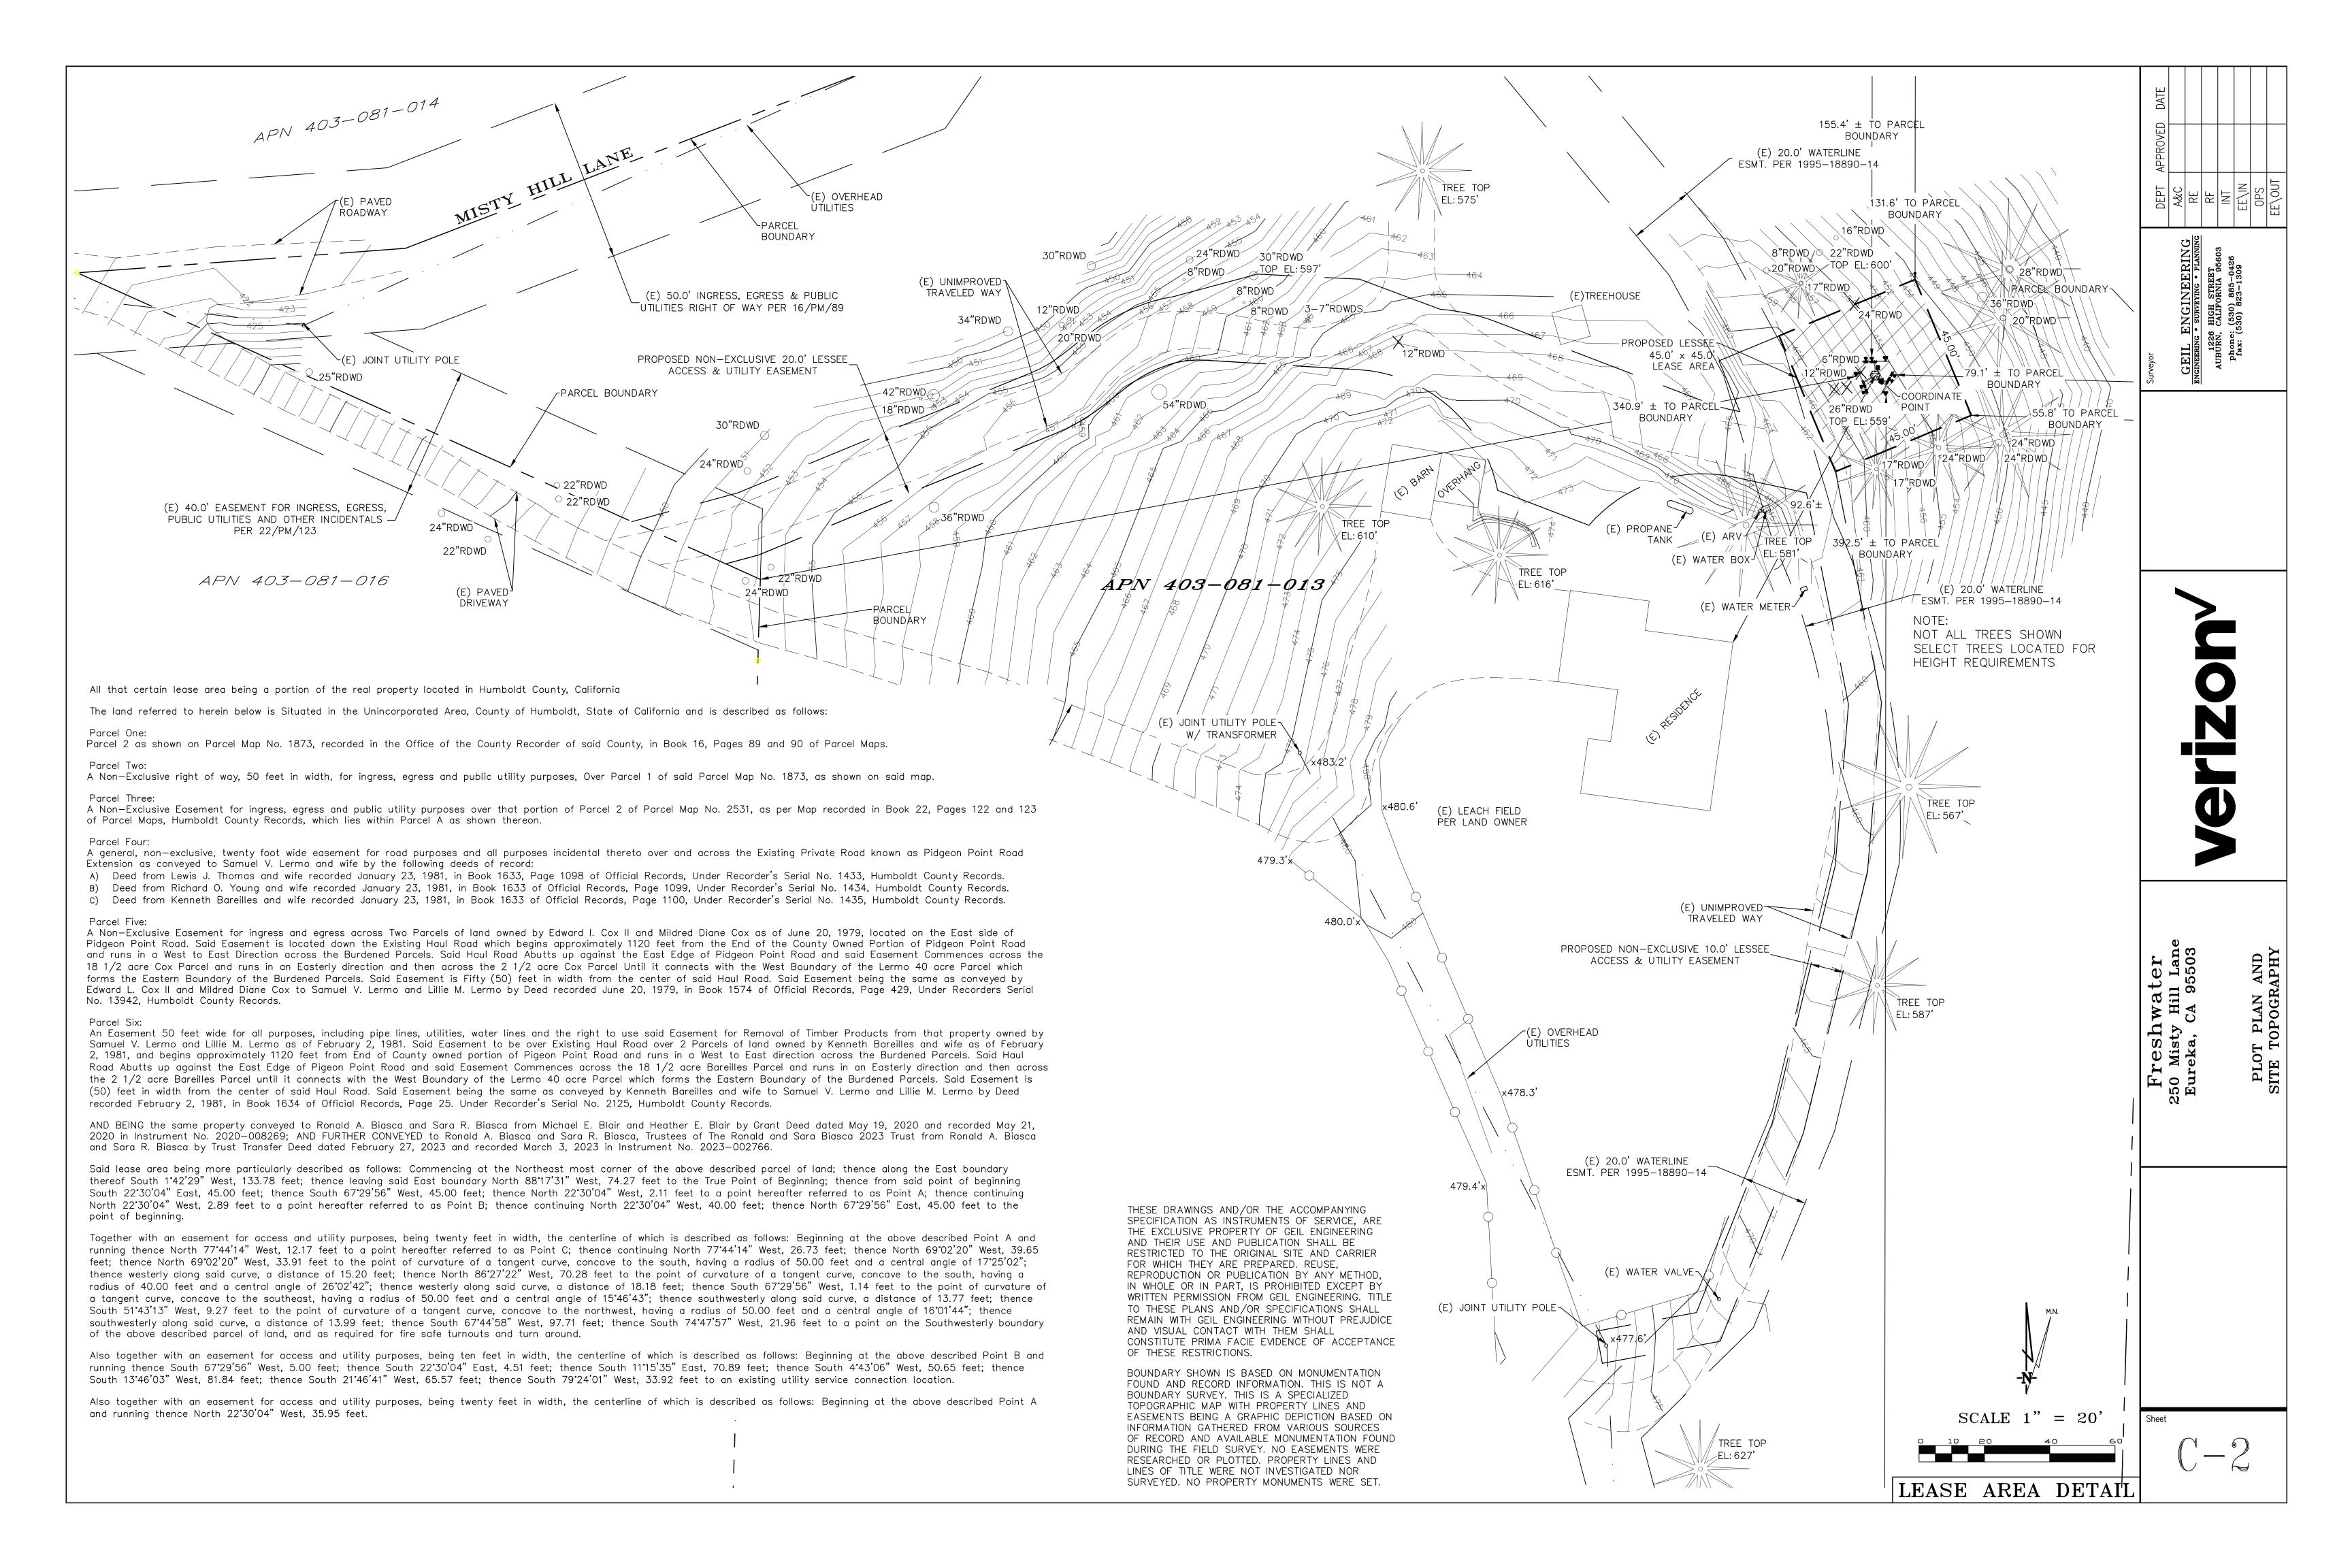

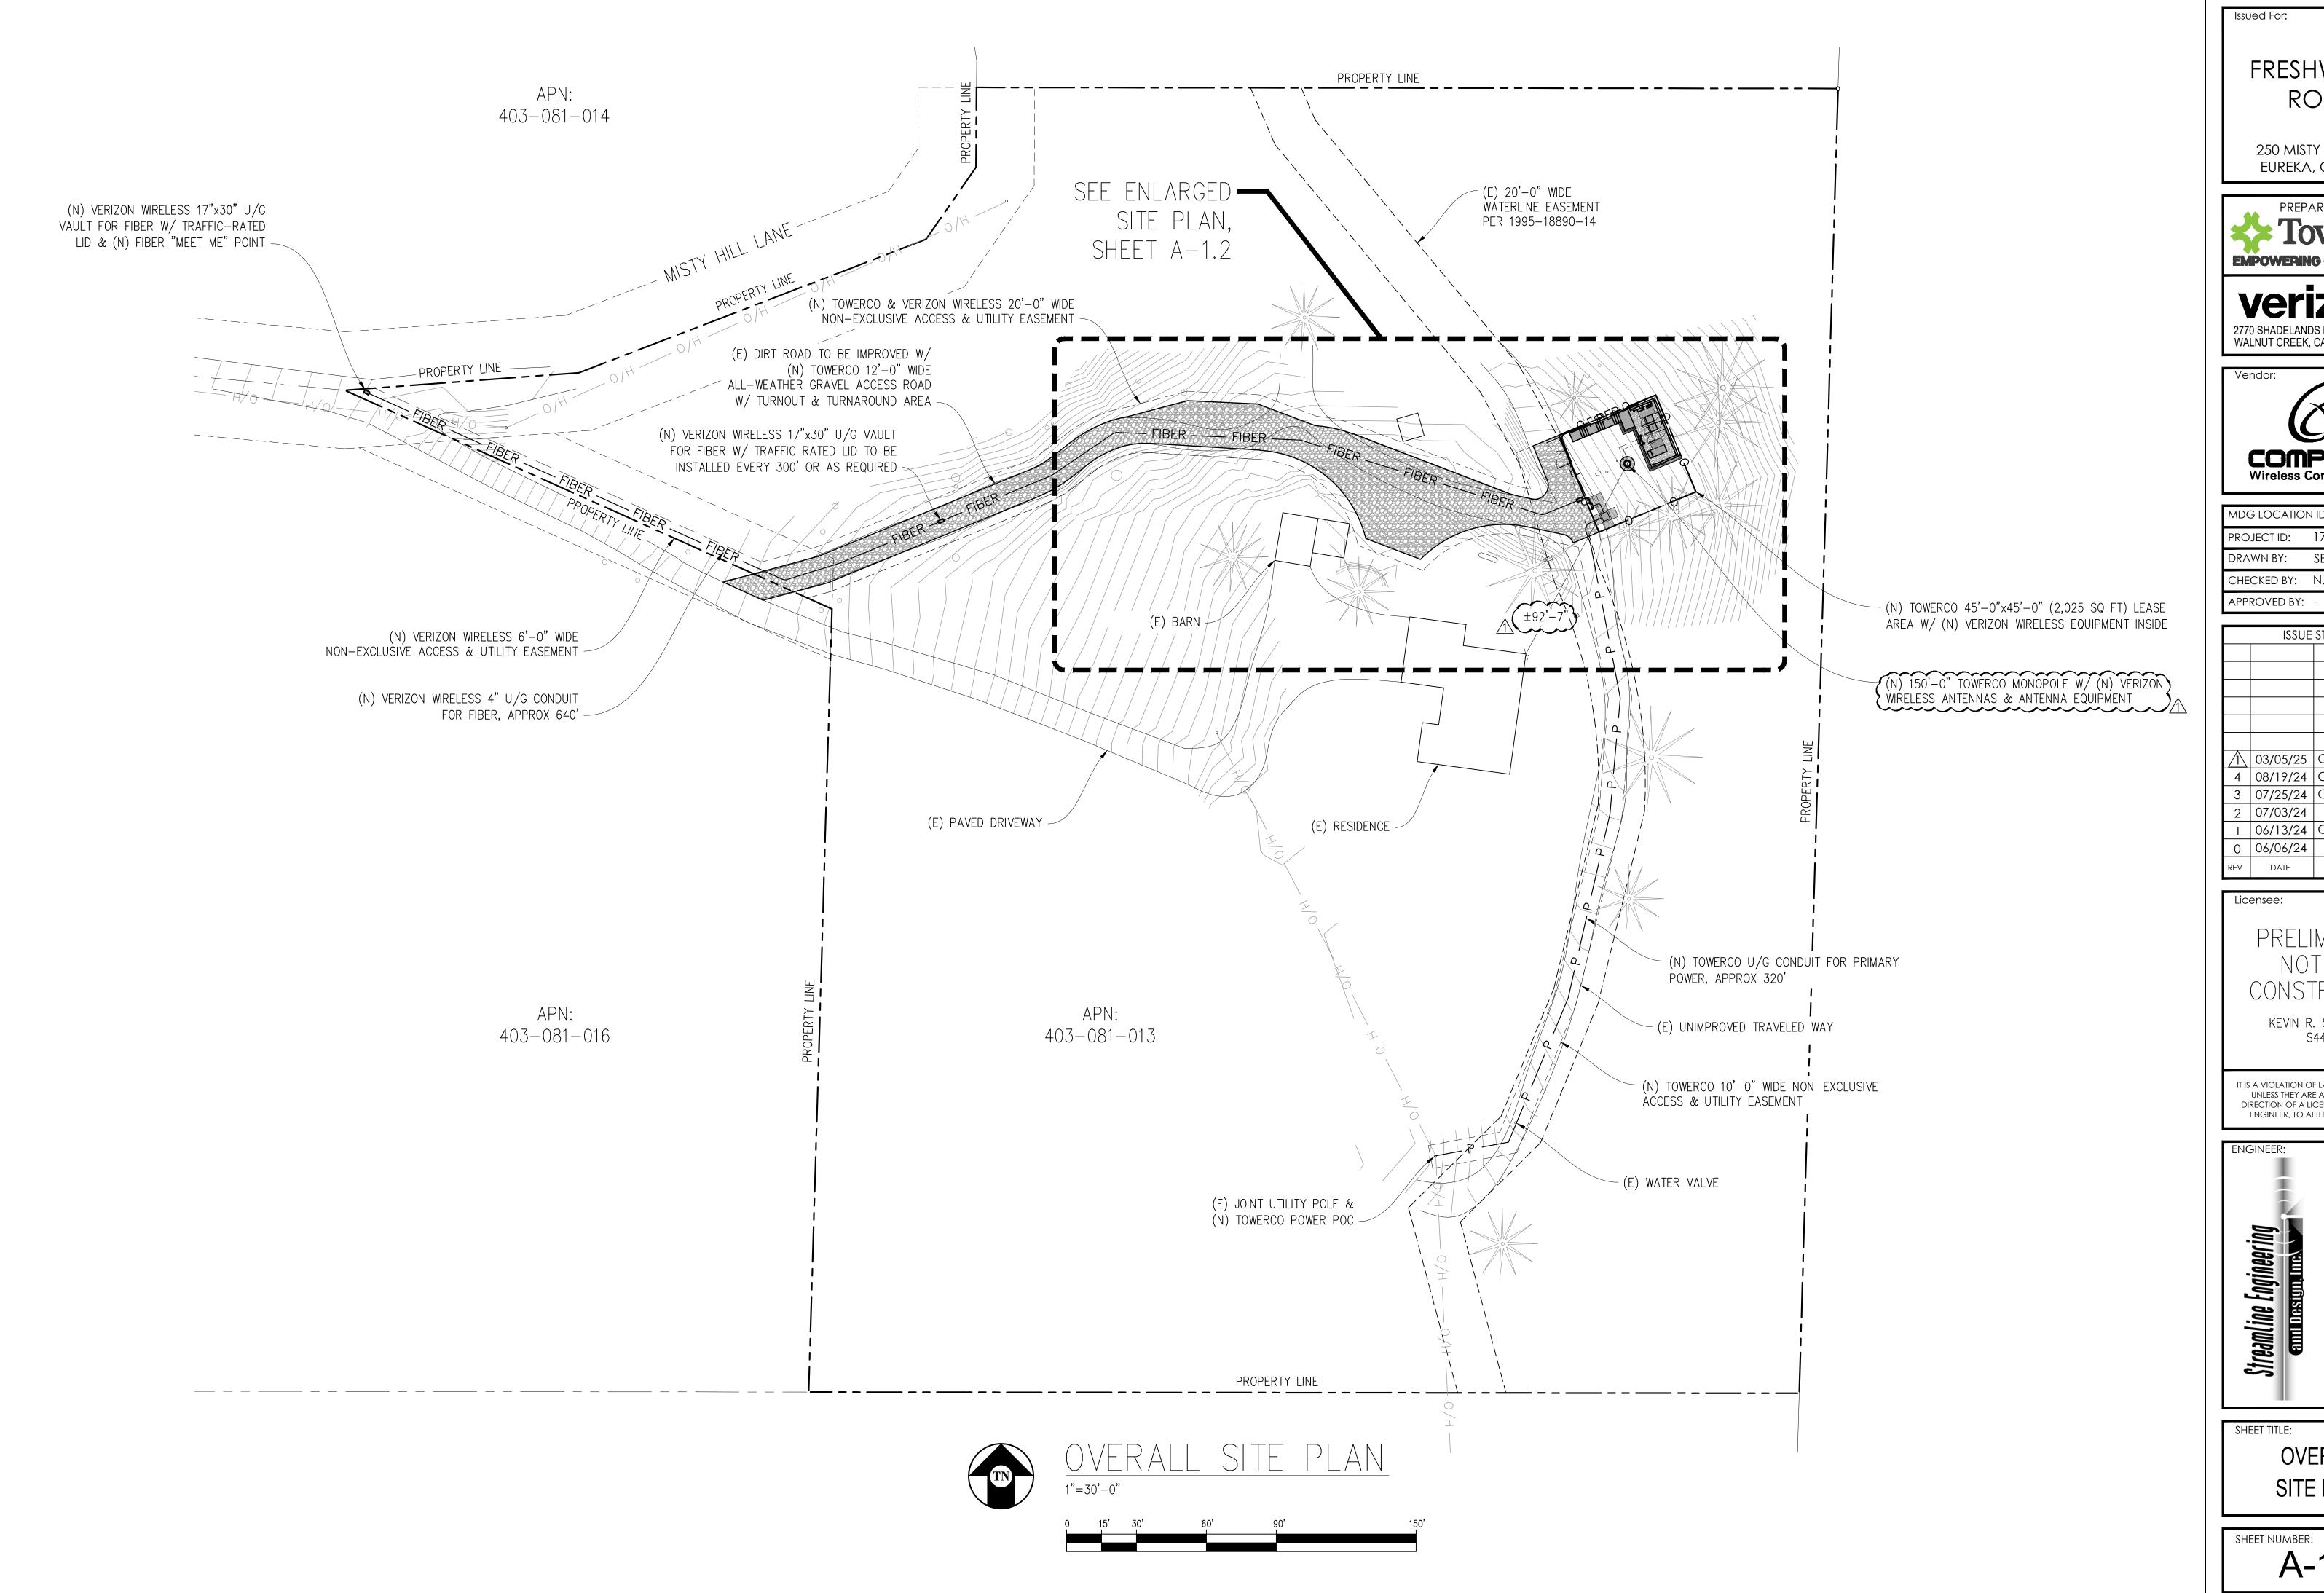

FRESHWATER ROAD

250 MISTY HILL LANE EUREKA, CA 95503







MDG LOCATION	NID: 5000920338
PROJECT ID:	17314976
DRAWN BY:	SEAD
CHECKED BY:	N. GEORGE

	ISSUE STATUS						
\triangle	03/05/25	CLIENT REV	S.D.				
4	08/19/24	CLIENT REV	T.T.				
3	07/25/24	CLIENT REV	T.T.				
2	07/03/24	ZD 100%	T.T.				
1	06/13/24	CLIENT REV	S.D.				
0	06/06/24	ZD 90%	-				
REV	DATE	DESCRIPTION	CAD				

PRELIMINARY: NOT FOR CONSTRUCTION


KEVIN R. SORENSEN S4469

IT IS A VIOLATION OF LAW FOR ANY PERSON, UNLESS THEY ARE ACTING UNDER THE DIRECTION OF A LICENSED PROFESSIONAL ENGINEER, TO ALTER THIS DOCUMENT.



SHEET TITLE:

OVERALL SITE PLAN

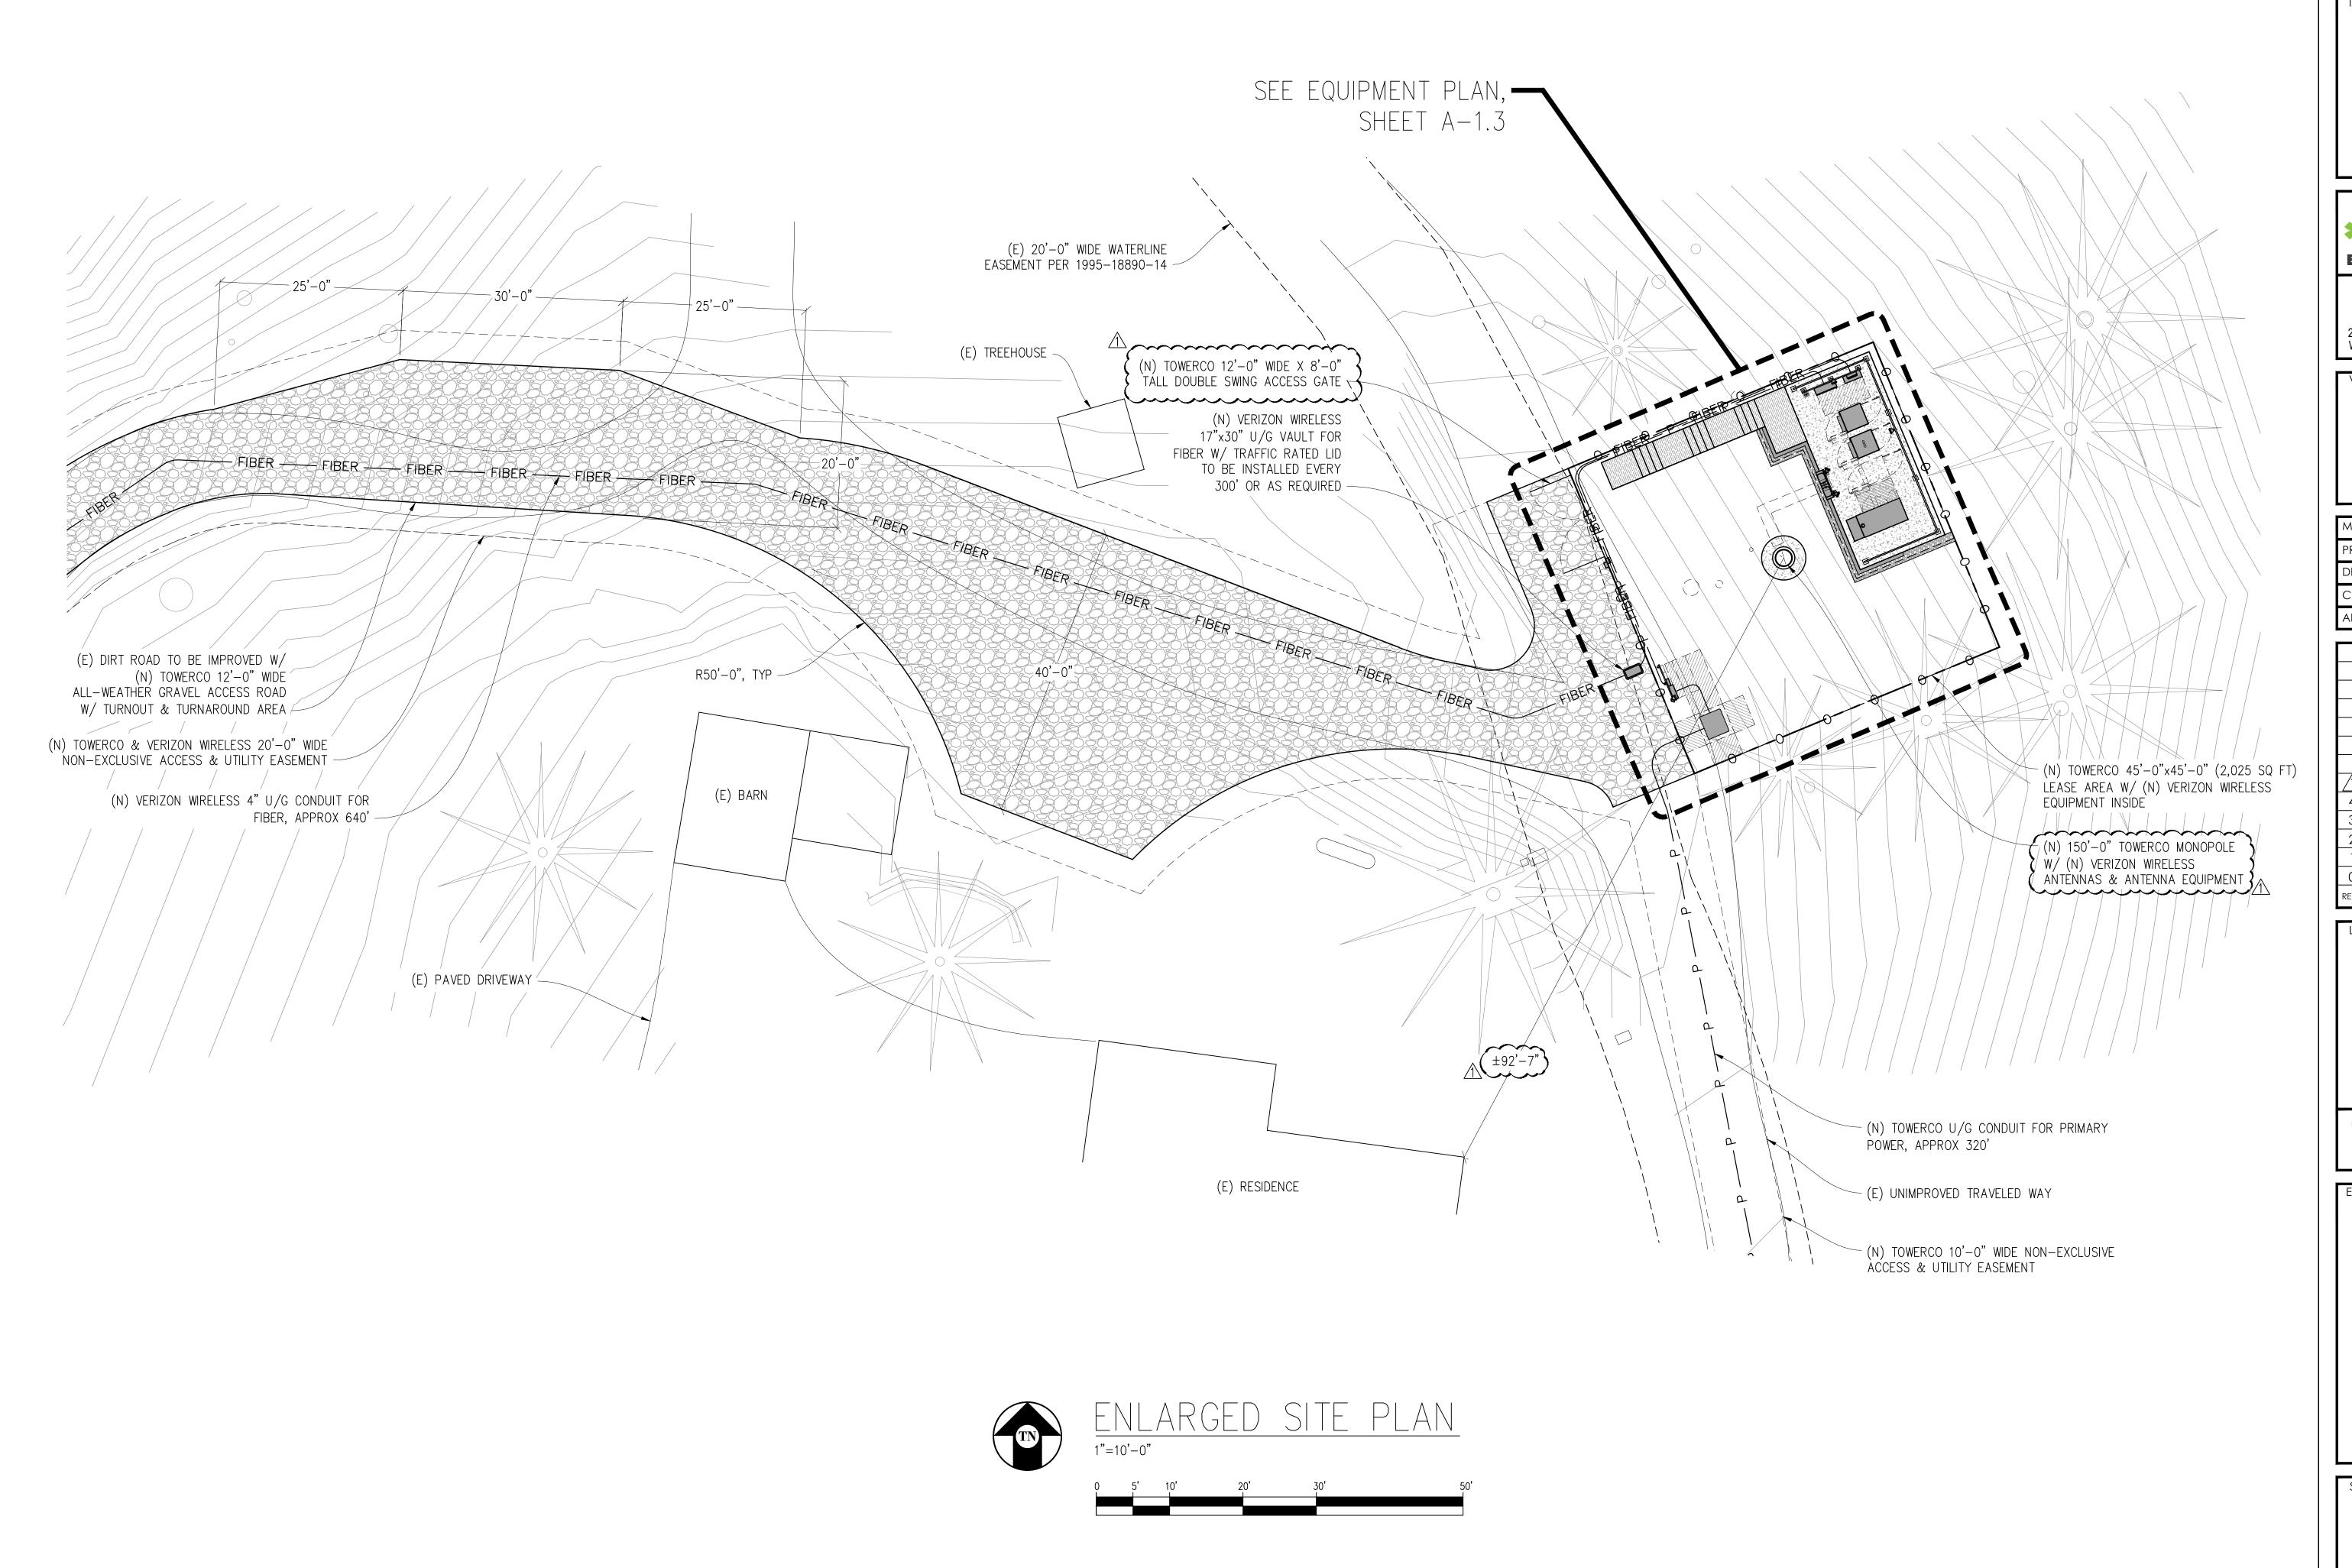

FRESHWATER ROAD

250 MISTY HILL LANE EUREKA, CA 95503







MDG LOCATIO	N ID: 5000920338
PROJECT ID:	17314976
DRAWN BY:	SEAD
CHECKED BY:	N. GEORGE

DRAWN BY: SEAD

CHECKED BY: N. GEORGE

APPROVED BY: -

ISSUE STATUS				
\bigwedge	03/05/25	CLIENT REV	S.D.	
4	08/19/24	CLIENT REV	T.T.	
3	07/25/24	CLIENT REV	T.T.	
2	07/03/24	ZD 100%	T.T.	
1	06/13/24	CLIENT REV	S.D.	
0	06/06/24	ZD 90%	-	
REV	DATE	DESCRIPTION	CAD	

Licensee:

PRELIMINARY: NOT FOR CONSTRUCTION


KEVIN R. SORENSEN S4469

IT IS A VIOLATION OF LAW FOR ANY PERSON, UNLESS THEY ARE ACTING UNDER THE DIRECTION OF A LICENSED PROFESSIONAL ENGINEER, TO ALTER THIS DOCUMENT.



SHEET TITLE

ENLARGED SITE PLAN

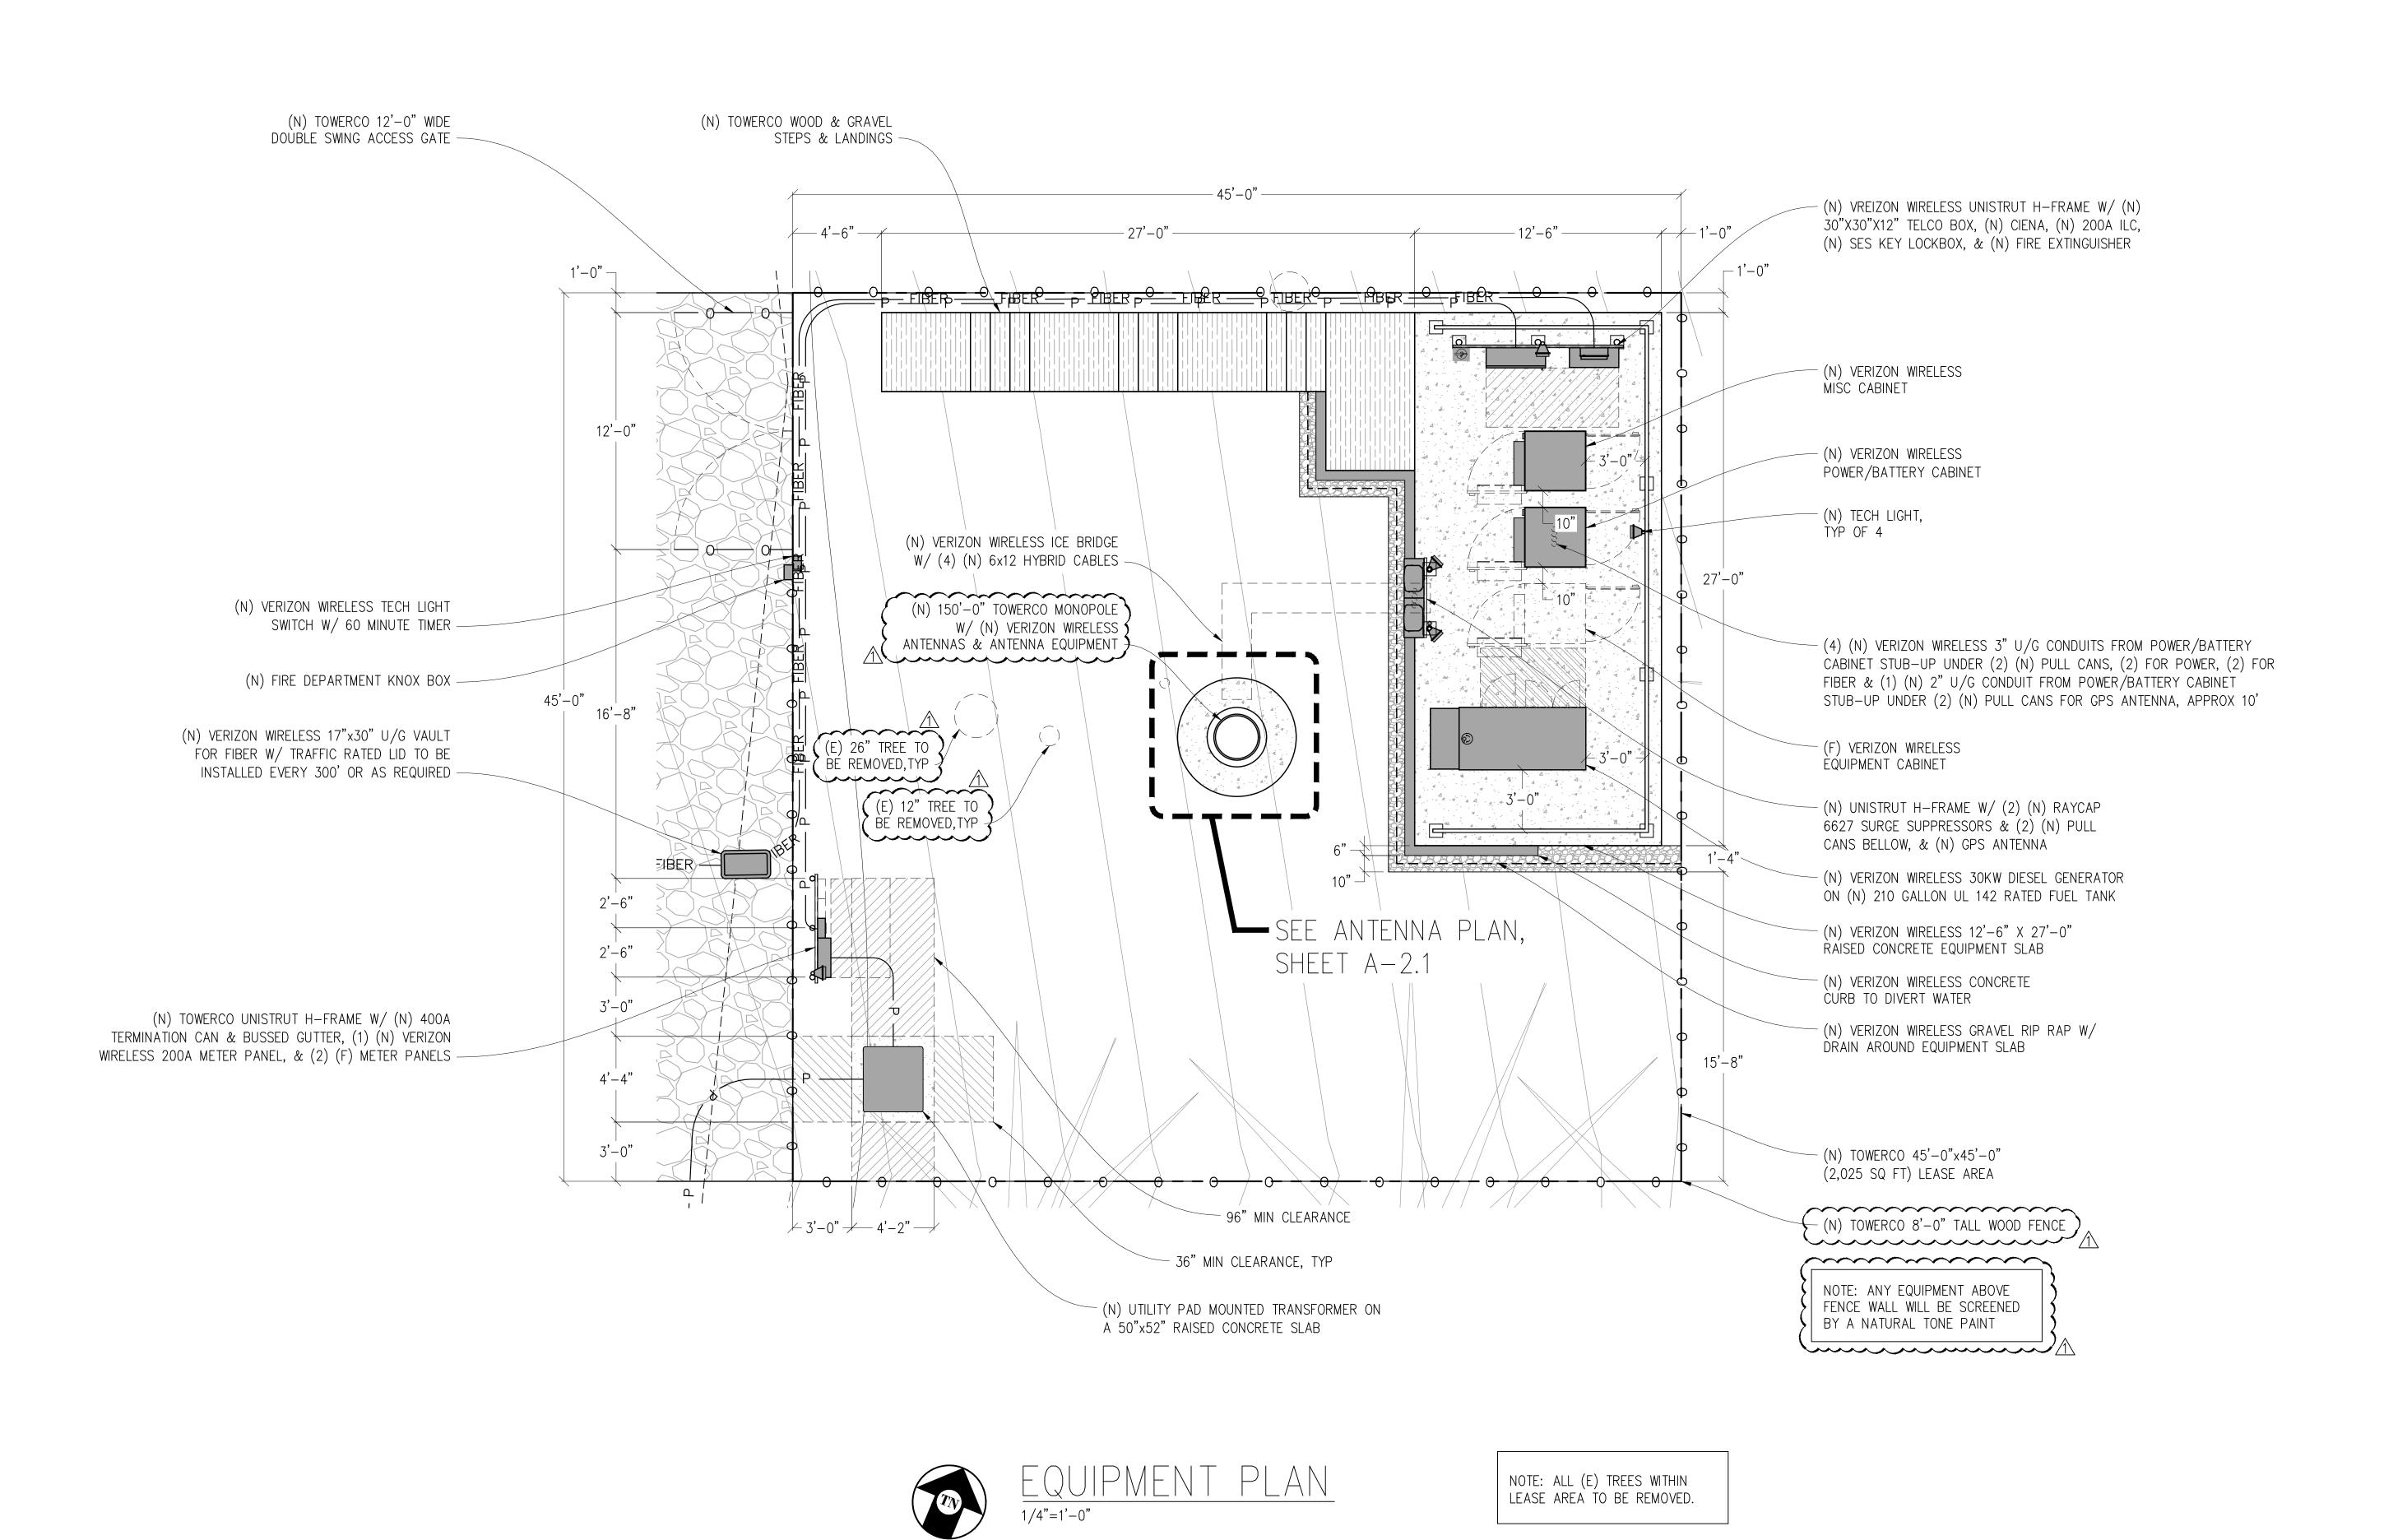

FRESHWATER ROAD

250 MISTY HILL LANE EUREKA, CA 95503







MDG LOCATION ID: 5000920338

PROJECT ID: 17314976

DRAWN BY: SEAD

CHECKED BY: N. GEORGE

APPROVED BY: -

ISSUE STATUS						
\triangle	03/05/25	CLIENT REV	S.D.			
4	08/19/24	CLIENT REV	T.T.			
3	07/25/24	CLIENT REV	T.T.			
2	07/03/24	ZD 100%	T.T.			
1	06/13/24	CLIENT REV	S.D.			
0	06/06/24	ZD 90%	_			
REV	DATE	DESCRIPTION	CAD			

Licensee:

PRELIMINARY:
NOT FOR
CONSTRUCTION

KEVIN R. SORENSEN S4469


IT IS A VIOLATION OF LAW FOR ANY PERSON, UNLESS THEY ARE ACTING UNDER THE DIRECTION OF A LICENSED PROFESSIONAL ENGINEER, TO ALTER THIS DOCUMENT.



SHEET TITLE:

EQUIPMENT

PLAN

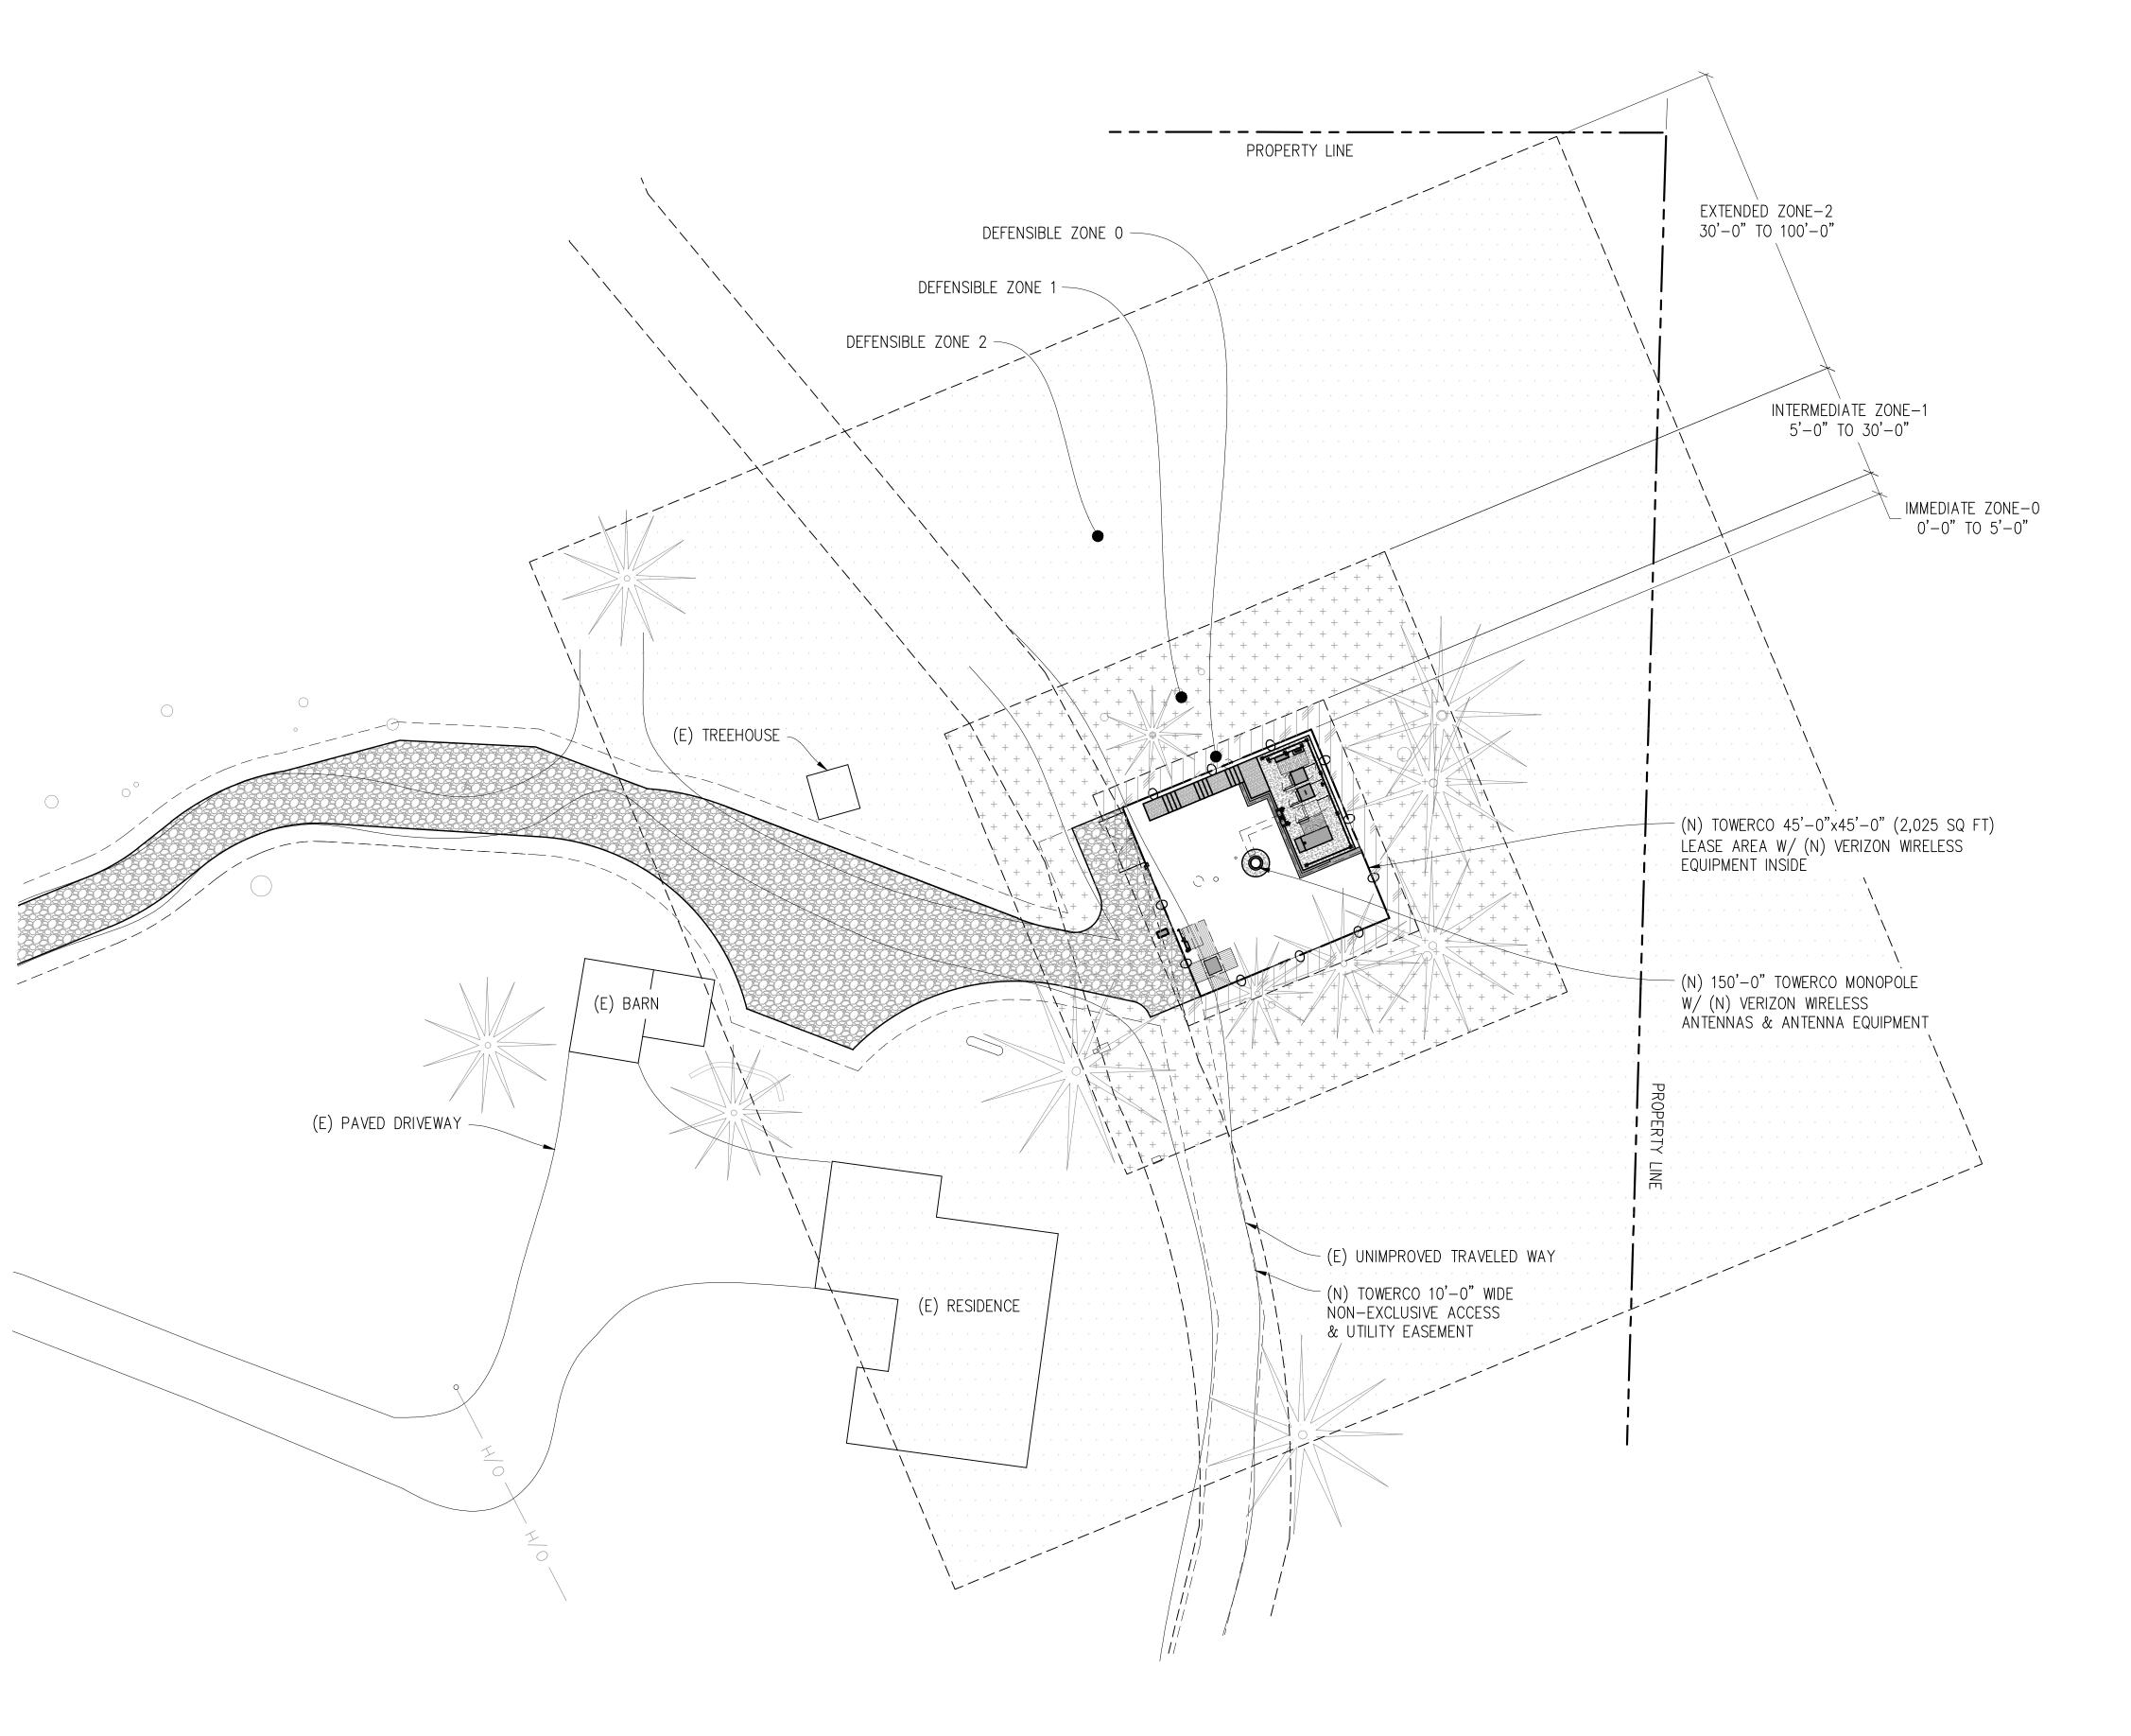



ZONE O EXTENDS 0-5 FEET FROM YOUR FACILITY, FOCUSING ON INTENSE

- CLEAR DEAD WEEDS, GRASS, AND DEBRIS; CHECK ROOFS, GUTTERS, AND OUTDOOR AREAS.
- KEEP BRANCHES TRIMMED 10 FEET AWAY FROM MINIMIZE
- MOVE FIREWOOD AND LUMBER TO ZONE 2 FOR SAFETY. REPLACE COMBUSTIBLE FENCING AND GATES WITH FIRE—RESISTANT
- SHIFT GARBAGE AND RECYCLING CONTAINERS TO A SAFER AREA
- REDUCE FIRE RISKS.

(LEAN, CLEAN, AND GREEN ZONE)

ZONE 1 EXTENDS 5-30 FEET FROM BUILDINGS, STRUCTURES, DECKS, ETC, OR YOUR PROPERTY LINE, WHICHEVER IS CLOSER.

- REMOVE DEAD LEAVES AND PINE NEEDLES FORM YOUR YARD, ROOF, AND GUTTERS.
- TRIM OVERHANGING BRANCHES AND KEEP THEM 10 FEET AWAY FROM YOUR CHIMNEY.
- REGULARLY TRIM TREES TO MAINTAIN A 10-FOOT GAP FROM OTHERS MOVE WOOD PILES TO ZONE 2
- PRUNE FLAMMABLE PLANTS AND SHRUBS NEAR WINDOWS
- BALCONIES, AND STAIRS.
- ENSURE OUTBUILDINGS AND LPG TANKS HAVE 10 FEET OF CLEAR SPACE TO BARE SOIL AND NO FLAMMABLE VEGETATION WITHIN AN ADDITIONAL 10 FEET AROUND THEM.

DEFENSIBLE ZONE 2 (REDUCE FUEL ZONE)

ZONE 2 EXTENDS 30-100 FEET OUT FROM BUILDINGS, STRUCTURES, DECKS, ETC TO YOUR PROPERTY LINE, WHICHEVER IS CLOSER.

- TRIM ANNUAL GRASS TO A MAXIMUM OF 4 INCHES
- SPACING NOTES)
- (SEE VERTICAL SPACING NOTES)
 REMOVE FALLEN LEAVES, NEEDLES, AND SMALL BRANCHES, BUT CAN
- KEEP EXPOSED WOOD PILES AT LEAST 10 FEET CLEAR FROM SURROUNDINGS, DOWN TO THE SOIL.
- SPACE TO BARE SOIL AND NO FLAMMABLE VEGETATION WITHIN AN ADDITIONAL 10 FEET AROUND THEM.

(EMBER-RESISTANT ZONE)

FUEL REDUCTION TO PROTECT AGAINST EMBER ATTACKS.


- USE GRAVEL, PAVERS, OR CONCRETE INSTEAD OF COMBUSTIBLE
- COMBUSTIBLE ITEMS LIKE FURNITURE AND PLANTERS ON DECKS.
- MATERIALS.
- OUTSIDE THIS ZONE.
- RELOCATE BOATS, RVS, AND VEHICLES AWAY FROM THIS ZONE TO

DEFENSIBLE ZONE 1

- CLEAR ALL DEAD PLANTS, GRASS, AND WEEDS.

- CLEAR FLAMMABLE VEGETATION AND ITEMS FROM UNDER DECKS,
- MAINTAIN SPACE BETWEEN TREES, SHRUBS, AND FLAMMABLE ITEMS LIKE PATIO FURNITURE AND WOOD PILES.

- SPACE OUT SHRUBS AND TREES HORIZONTALLY (SEE HORIZONTAL
- ENSURE VERTICÁL SPACING BETWEEN GRASS, SHRUBS, AND TREES
- LEAVE UP TO 3 INCHES.
- ENSURE OUTBUILDINGS AND LPG TANKS HAVE 10 FEET OF CLEAR

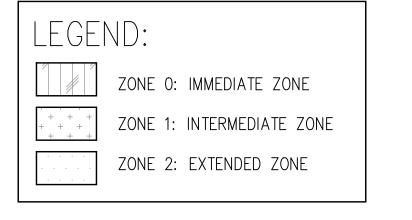

Issued For:

FRESHWATER ROAD


250 MISTY HILL LANE EUREKA, CA 95503







MDG LOCATION ID: 5000920338 PROJECT ID: 17314976 DRAWN BY: SEAD CHECKED BY: N. GEORGE APPROVED BY: -ISSUE STATUS

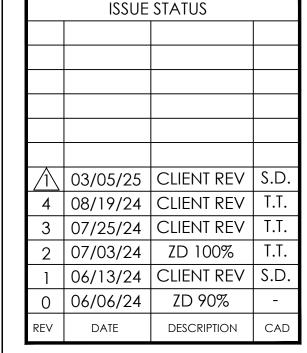

Licensee:

PRELIMINARY: NOT FOR CONSTRUCTION

IT IS A VIOLATION OF LAW FOR ANY PERSON, UNLESS THEY ARE ACTING UNDER THE

KEVIN R. SORENSEN


S4469




SHEET TITLE: FIRE PLAN

	(N) RF SCHEDULE (PRELIMINARY & SUBJECT TO CHANGE)									
,	SECTOR ANTENNA MODEL NO. AZIN		AZIMUTH	CENTERLINE	RRU NO'S & MODEL #	# OF HYBRID CABLES	LENGTH OF CABLES	SURGE SUPPRESSOR	NO. OF DIPLEXERS	NO. OF COMBINERS
A	A1	NHH-65C-R2B	0°	±146'-0"	(1) 4490	SHARED	_	SHARED	0	0
Þ H	A2	NHH-65C-R2B	0°	±146'-0"	(1) 4890	SHARED	_	SHARED	0	0
Ä	А3	AIR 6419	0°	±148'-10"	INTEGRATED	2	±170'	(1) 6627	0	0
В	B1	NHH-65C-R2B	110°	±146'-0"	(1) 4490	SHARED	_	SHARED	0	0
Ē	B2	NHH-65C-R2B	110°	±146'-0"	(1) 4890	SHARED	_	SHARED	0	0
A	ВЗ	AIR 6419	110°	±148'-10"	INTEGRATED	2	±170'	(1) 6627	0	0
Ģ	C1	NHH-65C-R2B	250°	±146'-0"	(1) 4490	SHARED	_	SHARED	0	0
M M	C2	NHH-65C-R2B	250°	±146'-0"	(1) 4890	SHARED	_	SHARED	0	0
A	C3	AIR 6419	250°	±148'-10"	INTEGRATED	SHARED	_	SHARED	0	0

AZIMUTH = 0° SECTOR A

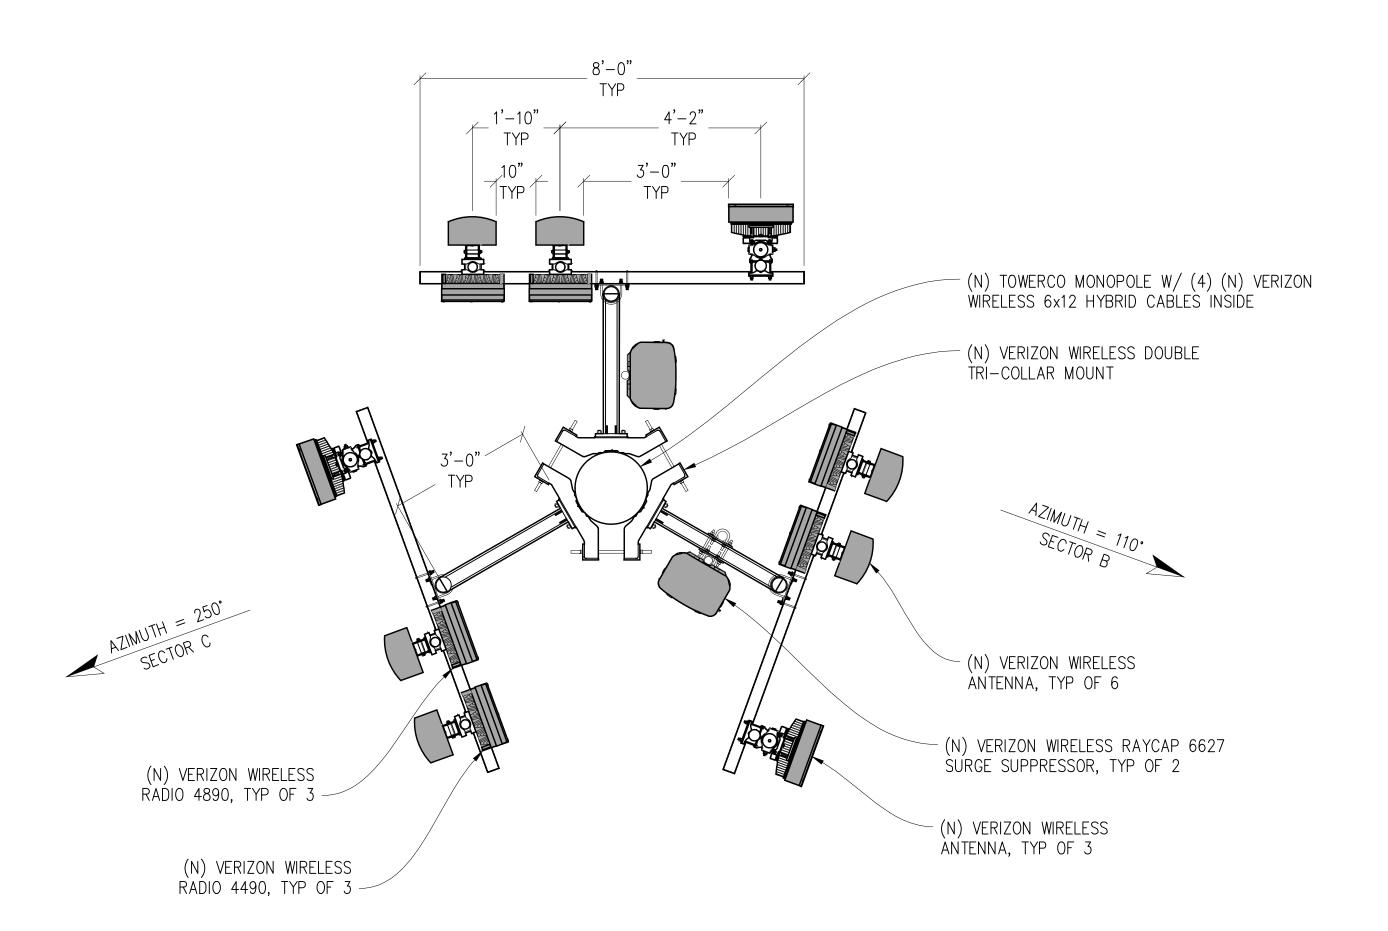

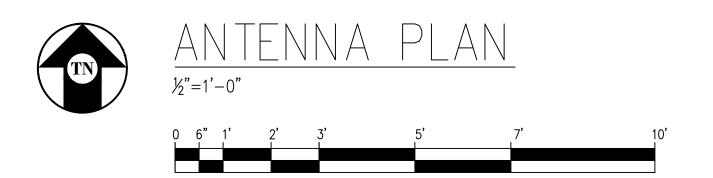

NOTES:

1. STRUCTURE TO BE ENGINEERED FOR 3 ADDITIONAL WIRELESS CARRIERS.

Issued For:

FRESHWATER ROAD

250 MISTY HILL LANE EUREKA, CA 95503







MDG LOCATION	NID: 5000920338
PROJECT ID:	17314976
DRAWN BY:	SEAD
CHECKED BY:	N. GEORGE
APPROVED BY:	-

	ISSUE STATUS						
\bigvee	03/05/25	CLIENT REV	S.D.				
4	08/19/24	CLIENT REV	T.T.				
3	07/25/24	CLIENT REV	T.T.				
2	07/03/24	ZD 100%	T.T.				
1	06/13/24	CLIENT REV	S.D.				
0	06/06/24	ZD 90%	-				
REV	DATE	DESCRIPTION	CAD				

Licensee:

PRELIMINARY: NOT FOR CONSTRUCTION


KEVIN R. SORENSEN S4469

IT IS A VIOLATION OF LAW FOR ANY PERSON, UNLESS THEY ARE ACTING UNDER THE DIRECTION OF A LICENSED PROFESSIONAL ENGINEER, TO ALTER THIS DOCUMENT.



SHEET TITLE:

ANTENNA PLAN

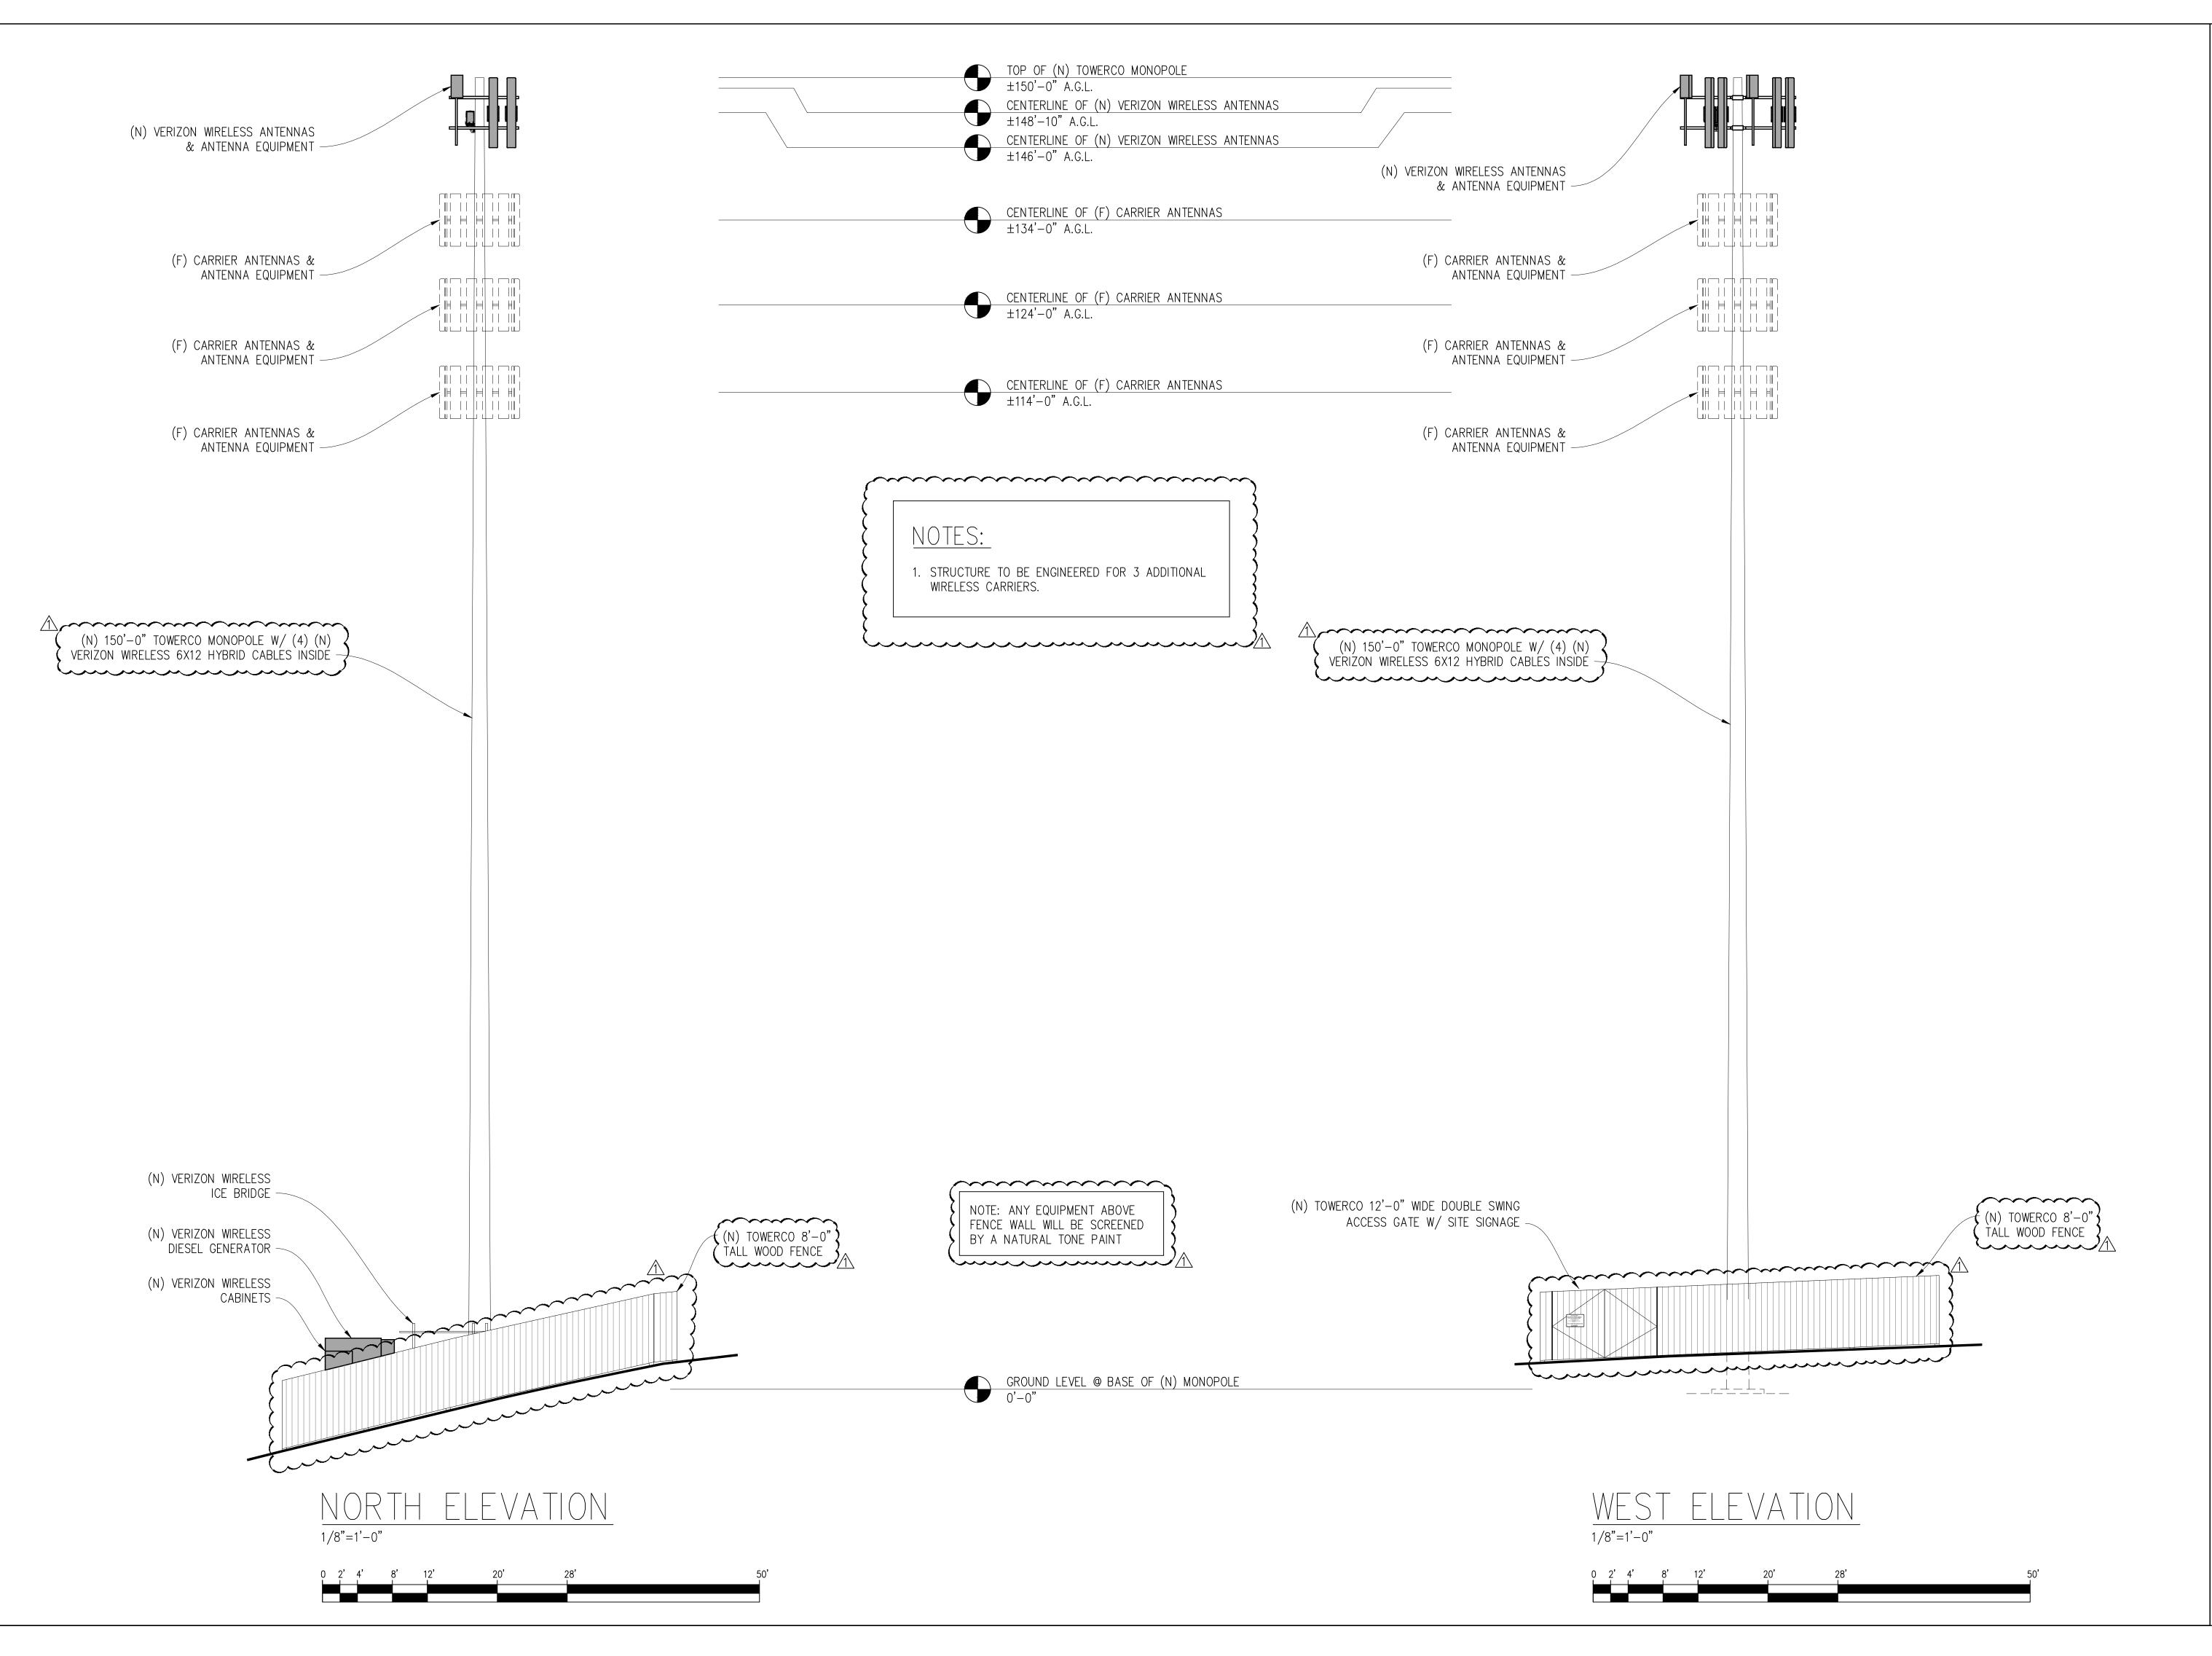

FRESHWATER ROAD

250 MISTY HILL LANE EUREKA, CA 95503







MDG LOCATIO	N ID: 5000920338
PROJECT ID:	17314976
DRAWN BY:	SEAD
CHECKED BY:	N. GEORGE

APPROVED BY: -

ISSUE STATUS						
\triangle	03/05/25	CLIENT REV	S.D.			
4	08/19/24	CLIENT REV	T.T.			
3	07/25/24	CLIENT REV	T.T.			
2	07/03/24	ZD 100%	T.T.			
1	06/13/24	CLIENT REV	S.D.			
0	06/06/24	ZD 90%	-			
REV	DATE	DESCRIPTION	CAD			

Licensee:

PRELIMINARY: NOT FOR CONSTRUCTION


KEVIN R. SORENSEN S4469


IT IS A VIOLATION OF LAW FOR ANY PERSON, UNLESS THEY ARE ACTING UNDER THE DIRECTION OF A LICENSED PROFESSIONAL ENGINEER, TO ALTER THIS DOCUMENT.



SHEET TITLE:

ELEVATIONS

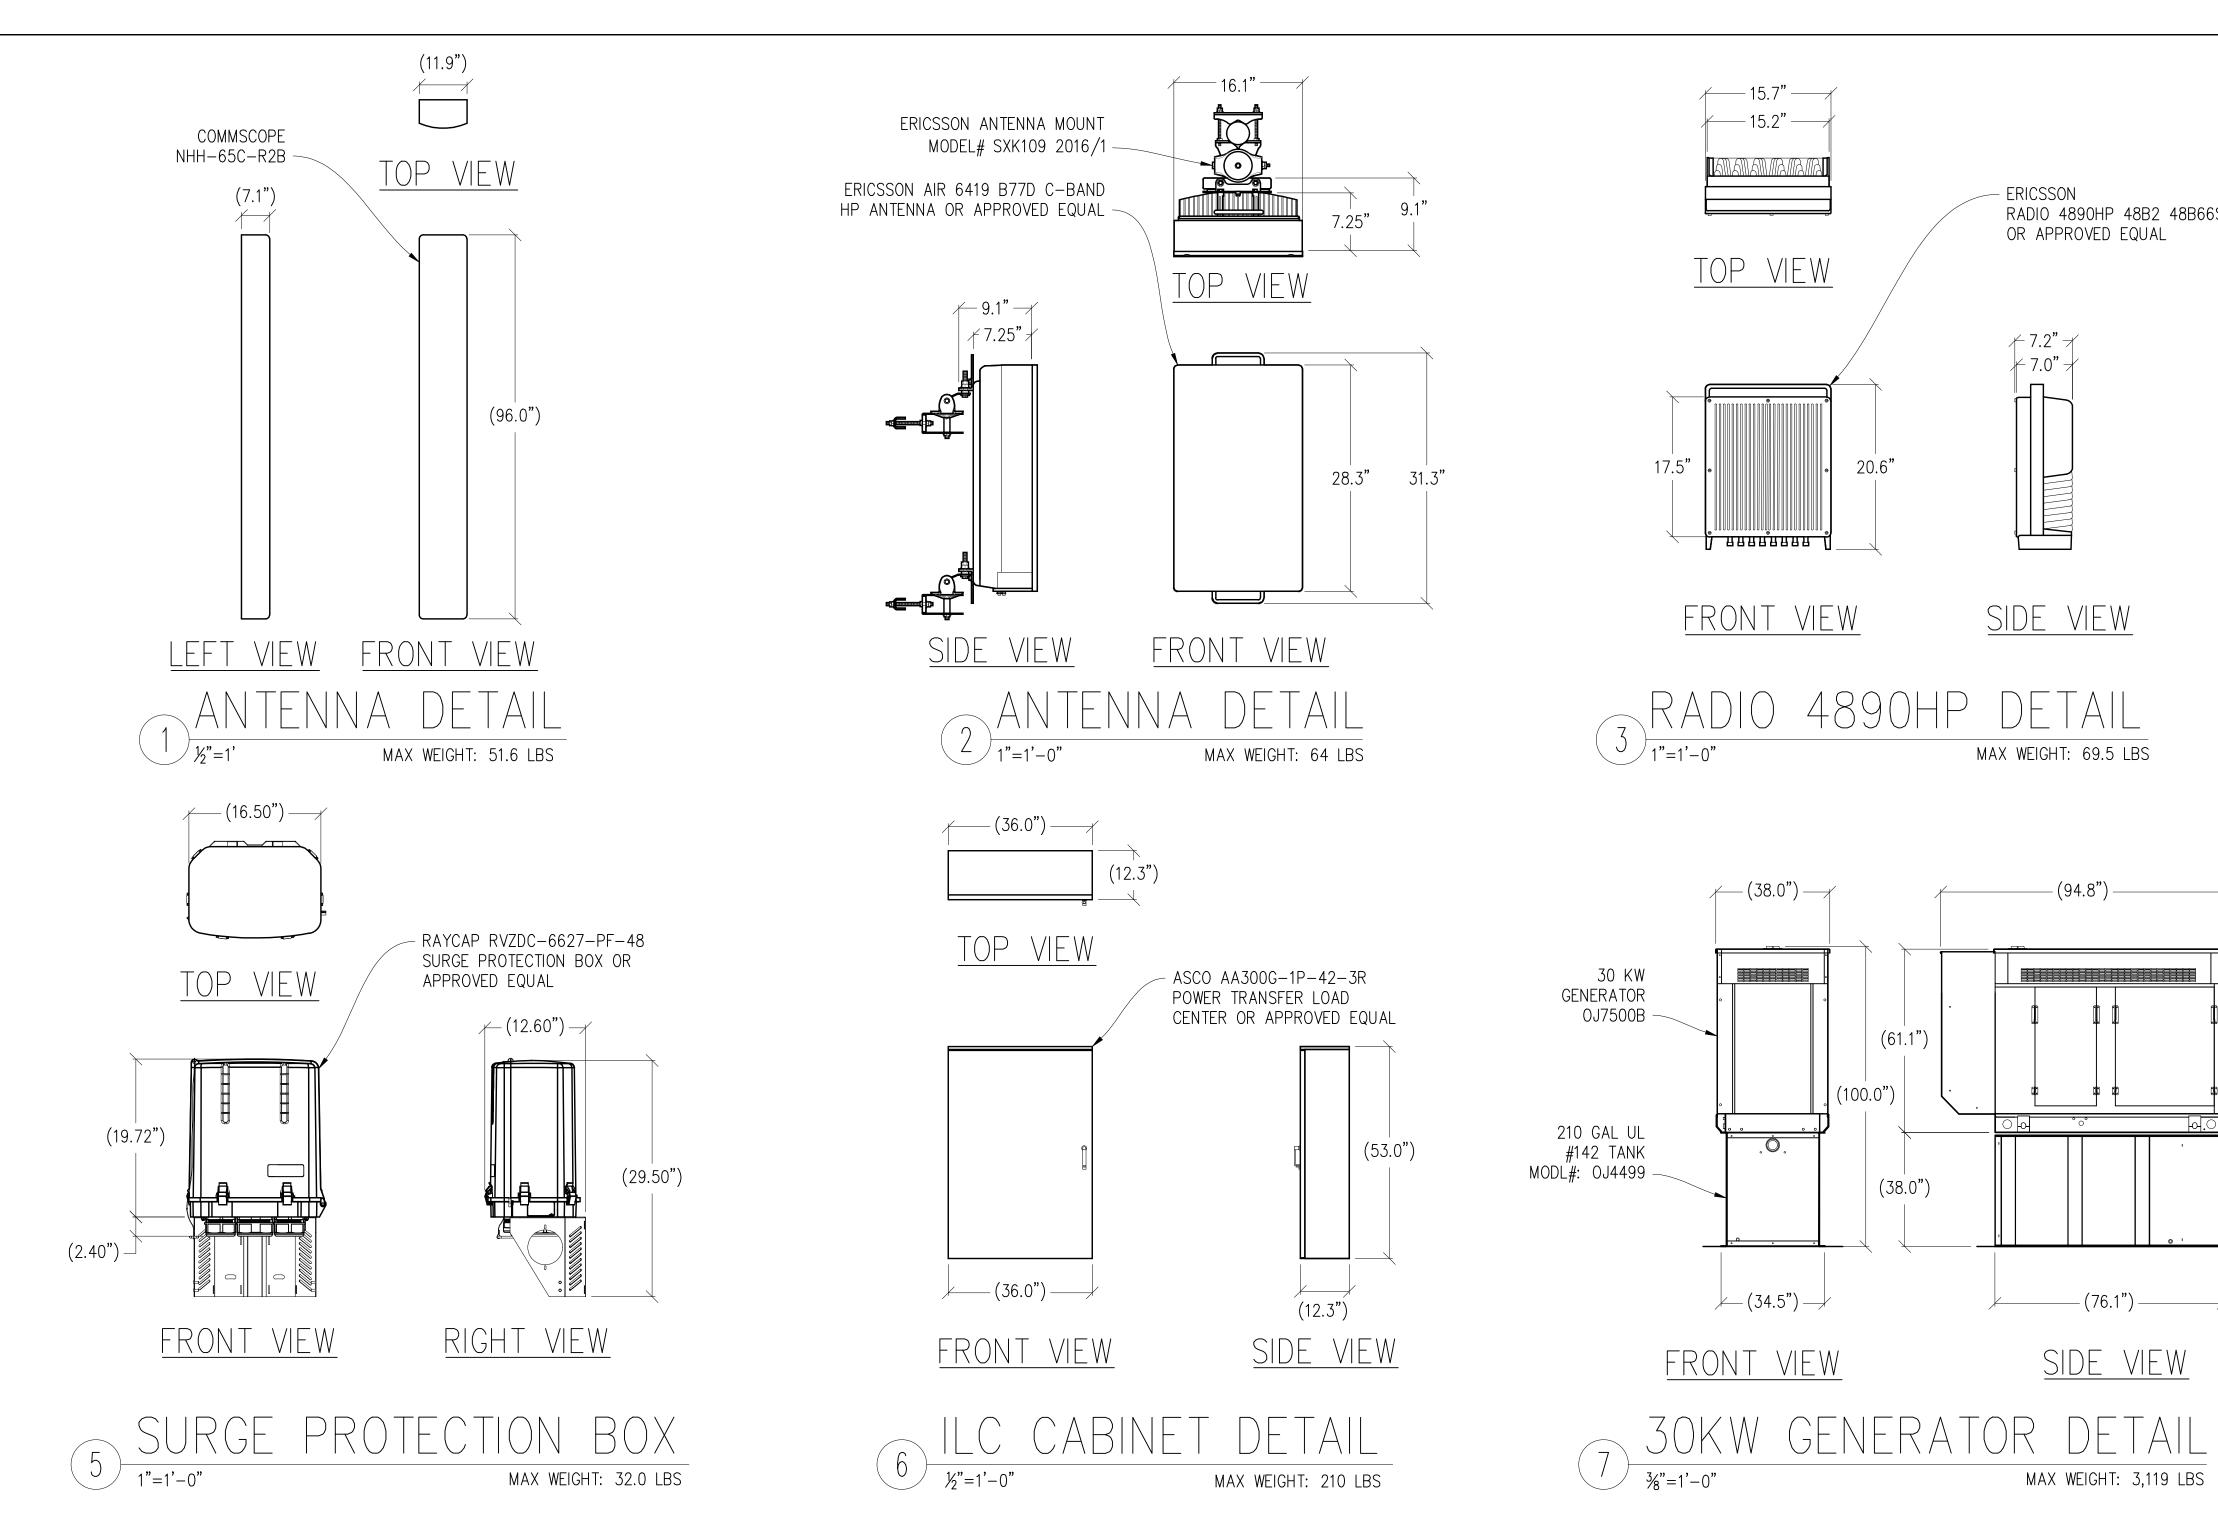

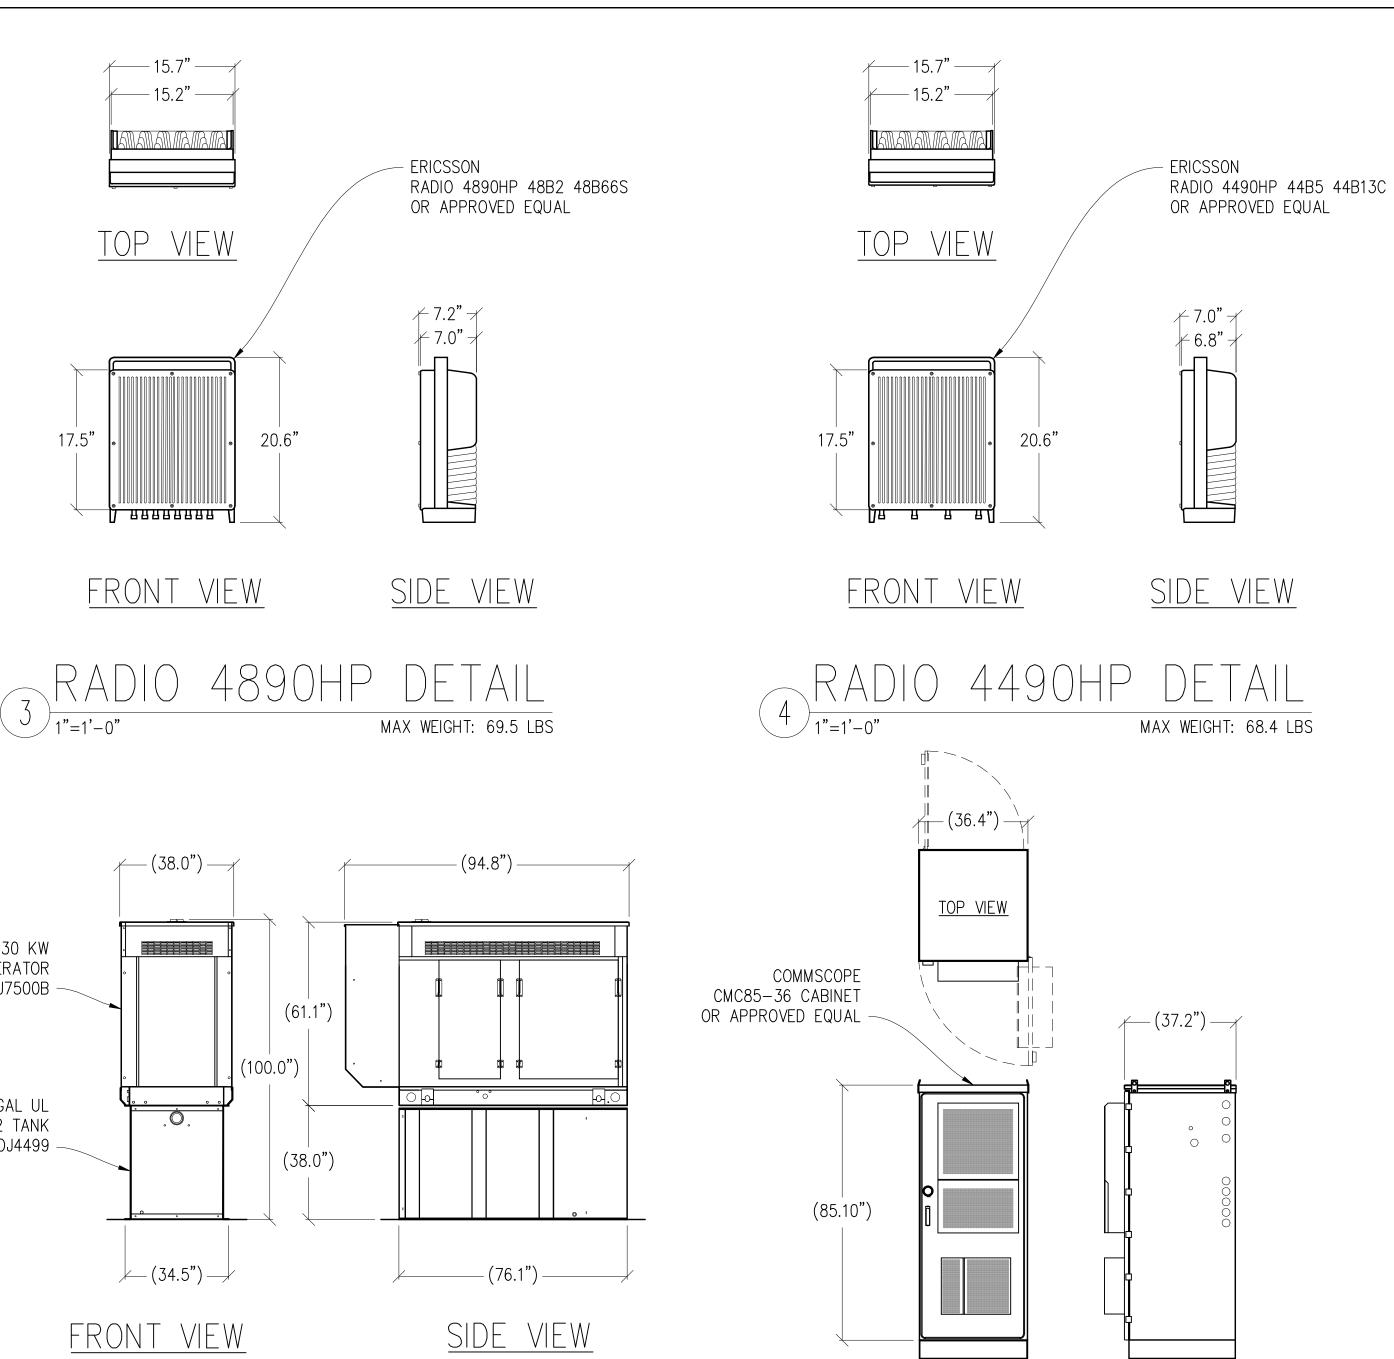

FRESHWATER ROAD

250 MISTY HILL LANE EUREKA, CA 95503







MDG LOCATION	NID: 5000920338
PROJECT ID:	17314976
DRAWN BY:	SEAD
CHECKED BY:	N. GEORGE
APPROVED BY:	-

ISSUE STATUS						
<u>/ì\</u>	03/05/25	CLIENT REV	S.D.			
4	08/19/24	CLIENT REV	T.T.			
3	07/25/24	CLIENT REV	T.T.			
2	07/03/24	ZD 100%	T.T.			
1	06/13/24	CLIENT REV	S.D.			
0	06/06/24	ZD 90%	-			
REV	DATE	DESCRIPTION	CAD			

Licensee:

PRELIMINARY:
NOT FOR
CONSTRUCTION


IT IS A VIOLATION OF LAW FOR ANY PERSON,
UNLESS THEY ARE ACTING UNDER THE

KEVIN R. SORENSEN S4469



SHEET TITLE:

DETAILS

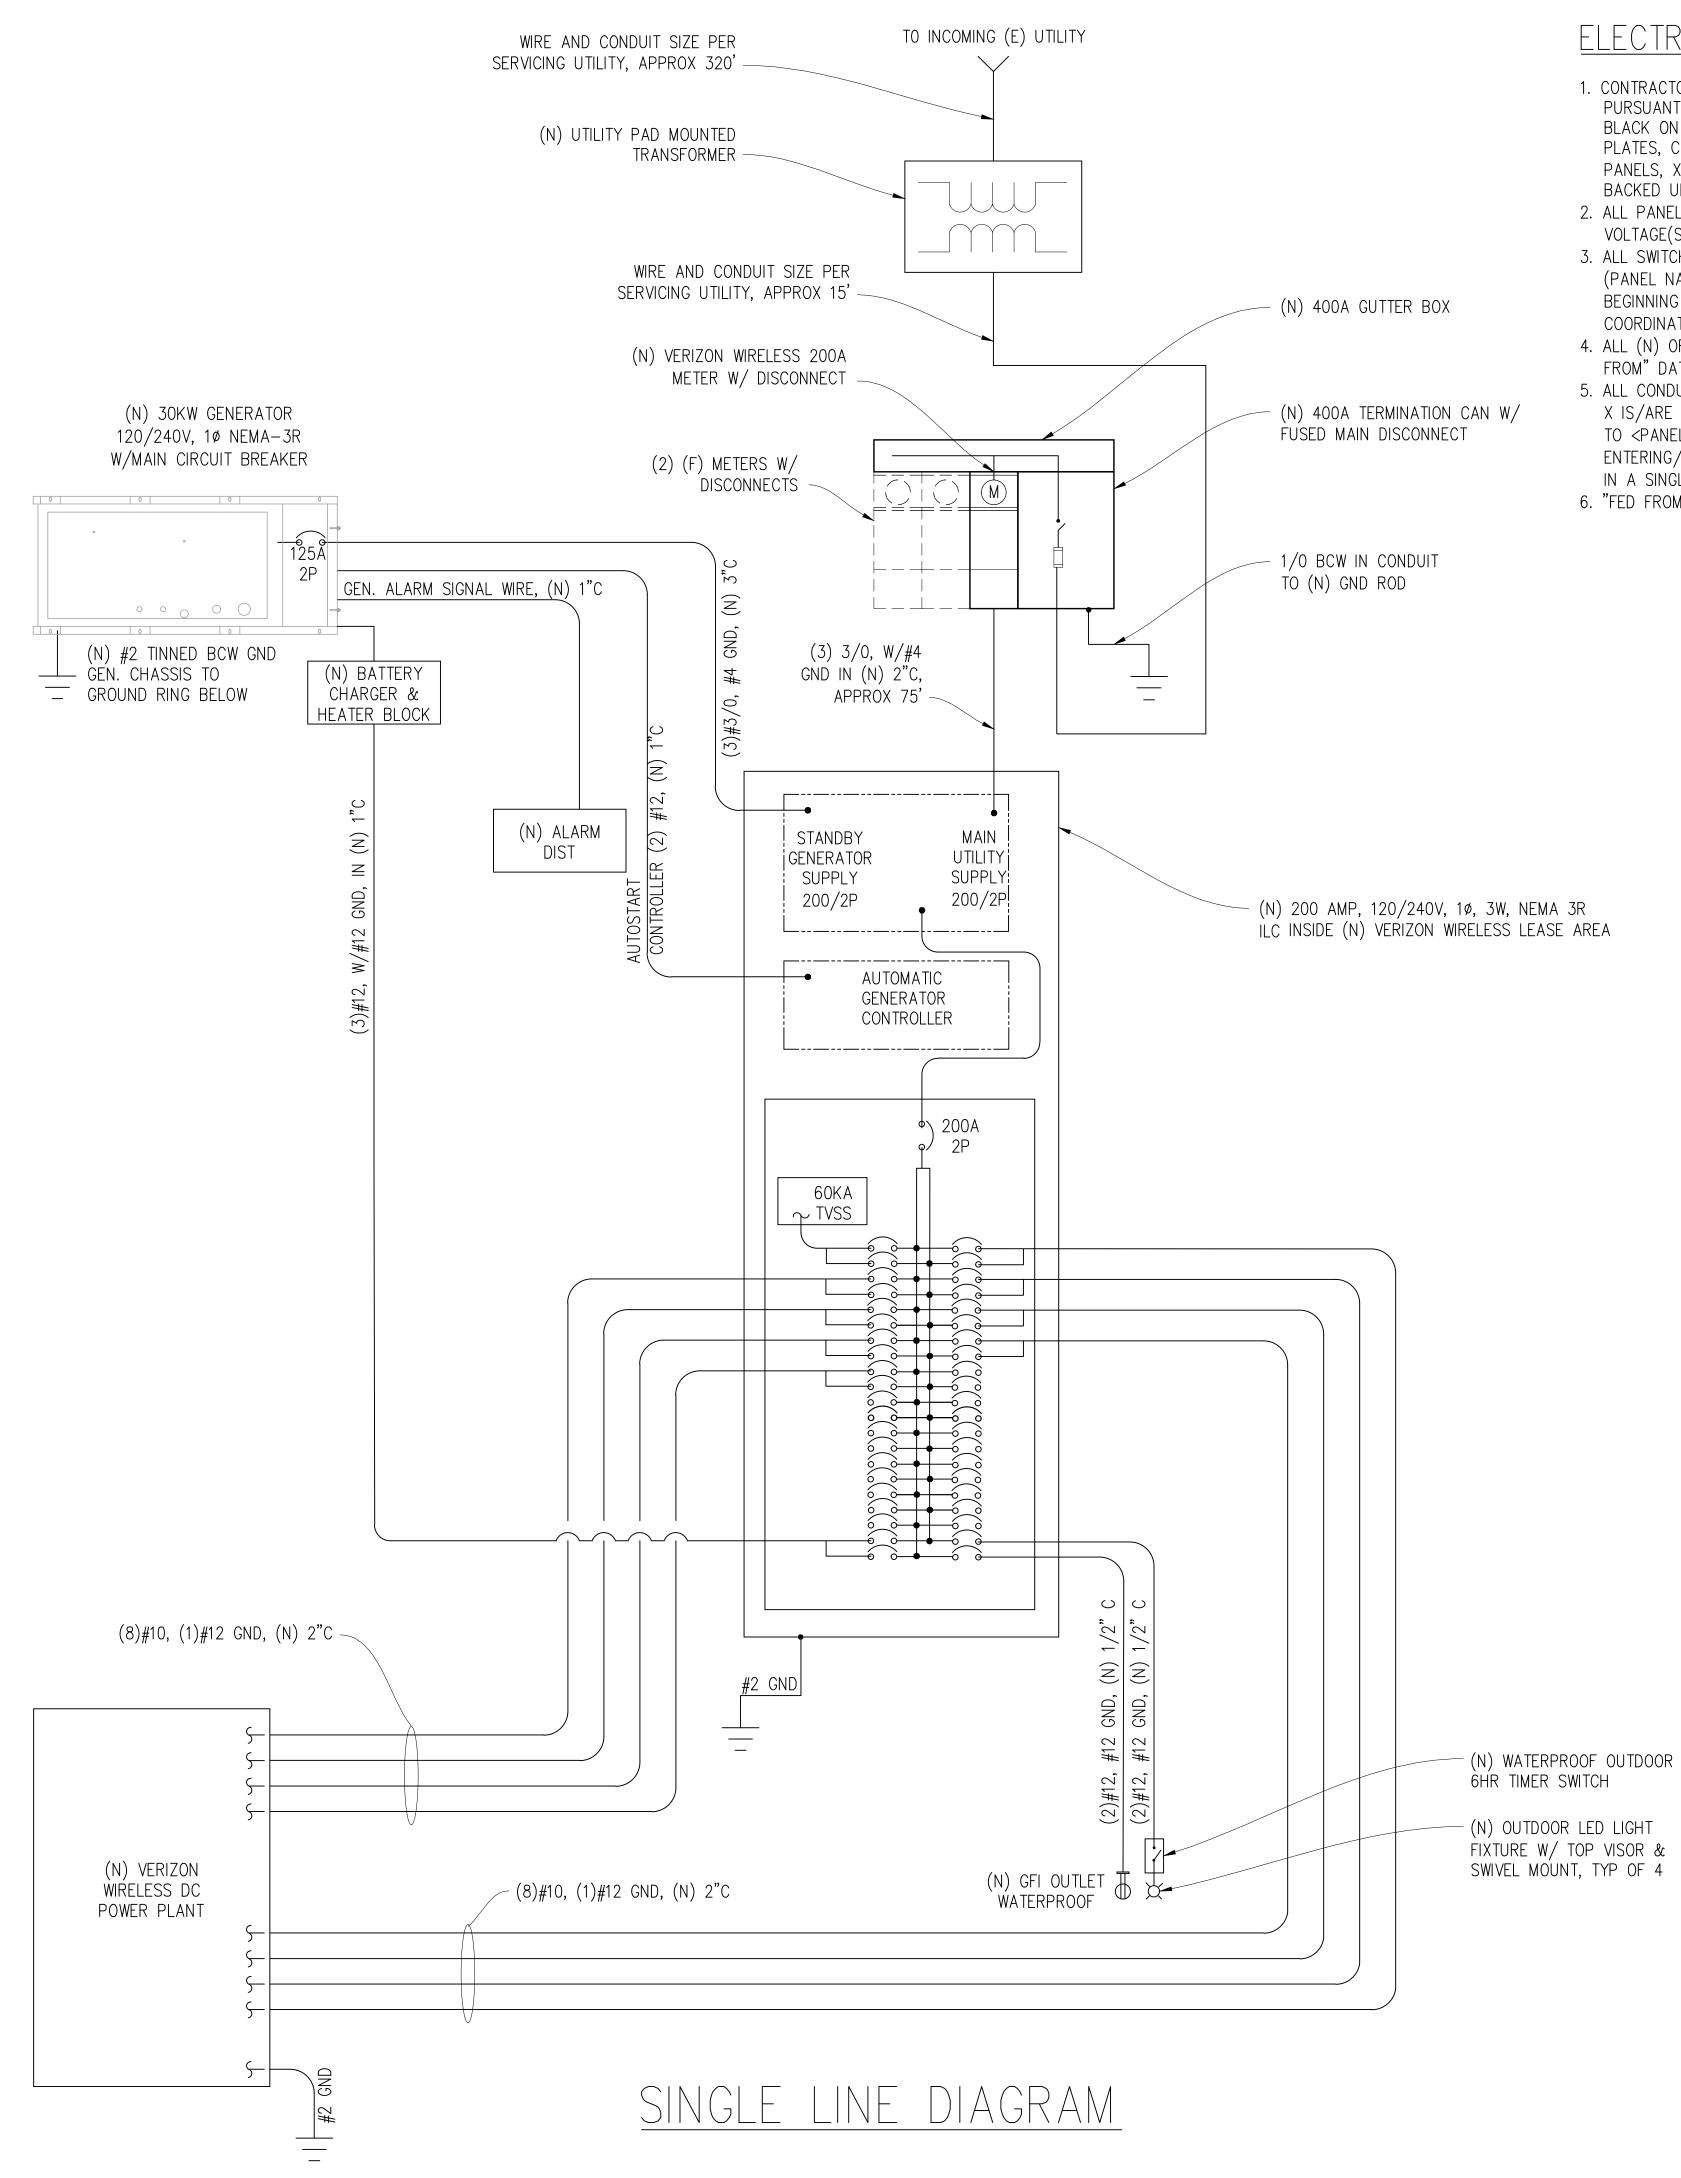

ELECTRICAL LABELING REQUIREMENTS

- 1. CONTRACTOR SHALL LABEL ALL ELECTRICAL DEVICES INSTALLED OR ALTERED PURSUANT TO THIS CONTRACT PER THE FOLLOWING. LABELS SHALL BE PERMANENT BLACK ON WHITE PEEL & STICK LABEL MAKER TYPE FOR ALL SWITCH & OUTLET PLATES, CONDUITS AND CEILING FIXTURES, AND SHALL BE PHENOLIC TAG TYPE FOR PANELS. XFMR's. PULL BOXES, ETC.; PHENOLIC TAGS SHALL BE RED IN COLOR WHERE BACKED UP BY GENERATOR
- 2. ALL PANELS, XFMR'S AND PULL BOXES SHALL BE LABELED WITH DEVICE 'NAME', VOLTAGE(S), RATING FOR XFMR's, AND "FED FROM" DATA.
- 3. ALL SWITCH & OUTLET PLATES SHALL BE LABELED WITH "FED FROM" CIRCUIT DATA (PANEL NAME & CIRCUIT#); ALL GANG SWITCHES SHALL BEAR SWITCH NUMBERS BEGINNING W/#1 ON LEFT OF THE MAIN LIGHTING SWITCH FOR EACH ROOM FOR COORDINATION W/FIXTURE LABELS.
- 4. ALL (N) OR RETROFITTED LIGHTING FIXTURES SHALL BE LABELED WITH THE "FED FROM" DATA (SWITCH#)
- 5. ALL CONDUITS EXITING A PANEL BOARD SHALL BE LABELED "CIRCUIT(S) 'X'..." WHERE X IS/ARE THE BREAKER#(S). CONDUITS EXITING XFMR'S SHALL BE LABELED "FEEDER TO <PANEL, DEVICE>", E.G. "FEEDER TO PANEL <panel name>. CONDUITS ENTERING/EXITING A ROOM OR FLOOR SHALL BE LABELED AT THE ENTRY & EXIT (OR IN A SINGLE LOCATION IF OBVIOUS) W/"FED FROM..." & "TO PANEL/XFMR/..."DATA.
- 6. "FED FROM: DATA = $\langle panel name \rangle \langle brkr \# \rangle$ EG: "PANEL X/1,3,5")

ELECTRIC LEGEND

METER

CIRCUIT BREAKER

SERVICE GROUND

WIRED CONNECTION

TIMER SWITCH, WATERPROOF

OUTDOOR LIGHT

GFI OUTLET, WATERPROOF

ELECTRICAL NOTES

- 1. ALL ELECTRICAL WORK SHALL CONFORM TO THE 2017 IEC AS WELL AS ALL ADOPTED STANDARDS, APPLICABLE STATE AND LOCAL CODES.
- 2. CONTRACTOR SHALL FURNISH AND INSTALL ALL CONDUIT, CONDUCTORS, PULL BOXES, TRANSFORMER PADS, POLE RISERS, AND PERFORM ALL TRENCHING AND BACKFILLING REQUIRED IN THE PLANS.
- 3. ALL ELECTRICAL ITEMS SHALL BE U.L. APPROVED OR LISTED AND PROCURED PER PLAN SPECIFICATIONS.
- 4. ALL CIRCUIT BREAKERS, FUSES, AND ELECTRICAL EQUIPMENT SHALL HAVE AN INTERRUPTION RATING NOT LESS THAN THE MAXIMUM SHORT CIRCUIT CURRENT TO WHICH THEY MAY BE SUBJECTED WITH A MINIMUM OF 10,000 A.I.C. OR AS REQUIRED.
- 5. THE ENTIRE ELECTRICAL INSTALLATION SHALL BE GROUNDED AS REQUIRED BY ALL APPLICABLE CODES.
- 6. ELECTRICAL WIRING SHALL BE COPPER #12 AWG MIN WITH TYPE THHN, THWN-2 OR
- THW-2, INSULATION RATED FOR 90°C DRY OR 70°C WET.
- 7. ALL OUTDOOR EQUIPMENT SHALL HAVE NEMA 3R ENCLOSURE. 8. ALL BURIED WIRE SHALL RUN THROUGH SCHEDULE 40 PVC CONDUIT UNLESS OTHERWISE NOTED.
- 9. A GROUND WIRE IS TO BE PULLED IN ALL CONDUITS.
- 10. WHERE ELECTRICAL WIRING OCCURS OUTSIDE A STRUCTURE AND HAS THE POTENTIAL FOR EXPOSURE TO WEATHER, WIRING SHALL BE IN WATERTIGHT GALVANIZED RIGID STEEL OR FLEXIBLE CONDUIT
- 11. WHERE PLANS CALL FOR A NEW ELECTRICAL SERVICE, PRIOR TO SUBMITTING BID, CONTRACTOR SHALL VERIFY PLAN DETAILS WITH THE UTILITY'S SERVICE PLAN & REQ'MTS INCLUDING SERVICE VOLTAGE, METER LOCATION, MAIN DISCONNECTING MEANS, AND AIC REQ'MT, AND SHALL OBTAIN CLARIFICATION FROM THE PROJECT ENGINEER ON ANY DEVIATIONS FOUND IN THESE PLANS.
- 12. WHERE THESE PLANS SHOW A DC POWER PLANT, THE INSTALLATION OPERATING AT LESS THAN 50 VDC UNGROUNDED, 2-WIRE, SHALL COMPLY WITH ARTICLE 720, AS FOLLOWS:
- A. POWER PLANT SHALL BE SUPPLIED BY THE WIRELESS CARRIER AS A PULL-TAG ITEM AND INSTALLED BY THE CONTRACTOR.
- B. CONDUCTORS SHALL NOT BE SMALLER THAN #12 AWG COPPER MIN, CONDUCTORS FOR BRANCH CIRCUITS SUPPLYING MORE THAN ONE APPLIANCE SHALL BE 10 AWG CU MIN: CONTRACTOR SHALL SIZE CONDUCTORS BASED ON MFGR'S DATA FOR THE APPLIANCES SERVED.
- C. THERE ARE NO DC RECEPTACLES OR LUMINARIES ALLOWED ON THIS PROJECT. ALL CIRCUITS SHALL ORIGINATE AT AN INTEGRATED DOUBLE LUG TAP OR SOCKET TERMINATION ON AN INTEGRATED DC CIRCUIT BREAKER AT AN INDIVIDUAL RECTIFIER MODULE AND TERMINATE AT THE SPECIALIZED LUG ON THE RESPECTIVE APPLIANCE AS A SINGLE RUN OF WIRE WITHOUT SPLICES. ALL DC WIRING SHALL BE LABELED AT THE DC PLANT WITH THE APPLIANCE SERVED AND THE DC VOLTAGE.
- D. ALL CABLING SHALL BE INSTALLED IN A NEAT AND WORKMAN LIKE MANNER AND SUPPORTED BY BUILDING STRUCTURE, EG. (N) CABLE TRAY OVERHEAD, IN SUCH A MANNER THAT THE CABLE WILL NOT BE DAMAGED BY NORMAL USE.

PANEL SCHEDULE

AMEPLATE :	PANEL A		SC	LEVEL	: 22,	000	VOLTS: 120	V/240V, 1ø	
OCATION: OL	ITSIDE						BUS AMF	PS: 200A	
MOUNTING: H-FRAME							MAIN CB: 200A		
ØA	ØB		BKR			BKR		ØA	ØB
LOAD VA	LOAD VA	LOAD DESCRIPTION	AMP/ POLE	CIRCL	IIT NO	AMP/ POLE	LOAD DESCRIPTION	LOAD VA	LOAD VA
30		SURGE ARRESTOR	60/2	1	2	30/2	(N) DC POWER PLANT	2292	
	30	22 22	""	3	4	""	n n		2292
2292		(N) DC POWER PLANT	30/2	5	6	30/2	n n	2292	
	2292	n n	""	7	8	""	n n		2292
2292		2) 2)	30/2	9	10	30/2	n n	2292	
	2292	27 27	""	11	12	17 27	n n		2292
2292		2) 2)	30/2	13	14	30/2	n n	2292	
	2292	27 27	""	15	16	17 27	n n		2292
2292		27 27	30/2	17	18	_	BLANK		
	2292	27 27	""	19	20	_	n n		
		BLANK	_	21	22	-	n n		
		" "	_	23	24	-	n n		
		" "	_	25	26	-	n n		
		" "	_	27	28	-	" "		
		" "	_	29	30	-	n n		
		23 23	_	31	32	_	n n		
		21 22	_	33	34	_	» »		
		27 27	_	35	36	_	27 27		
		27 27	_	37	38	_	27 27		
1000		(N) GEN. HEATER	20/1	39	40	20/1	LIGHTS		300
	300	(N) GEN. BATTERY CHARGER	20/1	41	42	20/1	GFI RECEPTACLE	180	
10198	9498	PHASE TOTALS					PHASE TOTALS	9348	9468
TOTAL VA =	38512	TOTAL AMPS =	160	0					
TOTAL KVA =	38.51								

Issued For:

FRESHWATER ROAD

250 MISTY HILL LANE EUREKA, CA 95503









MDG LOCATION ID: 5000920338 PROJECT ID: 17314976 DRAWN BY: SEAD CHECKED BY: N. GEORGE APPROVED BY: -

ISSUE STATUS							
1	03/05/25	CLIENT REV	S.D.				
4	08/19/24	CLIENT REV	T.T.				
3	07/25/24	CLIENT REV	T.T.				
2	07/03/24	ZD 100%	T.T.				
1	06/13/24	CLIENT REV	S.D.				
0	06/06/24	ZD 90%	-				
REV	DATE	DESCRIPTION	CAD				

PRELIMINARY: NOT FOR CONSTRUCTION

KEVIN R. SORENSEN

IT IS A VIOLATION OF LAW FOR ANY PERSON UNLESS THEY ARE ACTING UNDER THE DIRECTION OF A LICENSED PROFESSIONAL ENGINEER, TO ALTER THIS DOCUMENT.



ELECTRICAL PLAN

SHEET NUMBER:

E-1.1