GENERAL NOTES:

- 1. ALL DIMENSIONS ARE TO THE FACE OF PLYWOOD UNLESS OTHERWISE NOTED, (U.O.N.).
- 2. WRITTEN DIMENSIONS TAKE PRECEDENCE OVER SCALED DIMENSIONS. DO NOT SCALE THE
- 3. ALL NEW EXTERIOR WALLS TO BE 2x6 STUDS AT 16" O.C. WITH BATT INSULATION, PER TITLE 24 REPORT U.O.N.
- 4. ALL INTERIOR WALLS TO BE 2x4 STUDS AT 16" O.C. UNLESS OTHERWISE SHOWN. VERIFY WITH OWNER FOR LOCAITON OF ANY INTERIOR SOUND WALLS.
- 5. FLOOR SHEATHING TO BE 3/4" T&G EXTERIOR GRADE PLYWOOD GLUED AND FASTENED OVER 2x FLR JOISTS (W/ BATT INSULATION AS INDICATED)
- 6. ROOF SHEATHING SHALL BE 5/8" EXTERIOR GRADE PLYWOOD.
- 7. EXTERIOR WALL SHEATHING TO BE 17/32" OSB FASTENED TO STUDS PER SHEARWALL SCHEDULE.
- 8. WALLS TO BE 1/2 GYP. BOARD. PROVIDE 5/8" TYPE-X GYPSUM BOARD AT USABLE SPACE UNDER STAIR AND AT GARAGE WALLS & CEILING WHEN APPLICABLE.
- 9. ROOF INSULATION TO BE CLOSED CELL SPRAY APPLIED FOAM PER TITLE 24 REPORT.
- 10. ALL NEW WINDOWS AND GLASS IN EXTERIOR DOORS TO HAVE INSULATING GLASS.
- 11. GLAZING WITHIN 24" ARC OF EITHER VERTICAL EDGE OF A DOOR IN THE CLOSED POSITION SHALL BE TEMPERED. SAFETY GLAZING AT WALL, ENCLOSURE OR DOOR FOR TUB, SHOWER, SAUNA, ETC., INCLUDING WINDOW IF BOTTOM IS LESS THAN 60"ABOVE STANDING SURFACE. CRC \$R308 (ALL MEASUREMENTS ARE TO NEAREST EXPOSED EDGE OF
- 12. EMERGENCY EGRESS WINDOW OPENING AT BEDROOMS TO PROVIDE A MINIMUM CLEAR HEIGHT OF 24" AND A MINIMUM CLEAR WIDTH OF 20" WITH A TOTAL CLEAR OPENING AREA OF 5.7 SF MINIMUM, AND A MAXIMUM OF 44" A.F.F. TO BOTTOM OF CLEAR OPENING, WHEN APPLICABLE.
- 13. SMOKE DETECTORS ARE REQUIRED TO BE LOCATED IN EACH BEDROOM, AT HALLWAYS CENTRALLY LOCATED TO BEDROOMS, AND IN ADJACENT ROOMS TO HALLWAYS WHERE THE CEILING IS 2 FT. HIGHER THAN THE HALLWAY.

CODE COMPLIANCE DATA

GOVERNING CODES:

- 2022 CALIFORNIA BUILDING CODE (CBC) 2022 CALIFORNIA MECHANICAL CODE (CMC)
- 2022 CALIFORNIA PLUMBING CODE (CPC) 2022 CALIFORNIA ELECTRIC CODE (CEC)
- 2022 CALIFORNIA GREEN BUILDING CODE BUILDING TYPE:
- **OCCUPANCY:**
 - SINGLE FAMILY RESIDENCE

ZONING: RS-5-S7-Q/A,D

AREA TABULATION:

- GROUND FLOOR 682 SF 948 SF UPPER FLOOR TOTAL LIVING SPACE 1,630 SF
- 418 SF DECKS (2) 378 SF EACH **BUILDING FOOTPRINT** 1,100 SF
- TOTAL LOT COVERAGE

SOLAR PANEL EXCEPTION:

TOTAL LOT AREA

SOLAR PANELS ARE NOT INCLUDED IN THIS SUBMITTAL DUE TO THE INABILITY OF THE LOCAL POWER SUPPLIER (RID) TO INTER-CONNECT WITH INDIVIDUAL RESIDENSES IN SHELTER COVE. A LETTER FROM THE RID WILL BE PROVIDED TO THE COUNTY AND A COPY INCLUDED WITH THIS SUBMITTAL.

5,824 SF (0.13 ACRES)


LIST OF DRAWINGS & DOCUMENTS

- A1 SITE PLAN / CODE COMPLIANCE
- FOUNDATION PLAN / LOWER LEVEL FRAMING / TYPICAL DETAILS
- GROUND FLOOR PLAN / SHEAR WALL SCHEDULE & DETAILS
- FLOOR FRAMING PLAN / TYPICAL DETAILS
- A6 ROOF PLAN / TYPICAL DETAILS
- EXTERIOR ELEVATIONS
- **BUILDING SECTIONS**
- A9 INTERIOR ELEVATIONS / TYPICAL GLAZING DETAILS

UPPER FLOOR PLAN / TYPICAL DETAILS

- A10 TYPICAL DETAILS
- A11 LOWER & UPPER MECHANICAL & ELECTRICAL PLANS
- T24.1 CALIFORNIA ENERGY CALCULATIONS
- T24.2 CALIFORNIA ENERGY CALCULATIONS
- T24.3 MANDATORY MEASURES
- STRUCTURAL CALCULATIONS
- STORM WATER MITIGATION (L.I.D. CALCS)
- SOLAR PANEL EXCEPTION LETTER

<u>VICINITY</u> MAP

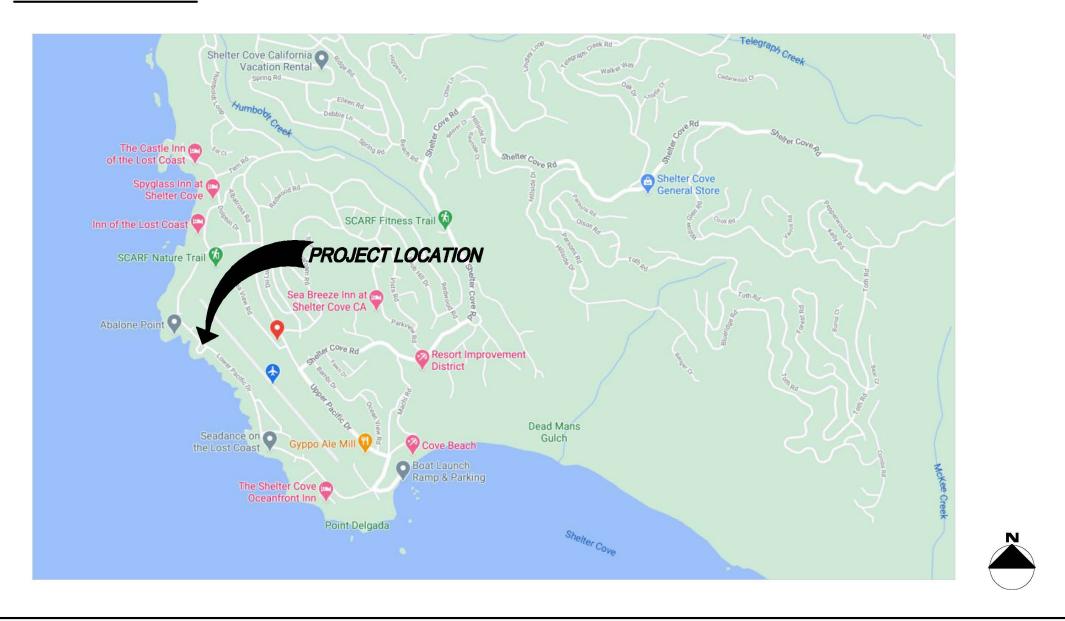



DANIELS RESIDENCE

495 SEA COURT SHELTER COVE, CALIFORNIA

APN 111-121-037

OWNER: DON DANIELS 22985 EL CAMINO REAL SANTA MARGARITA, CA 93453

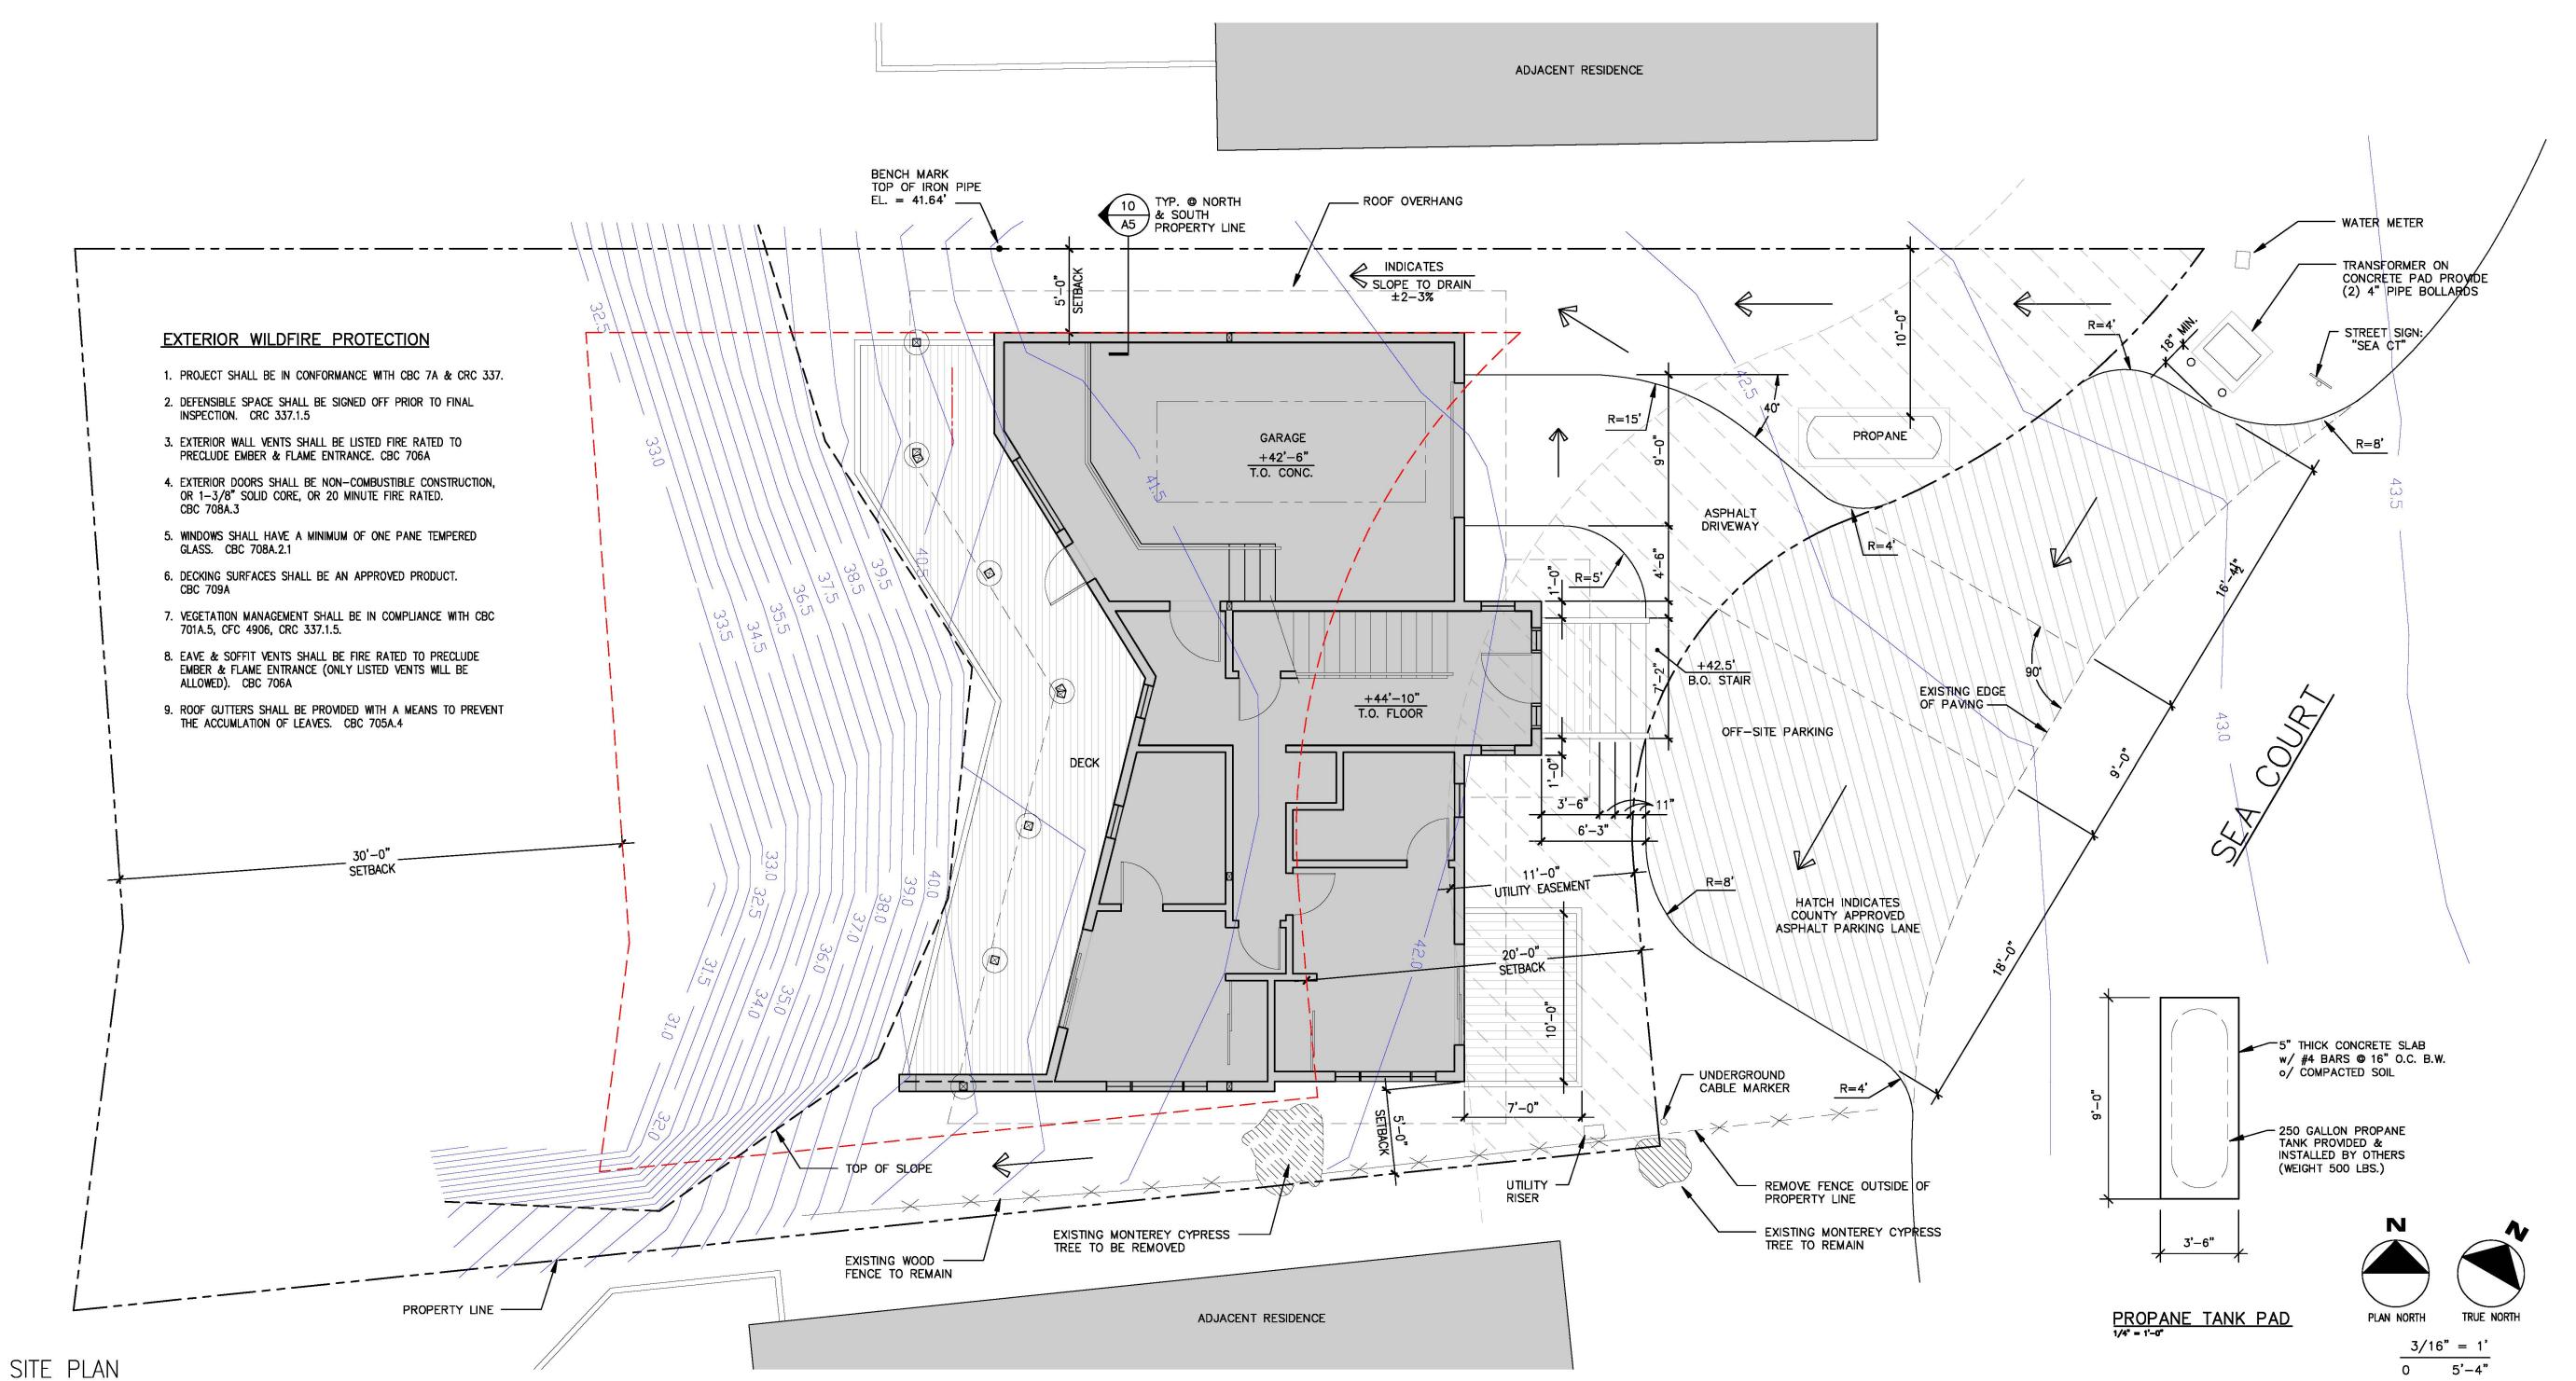

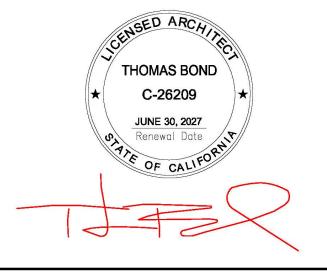



Thomas Bond & Associates 5432 Cummings Road Eureka, California 95503 707.442.1728 Office 707.362.1113 Cell

PROJECT NUMBER : 190

SCALE		: AS NOTED		
DRAWING	DATE	: 07.16.20	25	
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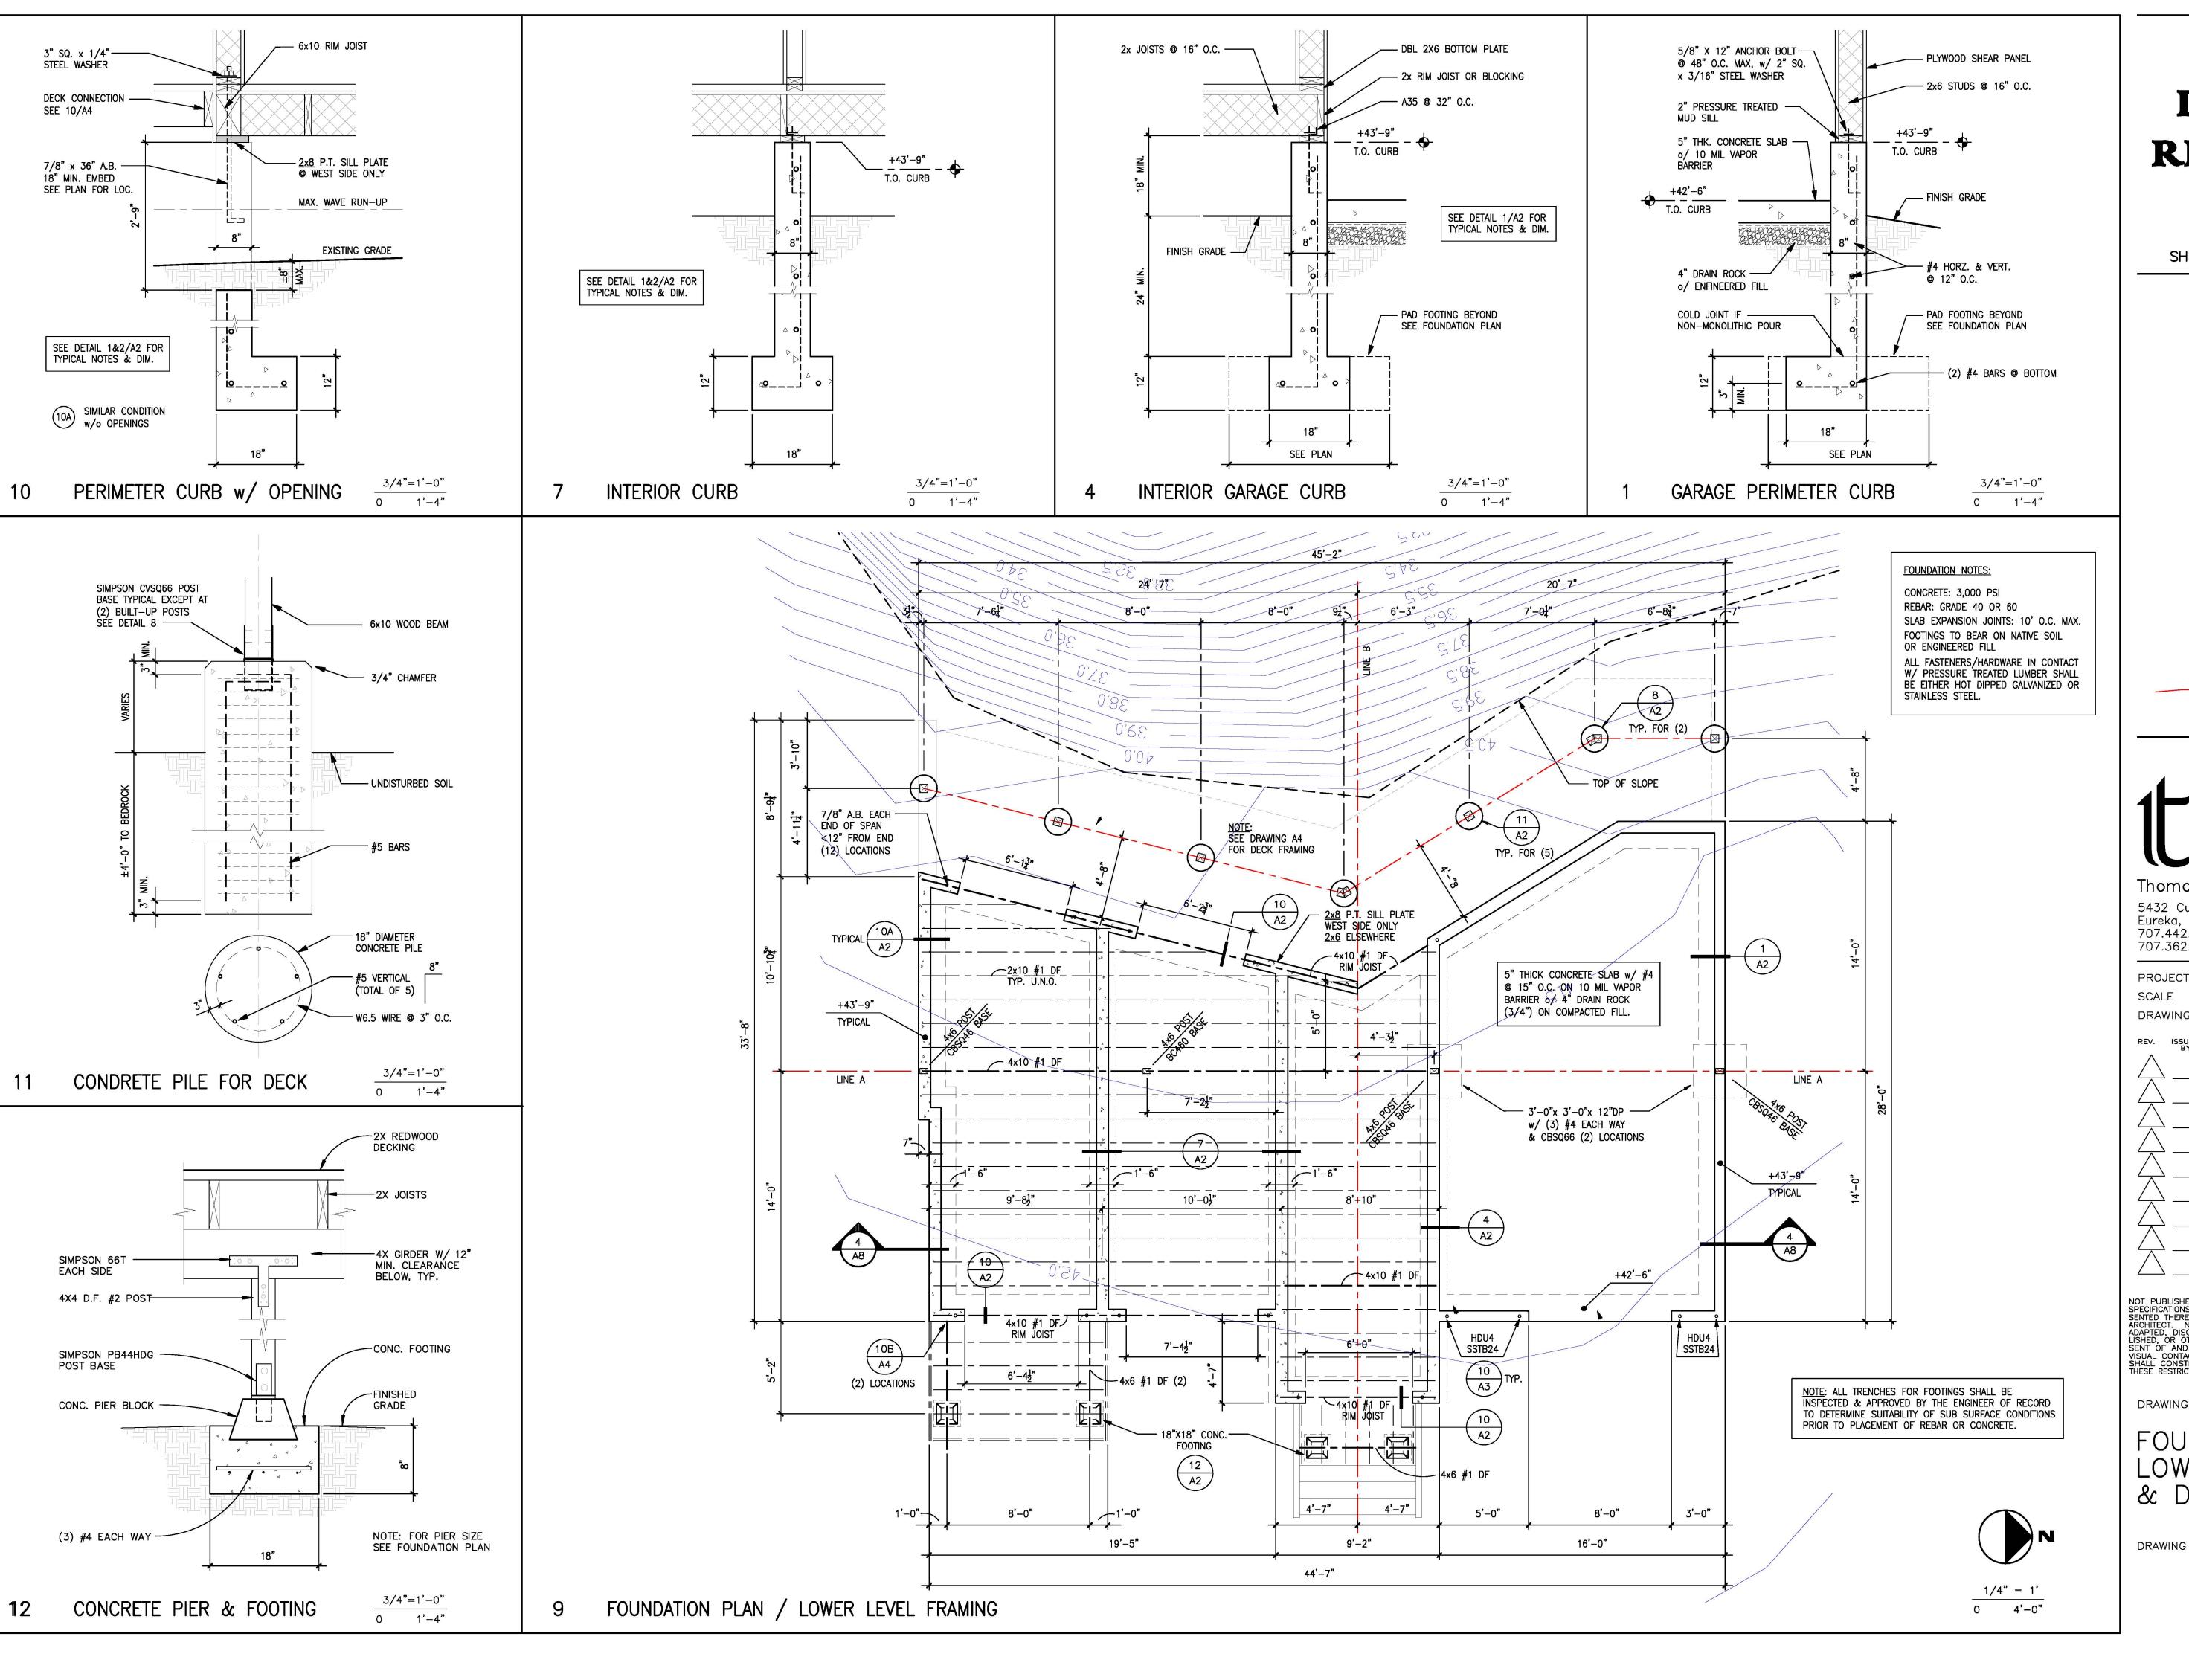
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DRAWING DESCRIPTION

SITE PLAN CODE COMPLIANCE GENERAL NOTES

DRAWING NUMBER

0 5'-4"



495 SEA COURT SHELTER COVE, CALIFORNIA

APN 111-121-037



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DRAWING DESCRIPTION

FOUNDATION PLAN LOWER FRAMING & DETAILS

SIMPSON HD 4x6 POST SEE PLAN SEE PLAN SIMPSON BP SIMPSON SSTB (AS REQ'D FOR (SEE FDN. PLAN) HD - SEE PLAN) 2x6 P.T. MUD SILL SSTB ANCHOR (SEE FOUNDATION PLAN) CONTINUOUS CONCRETE FOOTING DEEPEN FTG. AS REQ'D FOR SSTB'S 24" (MIN)

LARGER THAN 2x)

2x BLOCKING

2x WALL STUDS AT 16" O.C.

TYP. @ SHEAR-WALLS

STRUCTURAL NOTES

- 1. TYPICAL SHEARWALL FASTNERS: 8d COMMON OR GALVINIZED BOX NAILS (NO SINKERS), 6" EDGE NAILING AND 12" FIELD NAILING UNLESS OTHERWISE SPECIFIED ON FLOOR PLANS. SEE SHEARWALL NOTATION FOR EDGE NAILING AND ANCHOR BOLT SPACING REQUIREMENTS.
- 2. ANCHOR BOLTS MUST BE 5/8"X12" SPACED 48" OC UNLESS OTHERWISE SPECIFIED ON FOUNDATION OR FLOOR PLAN. 3"X3"X0.229" PLATE WASHERS REQUIRED AT MUD SILL.
- 3. LAG BOLTS MUST BE 1/2" DIAMETER. ADJUST LENGTH FOR 2" PENETRATION INTO JOIST. PRE-DRILL 3/8" HOLE FOR LAG. PROVIDE WASHER.
- 4. STRAPS AND HOLD-DOWNS MUST RUN CONTINOUS TO WALLS BELOW, IF NO WALLS BELOW, TIE TO BEAMS.
- 5. TYPICAL DIAPHRAGM FASTNERS: 8d COMMON NAILS AT ROOF, 10d COMMON NAILS AT FLOOR (NO SINKERS), 6" EDGE NAILING, 12" FIELD NAILING AT ROOF / 6" EDGE NAILING, 8" FIELD NAILING AT FLOOR.
- 6. PROVIDE CONTINOUS RIM RAFTER/JOIST AT ALL DIAPHRAGMS.
- 7. PROVIDE CONTINOUS RIM JOIST/RAFTER OR SOLID BLOCKING AT ALL SHEARWALL GRID LINES.
- 8. BETWEEN BLOCKS OR BREAKS IN RAFTERS/JOISTS PROVIDE STRAPS TO MAINTAIN TIE CONTINUITY.
- 19. ALL EXTERIOR HEADERS MUST BE MINIMUM 4X6 (flat) OR (3) 2X6 #2 D.F.
- 10. ALL CONSTRUCTION MUST MEET 2022 CBC STANDARDS.
- 11. FOR ANY DETAILS NOT SHOWN, REFER TO CBC SECTION 2308, "CONVENTONAL LIGHT-WEIGHT FRAME CONSTRUCTION".
- 12. REFER TO 12/A4 FOR MINIMUM NAILING SCHEDULE AND ADDITIONAL MECHANICAL FASTENER NOTES.


SHE	SHEARWALL SCHEDULE									
SHEARWALL	SHEATHING	NAIL SIZE	EDGE NAIL	FIELD NAIL	§"x12" A.B. SPACING	Blocking Req'd	POST © PANEL EDGES	MUDSILL	SILL PLATE	NOTES
1 SW	5/8* CDX/OSB	10d	4"	12*	24"	YES	4 X	2X	2X	HDU4 w/ SSTB24 HOLDDOWNS
2 sw	1/2" CDX/OSB	8d	4"	12*	24"	YES	(2) 2X	2X	2X	
3 sw	1/2" CDX/OSB	8d	6"	12"	48"	NO	3X	2X	2X	

STRUCTURAL MATERIAL PROPERTIES

FRAMING LUMBER FOR NEW CONSTRUCTION MUST BE SOLID SAWN D.F. GRADE #2 OR BETTER.

- PRESSURE TREATED FRAMING LUMBER MUST BE HEM-FIR GRADE #2 OR BETTER.
- 3. SHEATHING MUST BE 17/32" OSB OR 1/2" CDX PLYWOOD U.N.O.
- 4. ROOF DIAPHRAGMS MUST BE 5/8" CDX PLYWOOD.
- CONNECTORS, STRAPS, HOLD-DOWNS, ANCHORS, AND CLIPS MUST BE MANUFACTURED BY SIMPSON STRONG-TIE CO. AND COMPLY WITH THE PROPERTIES IN THE CURRENT CATALOG.
- ALL FASTNERS/ANCHOR BOLTS CONNECTED TO PRESSURE TREATED LUMBER MUST BE HOT DIPPED ZINC-COATED GALV.

SHEARWALL SCHEDULE & STRUCTURAL NOTES

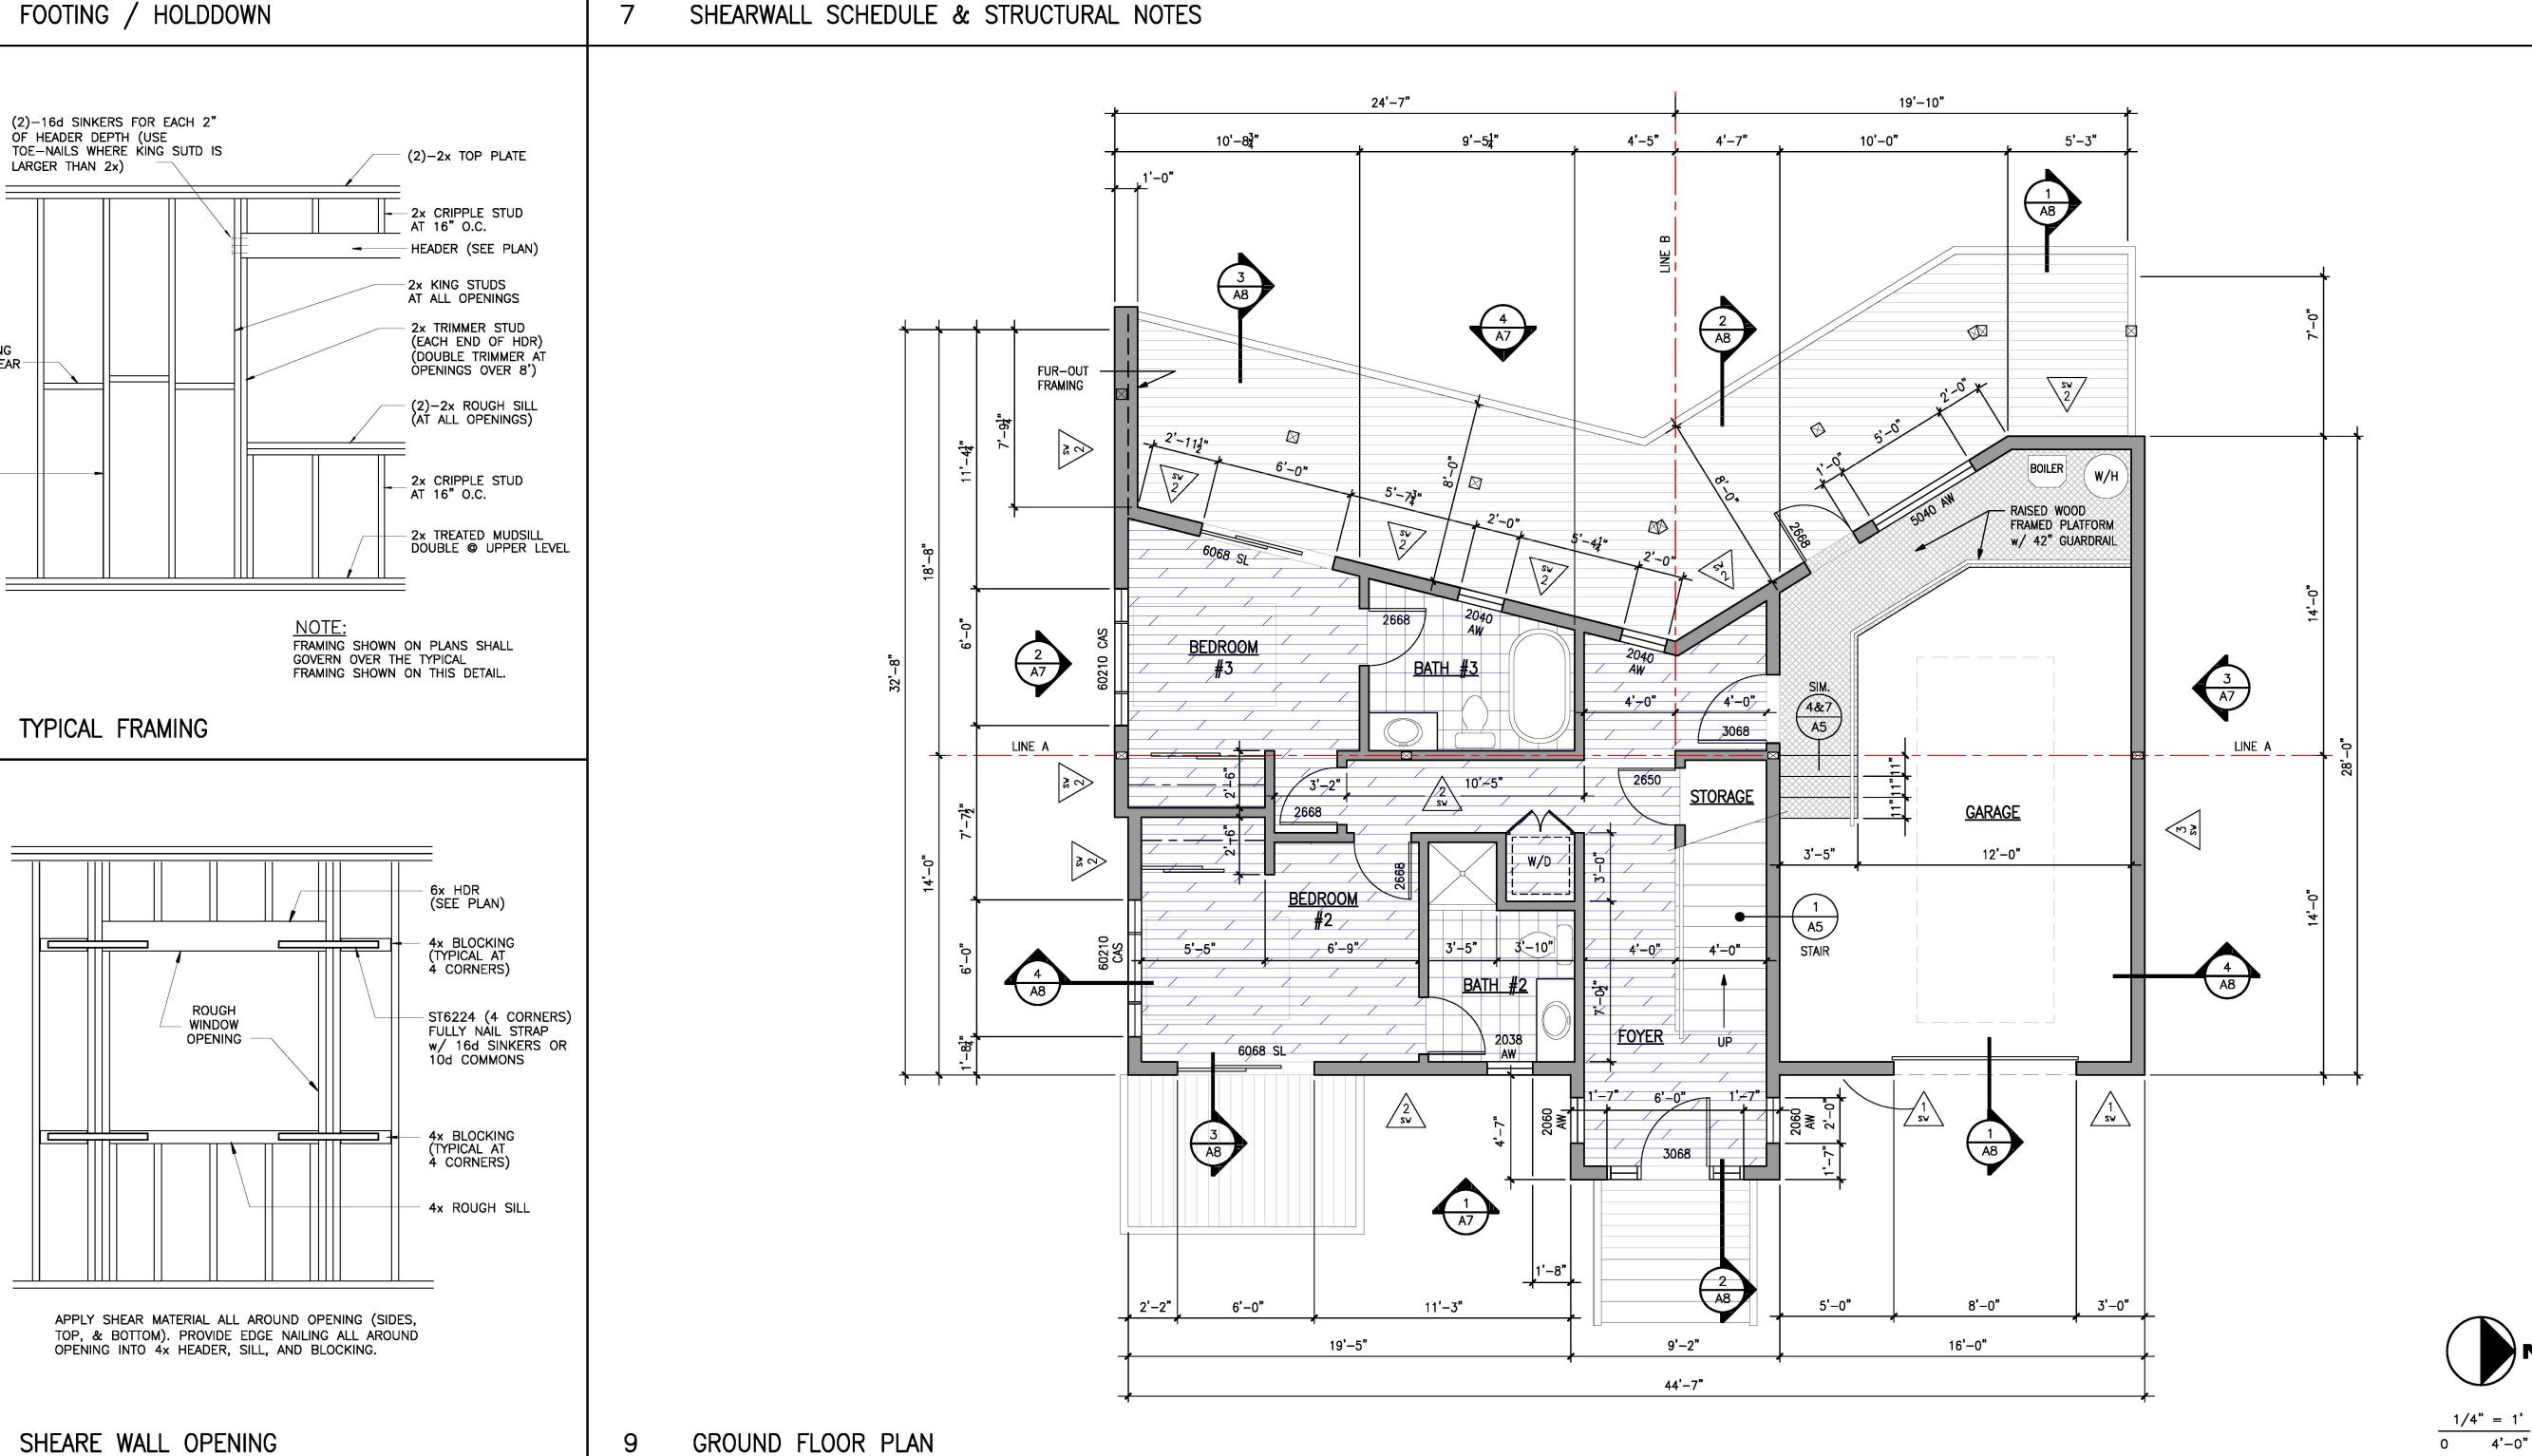



495 SEA COURT SHELTER COVE, CALIFORNIA

APN 111-121-037



Thomas Bond & Associates


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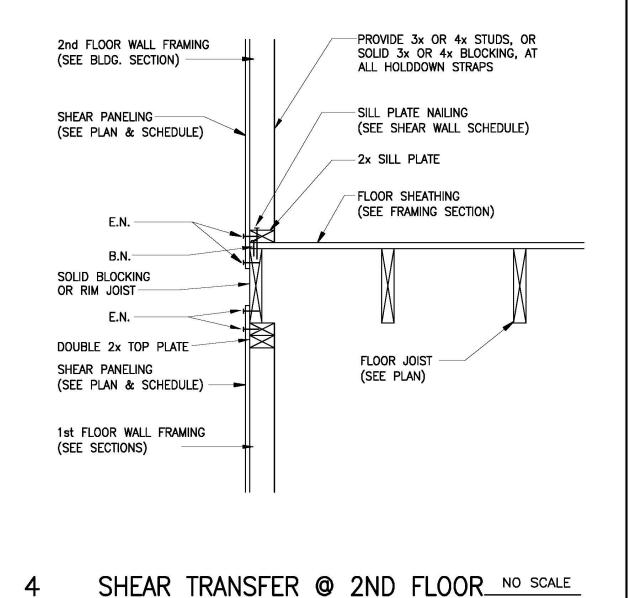
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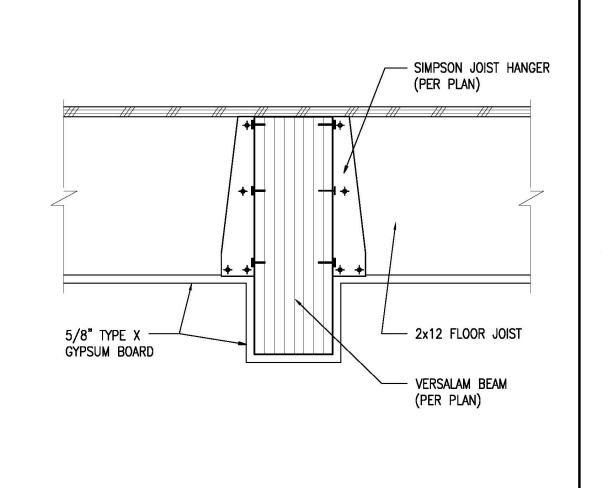
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DRAWING DESCRIPTION

GROUND FLOOR PLAN & DETAILS





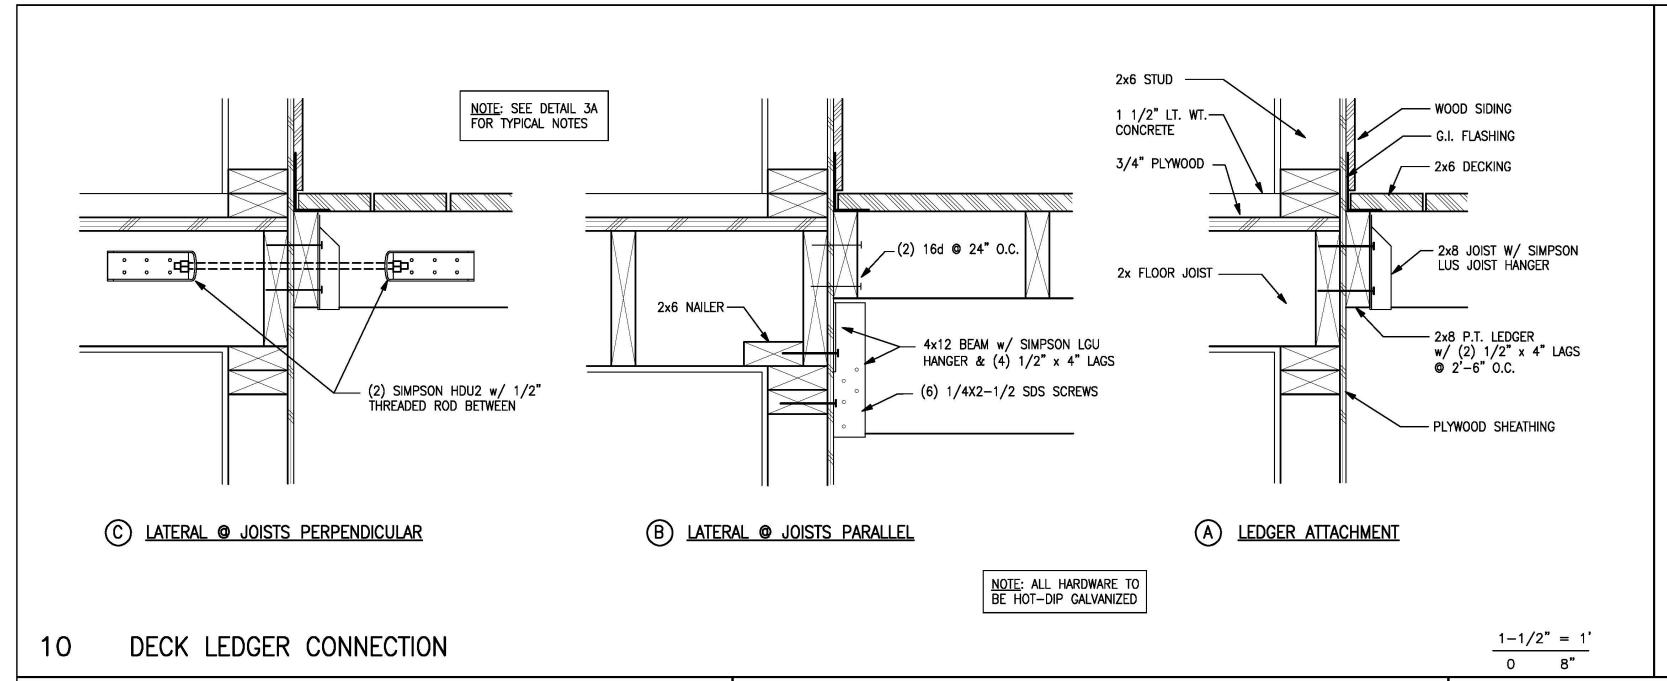

NO SCALE

BEAM IN GARAGE

DANIELS RESIDENCE

495 SEA COURT SHELTER COVE, CALIFORNIA

APN 111-121-037

MINIMUM NAILING SCHEDULE

- All structural nailing must be common wire. Alternate fasteners may be substituted as approved by the Engineer.
- 2. For wood to wood joints, the spacing of nails must not be less than the required nail penetration. Edge or end distances must not be less than ½ the required nail penetration. Where pre-drilling is required to avoid splitting of the wood, the hole diameter must not exceed three-fourths of the nail diameter.
- Nailing not noted below or on the project plans must be a minimum of 2 nails at each contact, 8d for 1x members and 16d for 2x members.
- 4 Joists or Rafters:

4.	Joists or Rafters:	
	a. Bearing (sill, girder, top plate) Toe Nail	3-8d
	b. Laps (parallel members over walls or beams) Face Nail	4-16d
	For each additional 3" member depth beyond 6"	
	member add	2-16d
	c. Rim joist to floor joist, End Nail	2-16d
	For each additional 4" member depth beyond 8"	
	member add	1-16d
	d. Rim joist to top plate, Toe Nail	8d @ 6" OC
	e. Double joists under bearing walls, staggered Face Nail	. 16d @ 1'-0" 00
5.	Studs:	
	a. Double studs, Face Nail	16d @ 2'-0" OC
	b. Top plate to stud, End Nail	2-16d
	c. Stud to sole plate, Toe Nail	3-16d or 4-8d
	d. Sole plate to stud, End Nail	2-16d
	e. Stud to continous header, Toe Nail	3-16d or 4-8d
	f. Built-up corner studs, Face Nail	16d @ 2'-0" 00
6.	Plates:	
	a. Top plate doubled, Face Nail	16d @ 1'-4" 00
	b. Top plate intersection, Face Nail	2-16d
	c. Sole plate to rim joist or blocking, Face Nail	16d @ 1'-4" 00
	d. Sole plate to floor framing, Face Nail	16d @ 1'-4" 00
7.	Blocking:	
	a. To studs, joists or rafters, Toe Nail	3-16d or 4-8d
	or End Nail	2-16d
	For each additional 4" member depth	
	beyond 8" member add, Toe Nail	2-8d

MECHANICAL FASTNER NOTES

b. To plates, Toe Nail

- 1. The clearance holes for lag screw shanks must be the same diameter and depth as the unthreaded shank. The lead hole for the threaded portion must be of a diameter equal to 60% of the shank diameter for screws up to ½" diameter, and 75% of the shank diameter for larger lag screws. The lead hole must be at least the length of the threaded portion.
- 2. Lag screws must be turned into pre-drilled holes and not be driven.
- All bolts and lag screws must be tightened and retightened before closing in, or at completion of job.

or End Nail


8. 2" Subfloor to each joist or girder one blind and one Face Nail.

16d @ 1'-0" OC

 All bolts and lag screws must be provided with metal washers under heads and nuts which bear on wood.

MININ	MUM WASHER FOR BO	LTS & LAG SCREWS
Size	Malleable Iron Washer	Steel Plate Washer
1/2" Ø	21/2" Ø × 1/6"	2" × 2" × 1/4"
5%" Ø	2¾" Ø × 1/6"	2" × 2" × 1/4"
¾" Ø	3" Ø × 1/16"	2" × 2" × 1/4"
%" Ø	35%" Ø × 3%"	3" x 3" x 1/4"
1" Ø	4" Ø x ½"	3" × 3" × 1/4"

- Place under Bolt Heads & Nuts bearing on Wood
- 5. Fastener alternatives for non-bearing and non-shear walls:
 Two minimum per member and at 9" from ends.
 a. 1/8" Ø Powder driven anchor with 1" penetration @ 2'-0" OC.
 b. 1/4" Ø expansion anchorage device embedded 11/2" minimum
- c. $\frac{1}{2}$ Ø anchor bolt with $\frac{2}{2}$ embedment @ 4'-0" OC.
- 6. Equivalent mechanical fasteners may be submitted to the Engineer for approval.

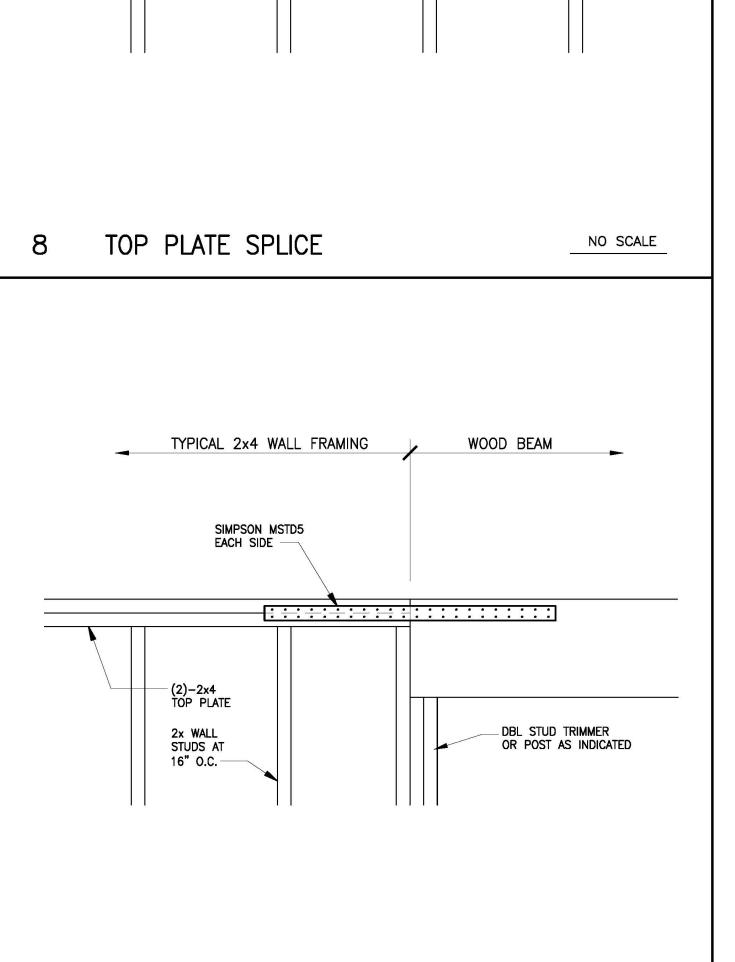

WALL FRAMING TO BEAM STRAPS

48" MIN.

(8)-16d MIN. AT SPLICE


-(4)-16d EACH SIDE OF SPLICE


STUDS AT 16" O.C. —

SPLICE TO OCCUR OVER WALL STUD

> (2)–2x4 TOP PLATE

> > NO SCALE

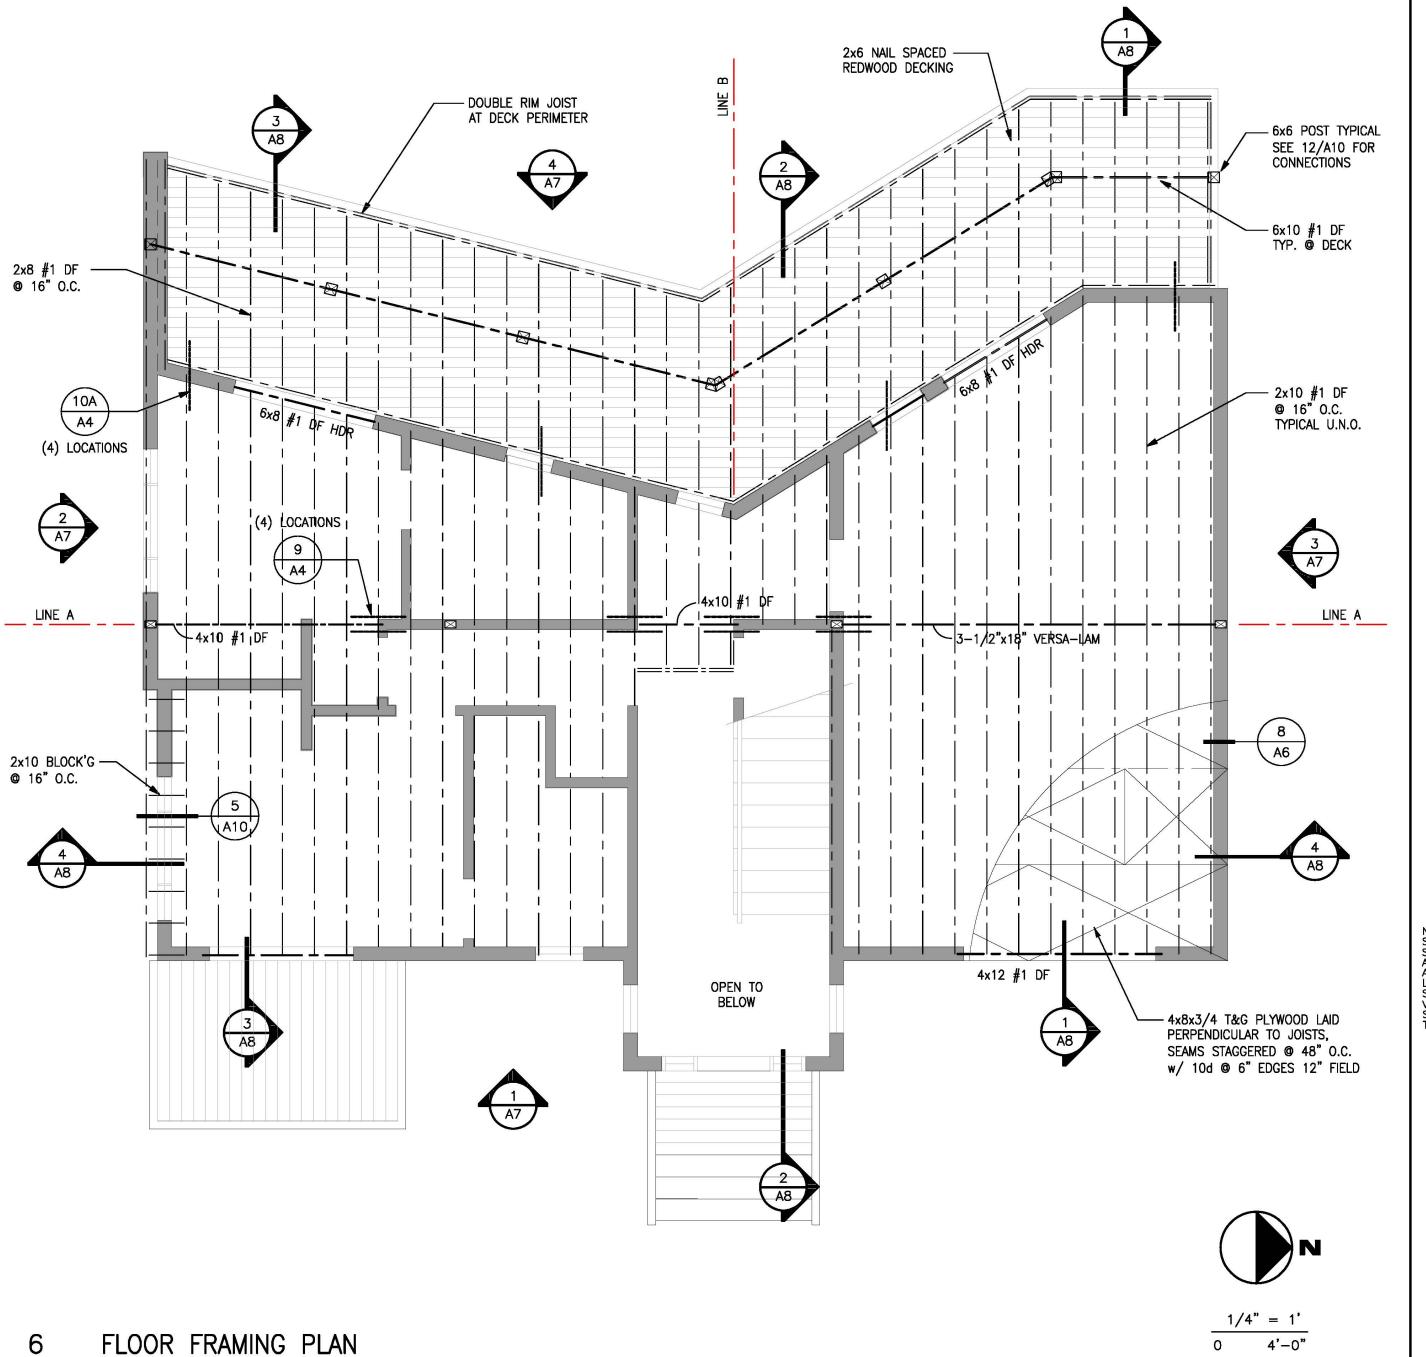

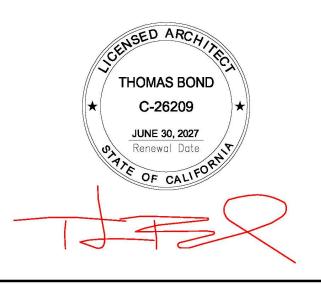



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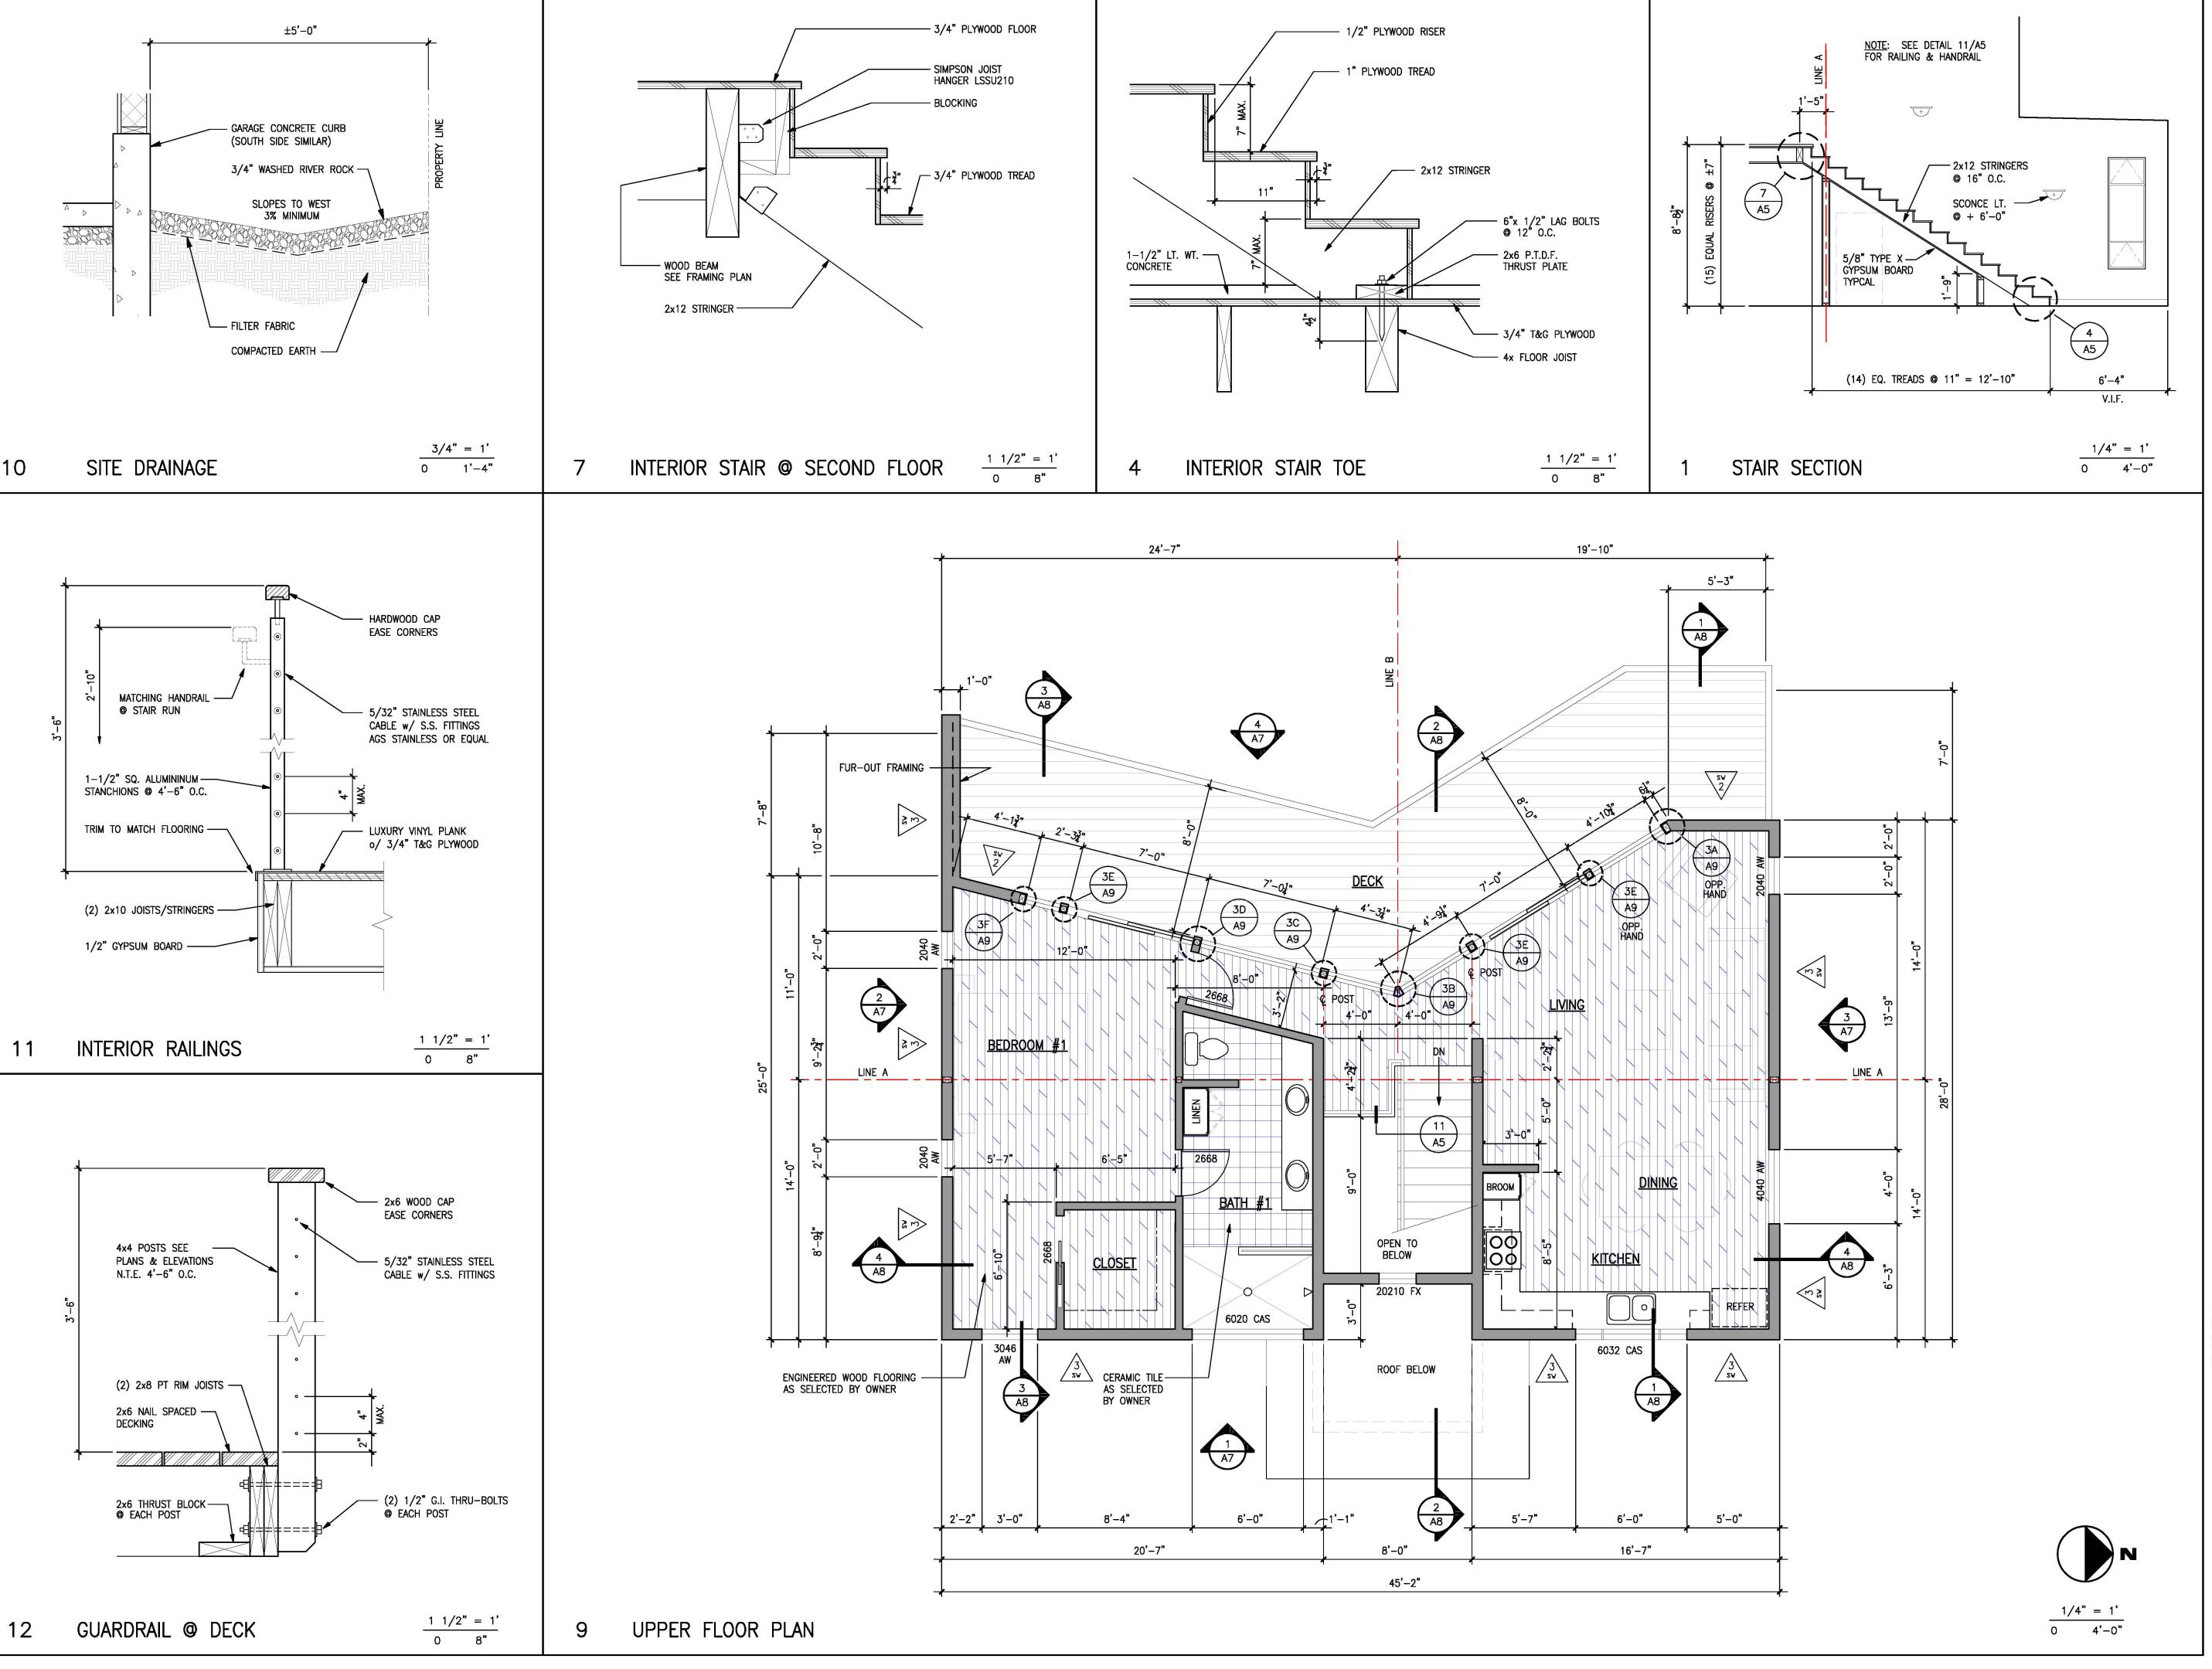
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UPPER LEVEL FRAMING PLAN & DETAILS

DRAWING NUMBER

A4

12 NAILING & FASTENER REQUIREMENTS



495 SEA COURT SHELTER COVE, CALIFORNIA

APN 111-121-037



Thomas Bond & Associates
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Eureka, California 95503
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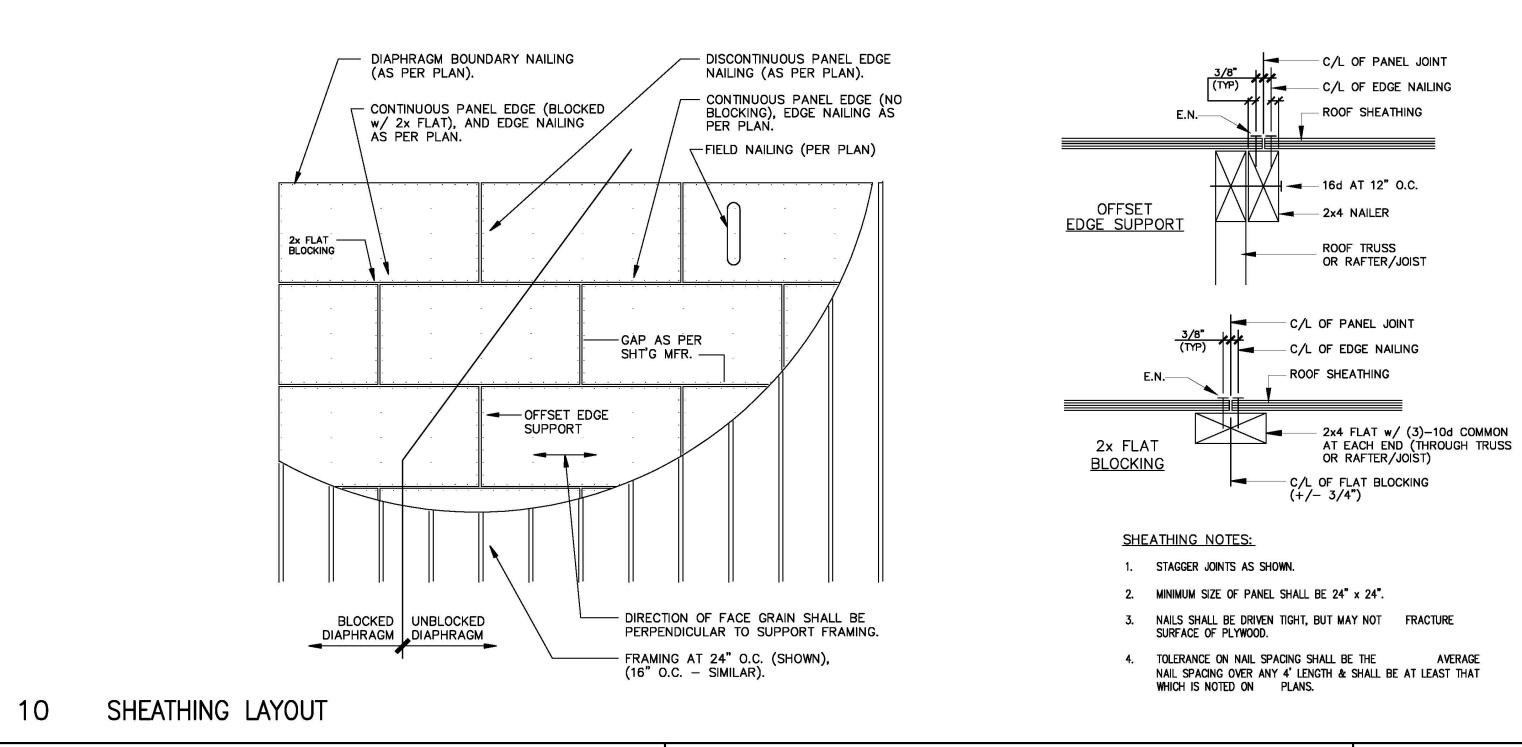
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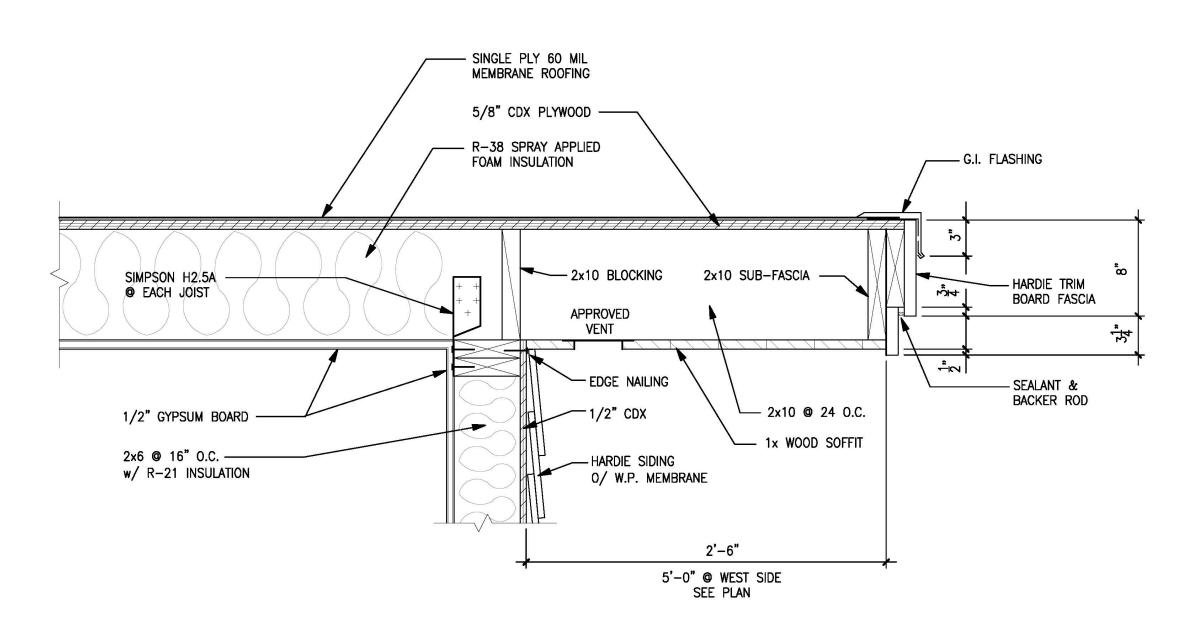
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UPPER FLOOR PLAN & DETAILS

DRAWING NUMBER

A5





TYPICAL EAVE & ROOF ASSEMBLY

 $1 \ 1/2" = 1'$ 0 8'

> 2x10 RAFTERS @ 24" O.C. TYPICAL

3 A7

4x16 BEAM, TYPICAL

 $\frac{1/4" = 1'}{0 \quad 4'-0"}$

SINGLE PLY MEMBRANE

ROOFING

1 A7

ENTRY ROOF BELOW

ROOF PLAN

2 A8

USED ARCHITE THOMAS BOND C-26209 JUNE 30, 2027

DANIELS

RESIDENCE

495 SEA COURT SHELTER COVE, CALIFORNIA

APN 111-121-037



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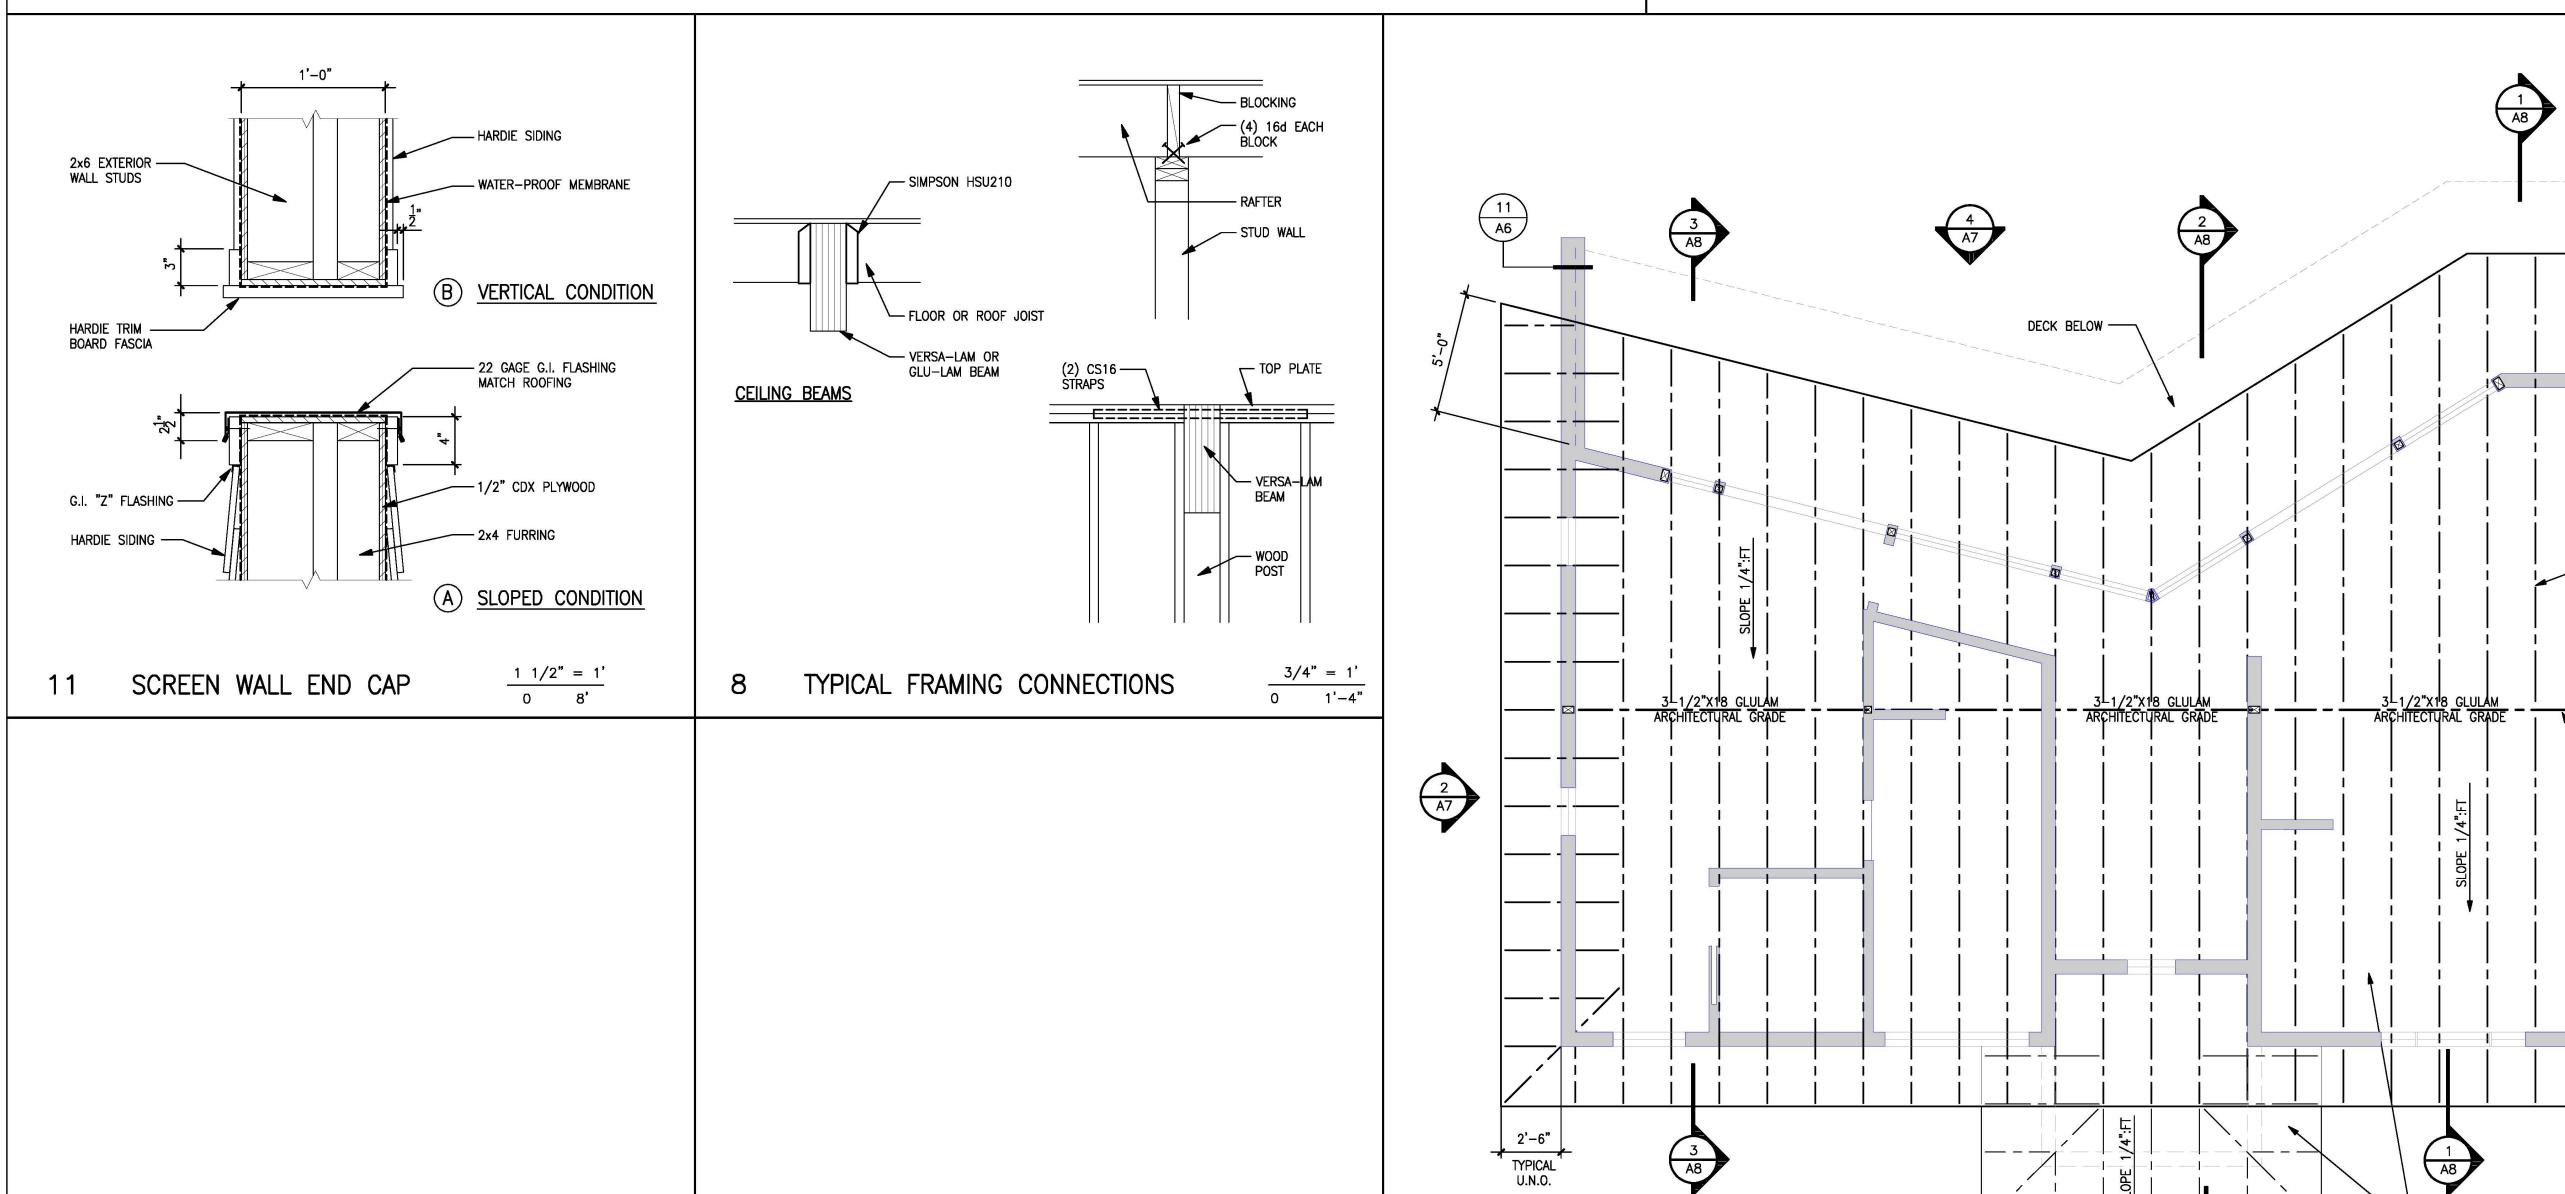
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DRAWING DESCRIPTION

ROOF FRAMING PLAN & DETAILS



HARDIE FIBER CEMENT LAP SIDING - SELECT CEDARMILL SINGLE PLY MEMBRANE ROOFING "CHARCOAL" - HARDIE CEMENT FIBER TRIM BOARD FASCIA "IRON GRAY" TYP. HARDIE FIBER CEMENT LAP SIDING - SELECT CEDARMILL "GRAY SLATE" "GRAY SLATE" 4'-0" HARDIE 5/4 x 3" FIBER CEMENT TRIM TYPICAL, MATCH ADJACENT SIDING - HARDIE STAGGERED EDGE FIBER CEMENT SHINGLES HARDIE CEMENT FIBER -"NIGHT GRAY" TRIM BOARD FASCIA "IRON GRAY" TYP. (A10) T.O. PLYWOOD A10 "BOOTHBAY BLUE" STAINLESS STEEL CABLE RAILING W/ WOOD POSTS & CAP WOOD POST, BEAM & PILE BEYOND 11 A10 +42'-6" MAXIMUM ESTIMATED WAVE RUN-UP INCLUDING PROJECTED SEA LEVEL RISE - HARDIE PANEL VERTICAL SIDING — SELECT CEDARMILL HARDIE STAGGERED EDGE — FIBER CEMENT SHINGLES WOOD STEPS (1) FOUNDATION OPENING -& PORCH (3) LOCATIONS - PROVIDE (A10) "BOOTHBAY BLUE" "NIGHT GRAY" REMOVABLE 1/4x1/4 SCREEN 10 A5 LUX GARAGE DOOR: ---SECTIONAL OVERHEAD INSULATED WOOD "EMELIO" SOLID WESTERN CEDAR STAIN GRADE, UNFINISHED <u>2 – SOUTH ELEVATION</u> <u>1 – EAST ELEVATION</u> – HARDIE FIBER CEMENT LAP —— SIDING – SELECT CEDARMILL HARDIE CEMENT FIBER TRIM -BOARD FASCIA PROJECT NUMBER : 190 "GRAY SLATE" "IRON GRAY" TYP. - HARDIE CEMENT FIBER TRIM BOARD FASCIA "IRON GRAY" TYP. SCALE A6 STAINLESS STEEL CABLE — RAILING W/ WOOD POSTS & CAP SLOPED HARDIE STAGGERED EDGE — FIBER CEMENT SHINGLES "NIGHT GRAY" 11B A6 VERTICAL STAINLESS STEEL CABLE RAILING W/ WOOD POSTS & CAP A10 CONCRETE PILES -+42'-6' MAXIMUM CONCRETE PILES WAVE RUN-UP HARDIE PANEL VERTICAL SIDING - SELECT CEDARMILL "BOOTHBAY BLUE" FOUNDATION OPENING ---(3) LOCATIONS - PROVIDE "BOOTHBAY BLUE" REMOVABLE 1/4x1/4 SCREEN <u>3 – NORTH ELEVATION</u> <u>4 – WEST ELEVATION</u> $\frac{1/4" = 1'}{0 \quad 4'-0"}$ EXTERIOR ELEVATIONS

DANIELS RESIDENCE

495 SEA COURT SHELTER COVE, CALIFORNIA

APN 111-121-037




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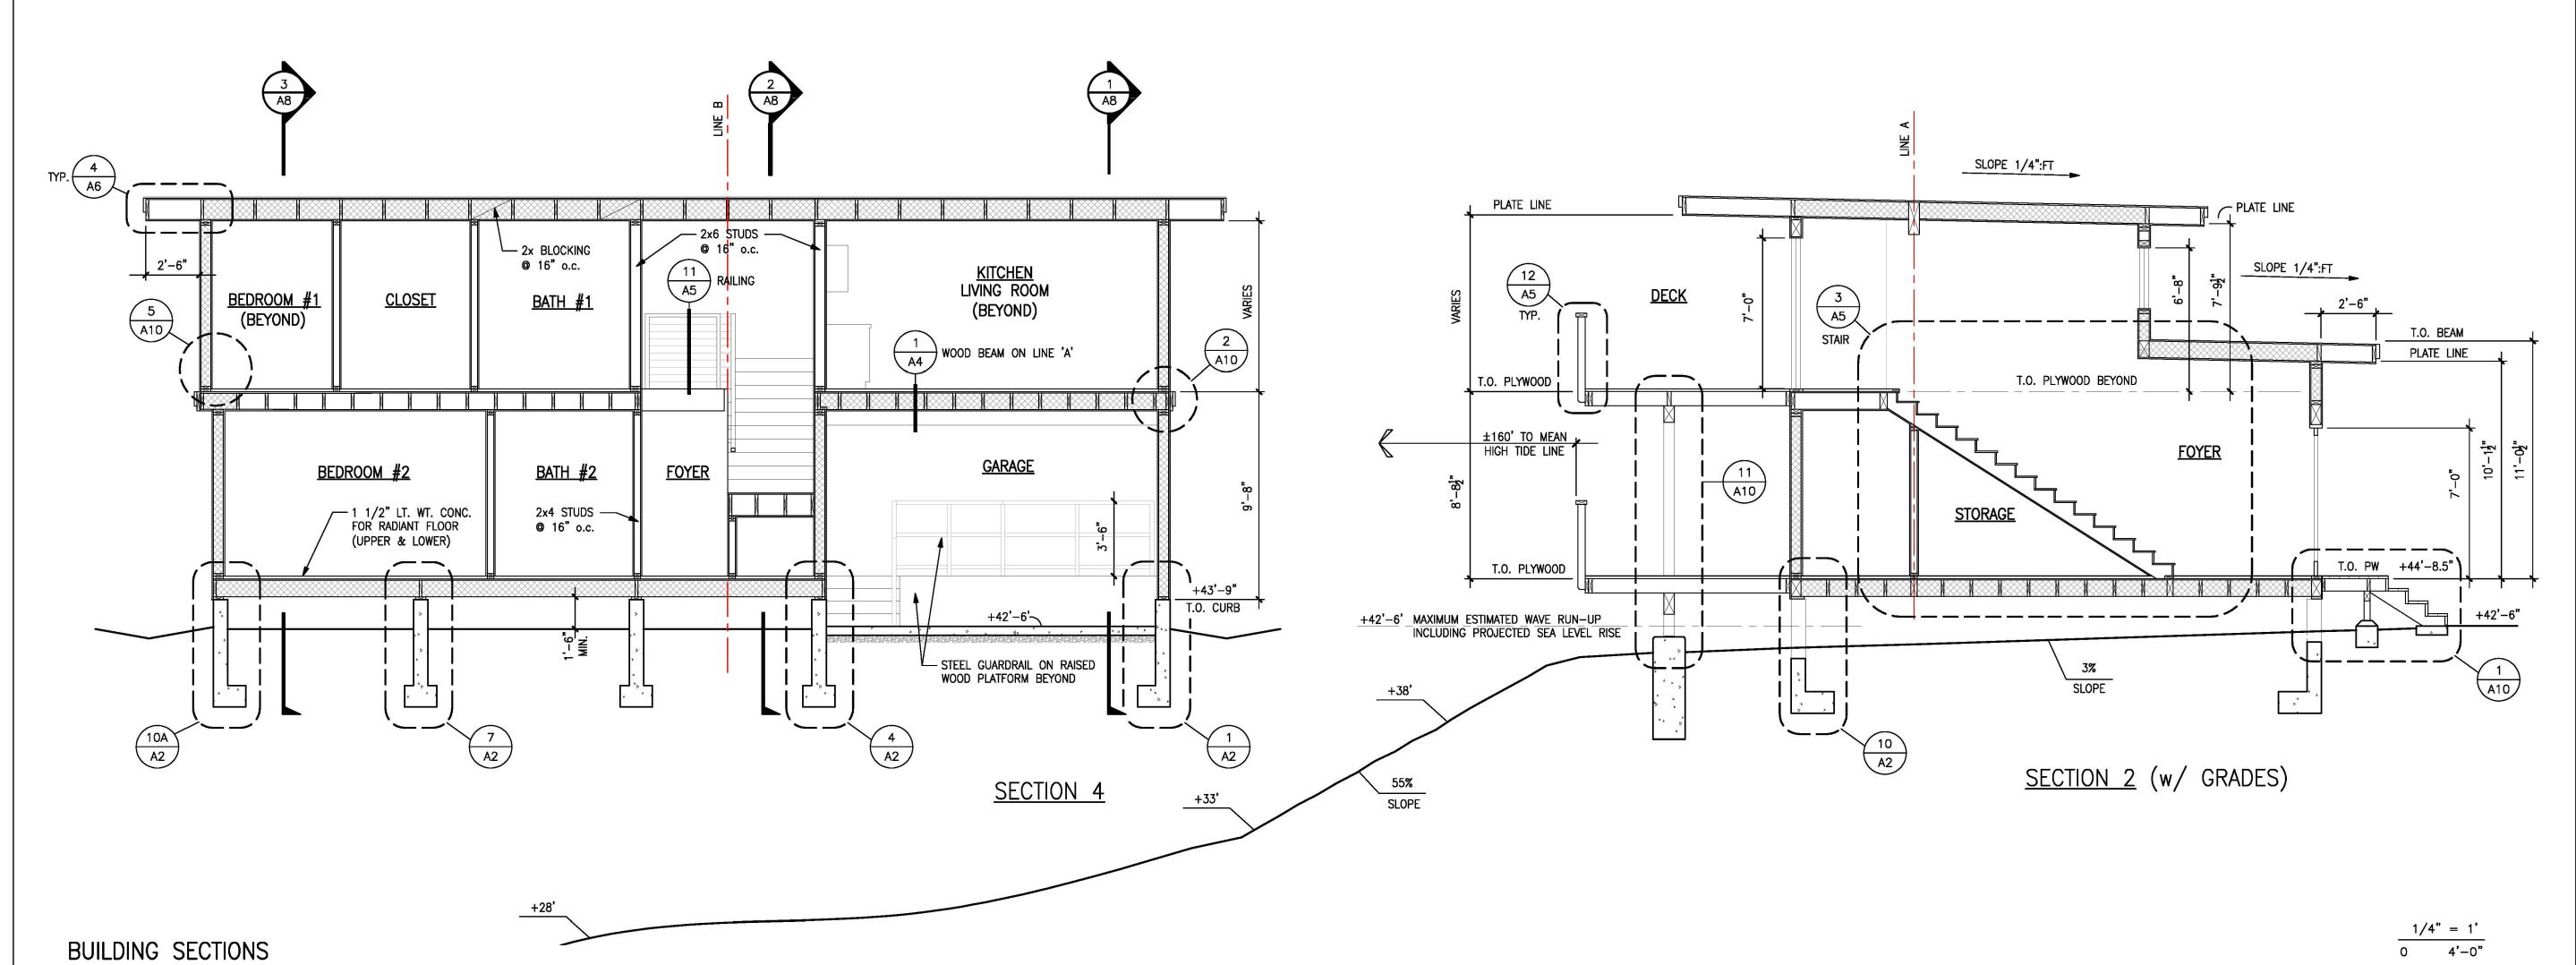
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DRAWING DESCRIPTION

EXTERIOR ELEVATIONS





495 SEA COURT SHELTER COVE, CALIFORNIA

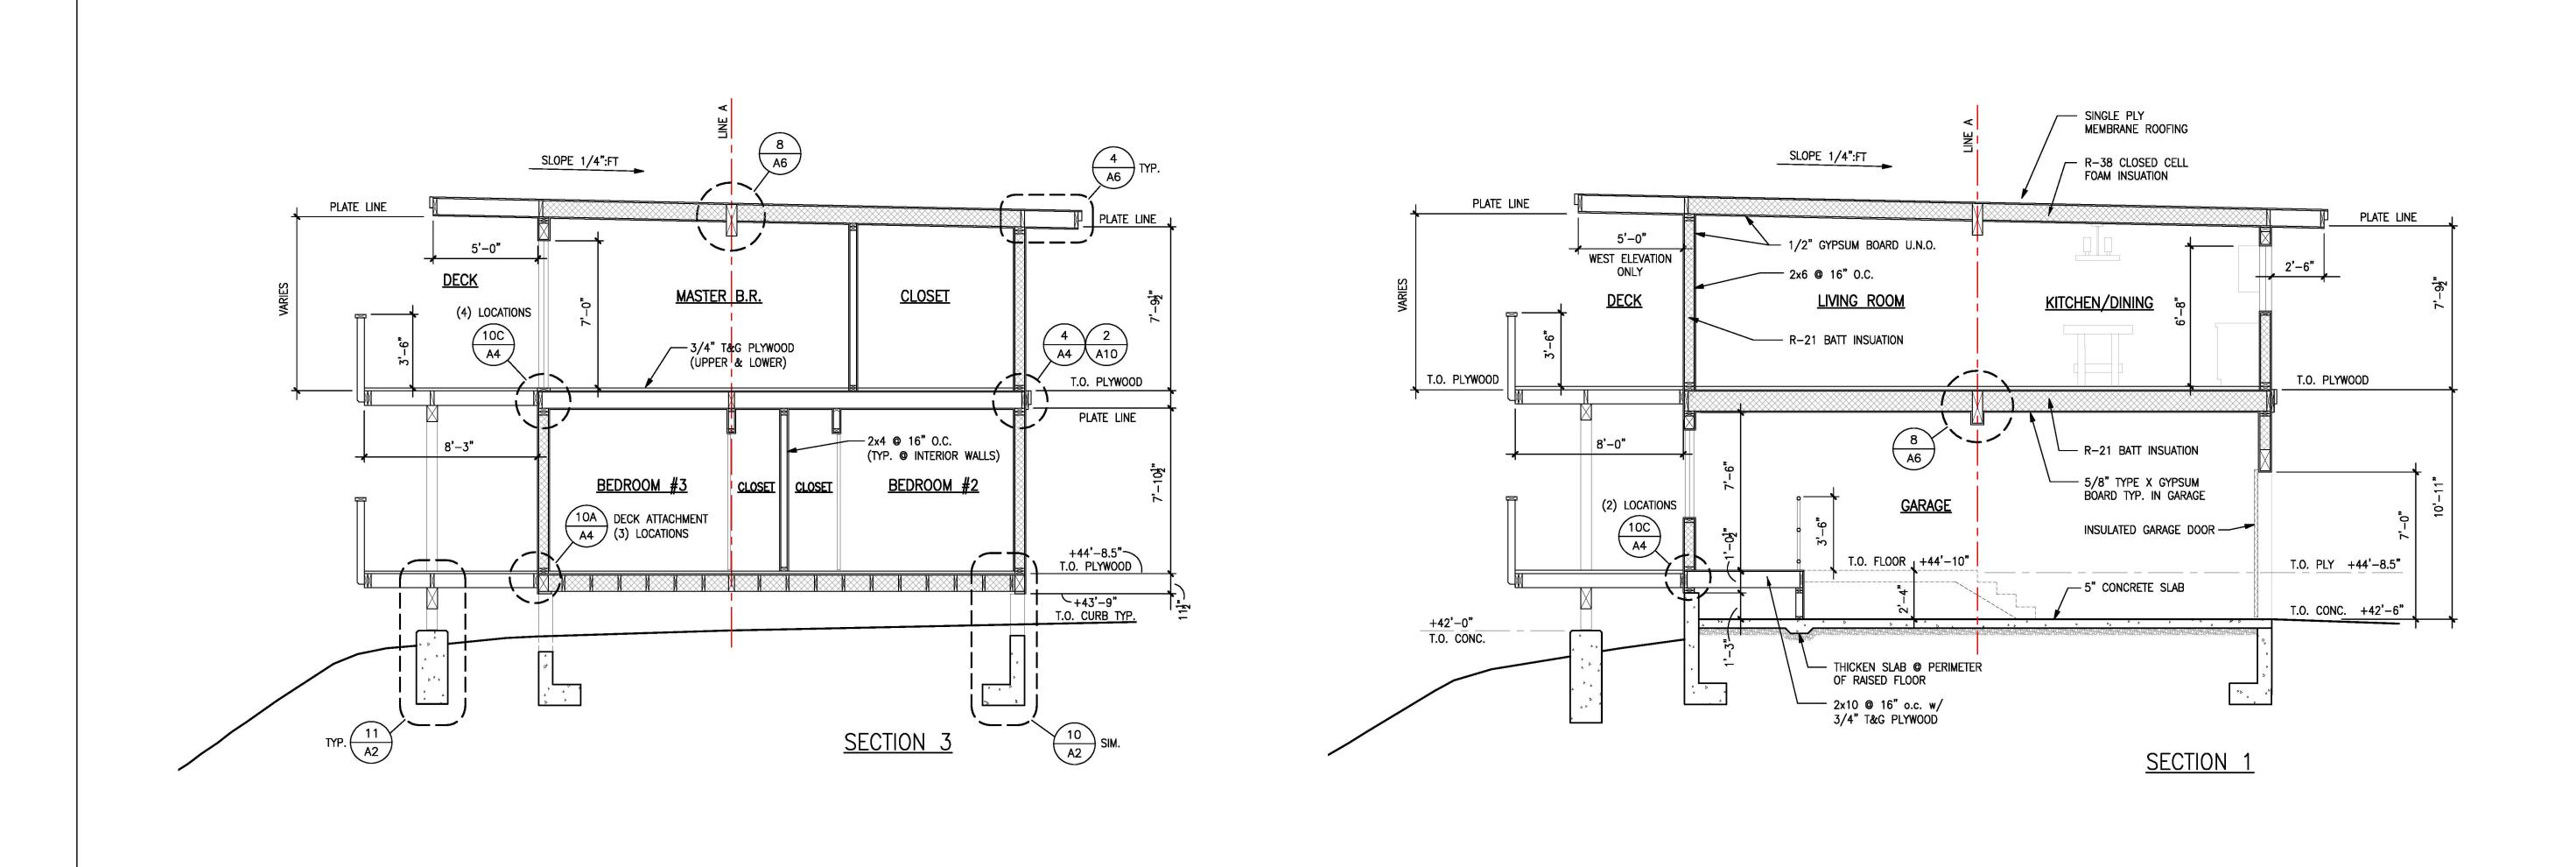APN 111-121-037



Thomas Bond & Associates 5432 Cummings Road Eureka, California 95503 707.442.1728 Office 707.362.1113 Cell


PROJECT NUMBER : 190


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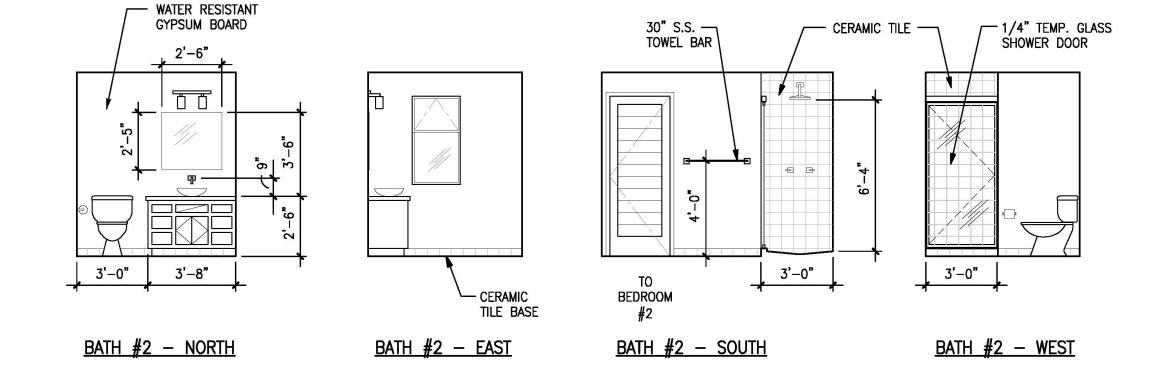
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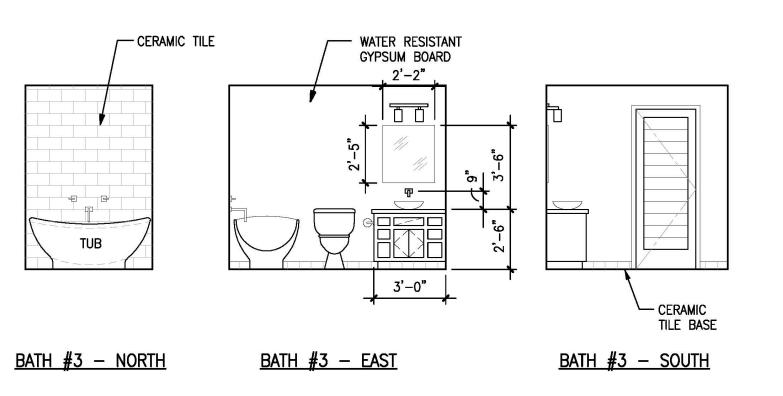
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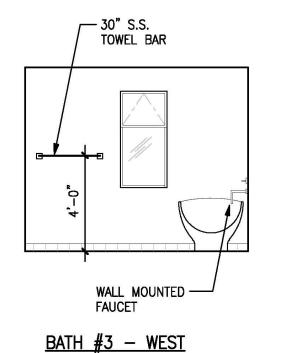
BUILDING SECTIONS







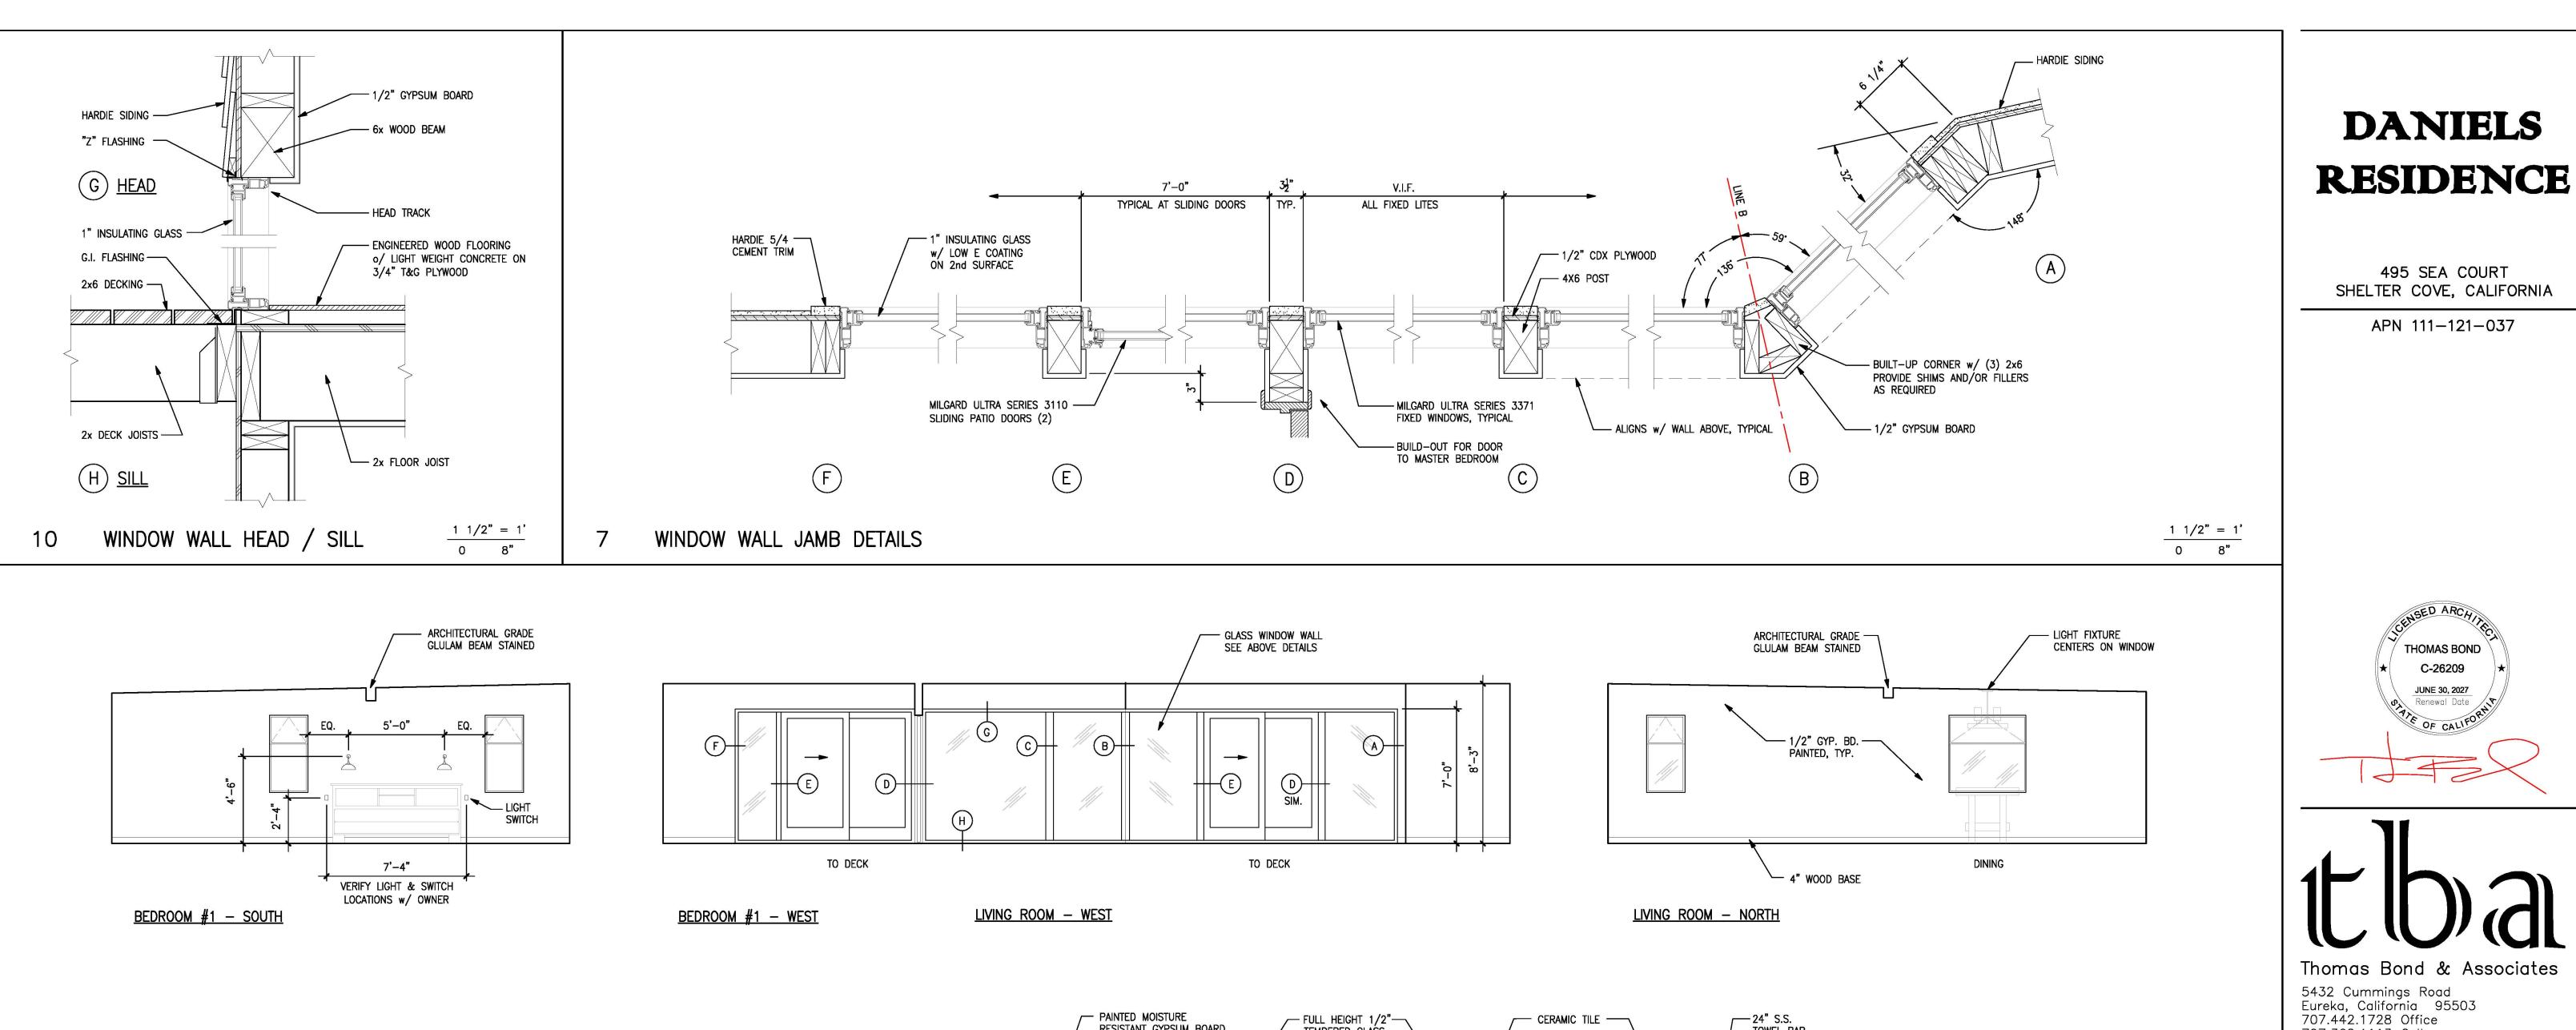

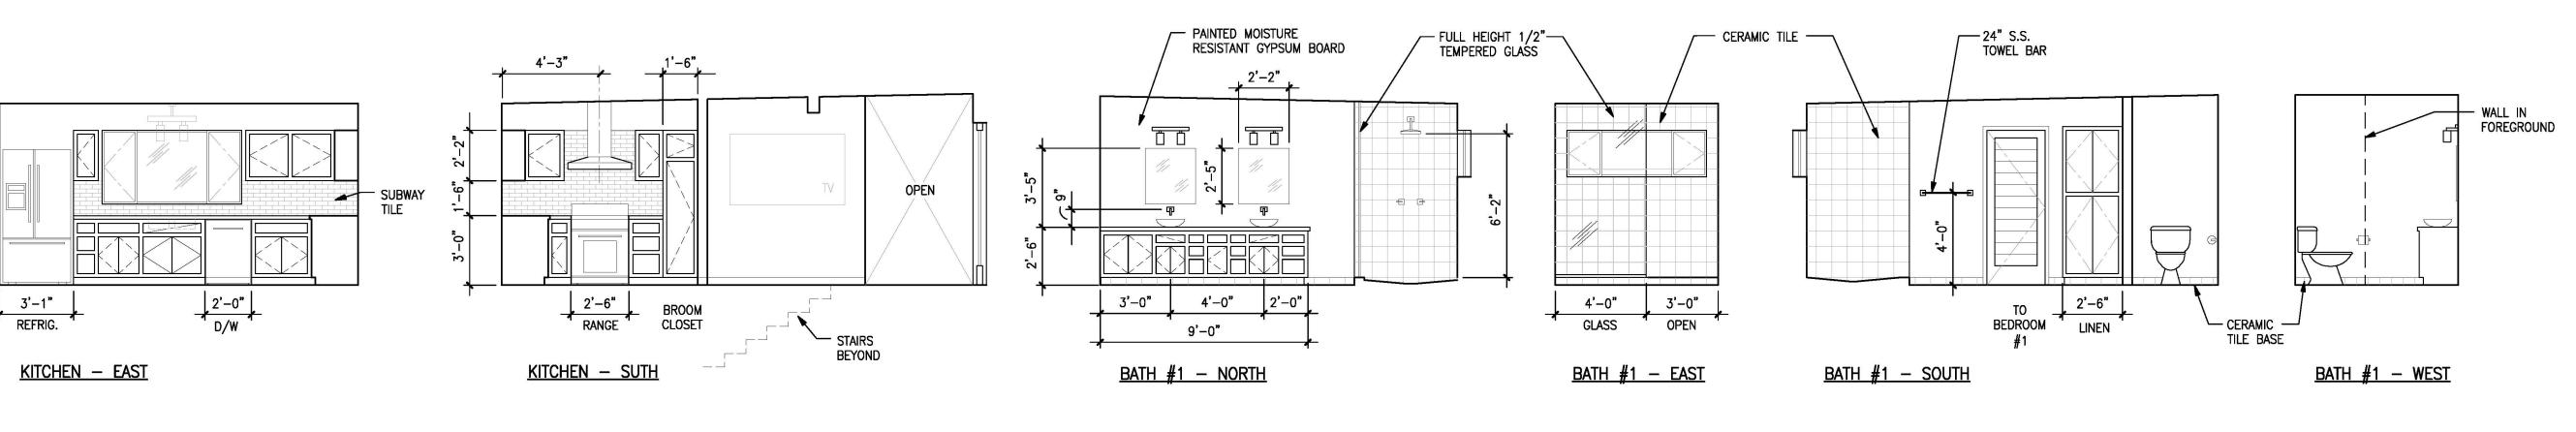

NOTE: INTERIOR FINISH MATERIALS APPLIED TO WALLS & CEILINGS SHALL BE IN ACCORDANCE w/ SECTION R302.9 CALIFORNIA RESIDENTIAL BUILDING CODE MAXIMUM FLAME SPREAD INDEX SHALL NOT BE GREATER THAN 200 MAXIMUM SMOKE-DEVELOPED INDEX SHALL NOT BE GREATER THAN 450 TESTS SHALL BE MADE IN ACCORDANCE w/ ASTM E84 or UL 723

> 1/4" = 1'0 4'-0"

ELEVATIONS

DRAWING DESCRIPTION

INTERIOR

707.362.1113 Cell

SCALE

REV. ISSUED

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DANIELS

495 SEA COURT


SHELTER COVE, CALIFORNIA

APN 111-121-037

USED ARCHITE


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INTERIOR ELEVATIONS

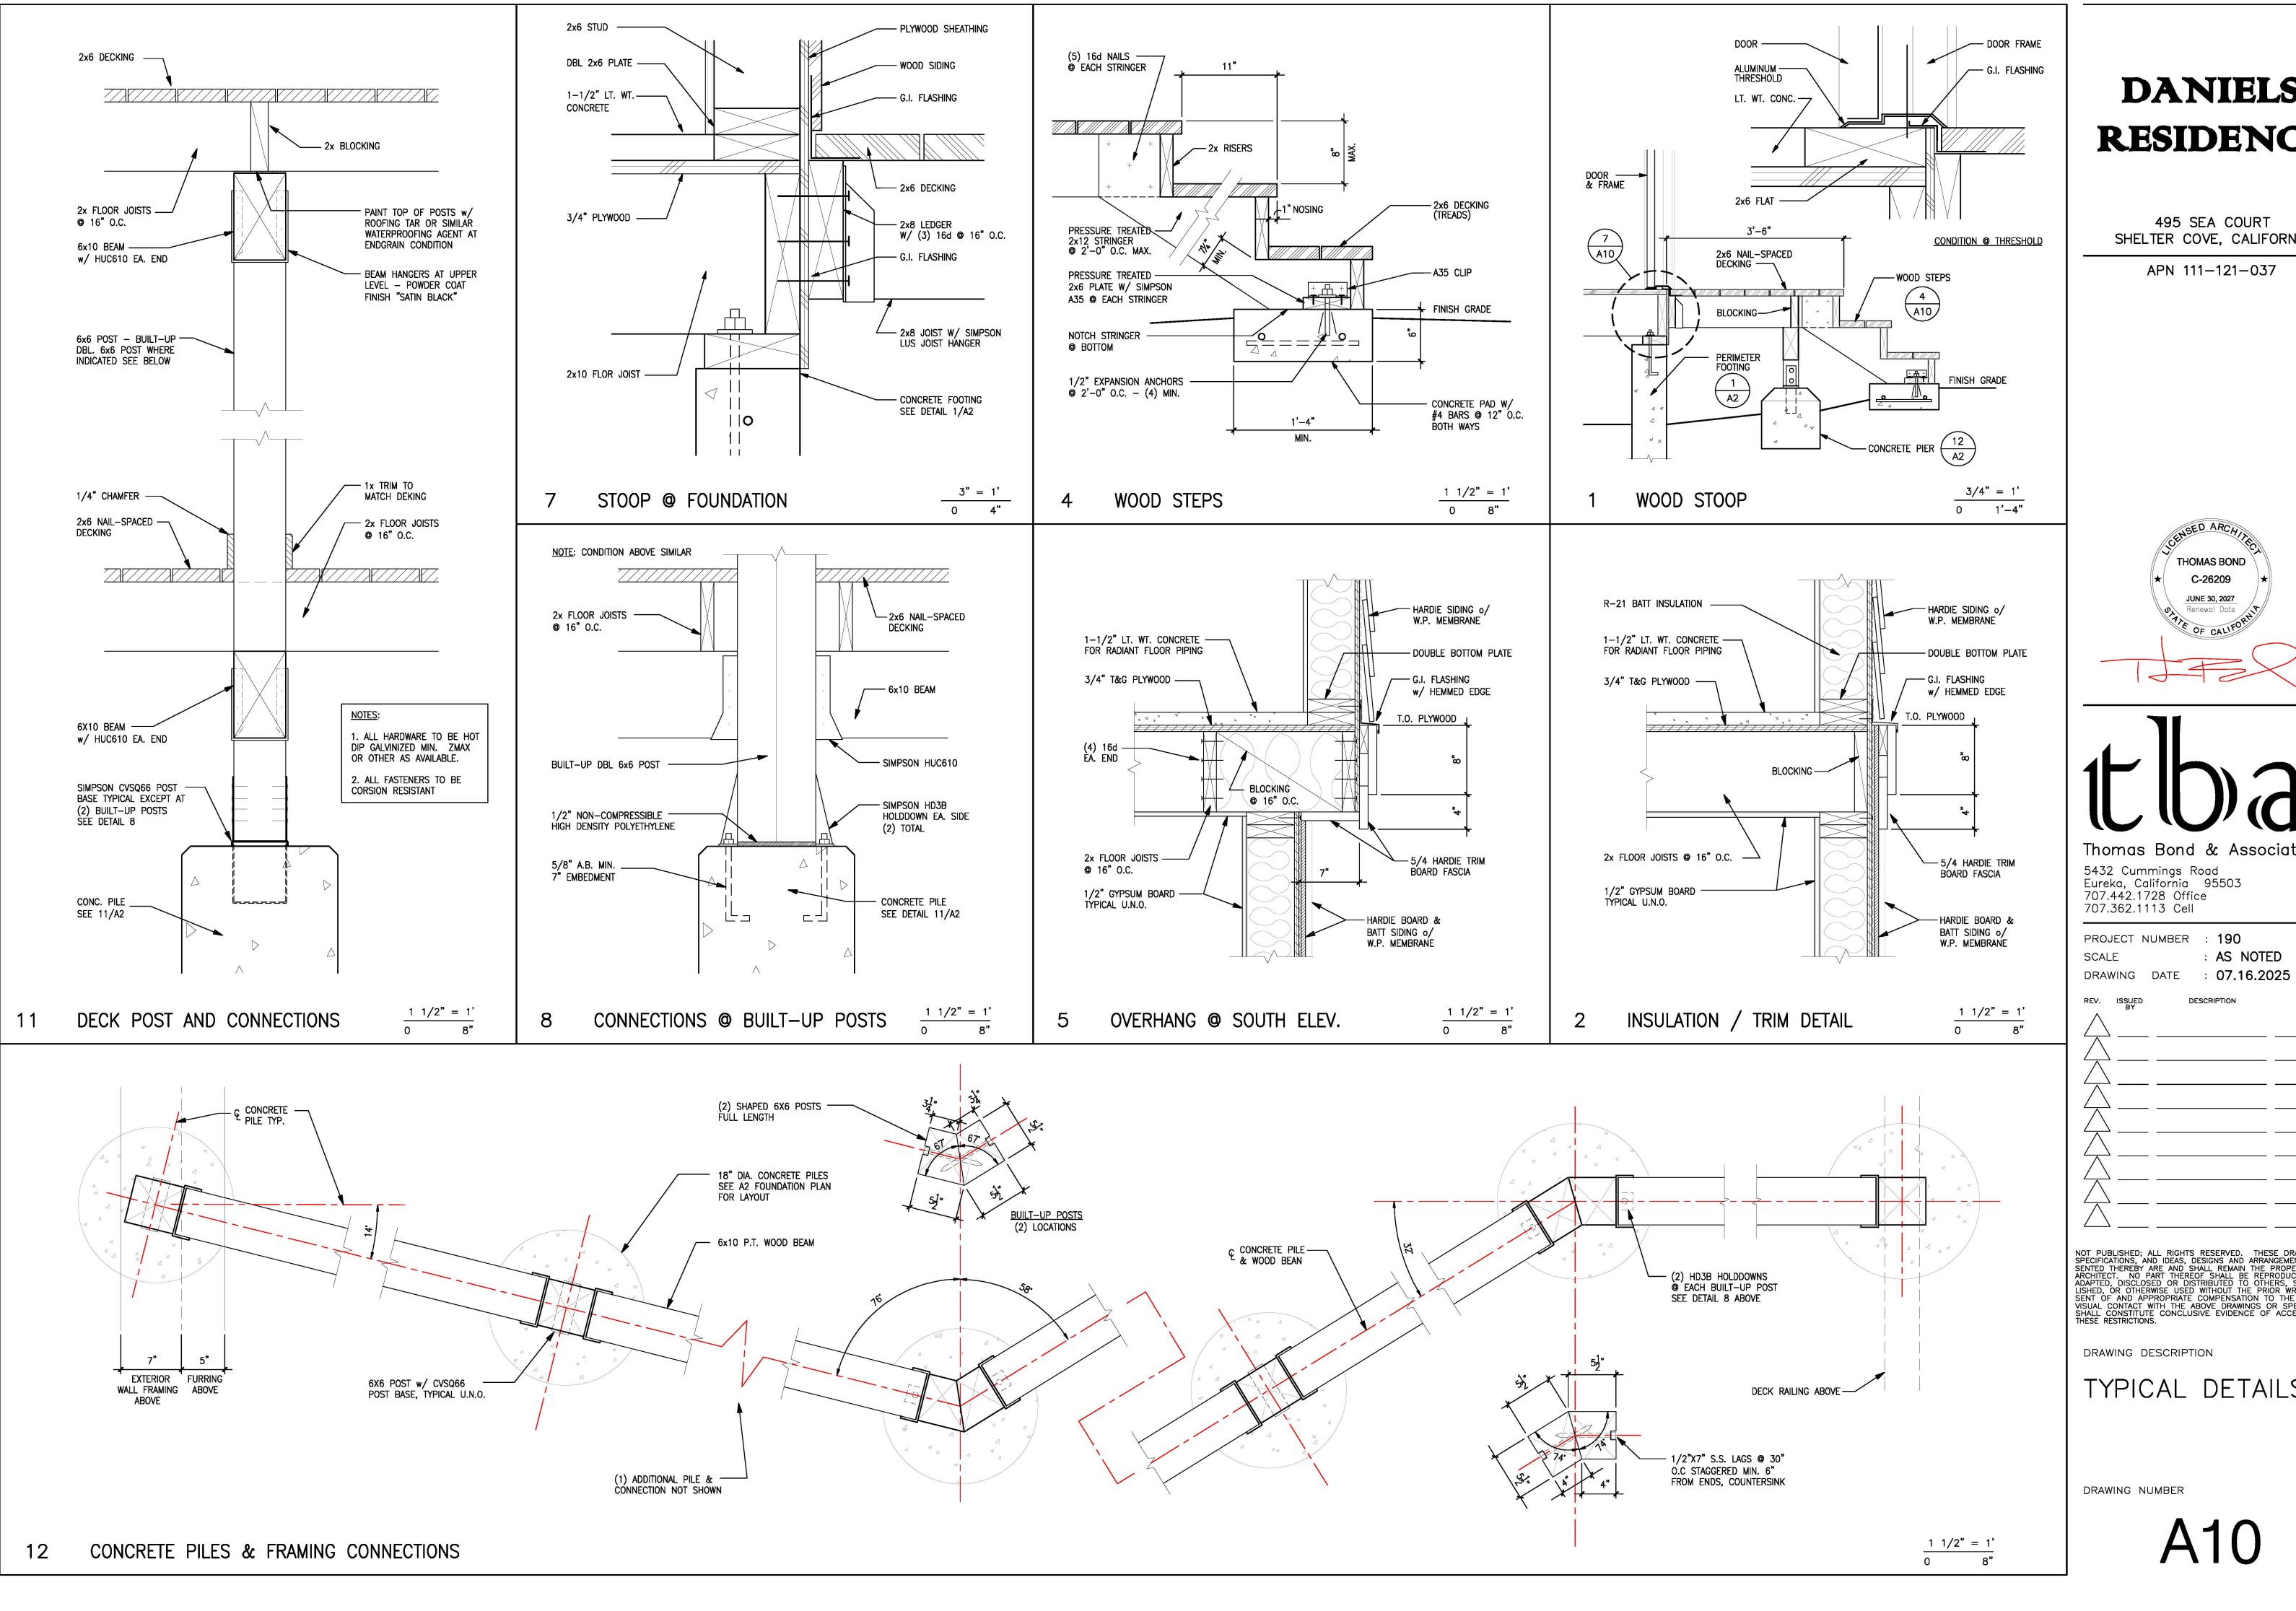

495 SEA COURT SHELTER COVE, CALIFORNIA

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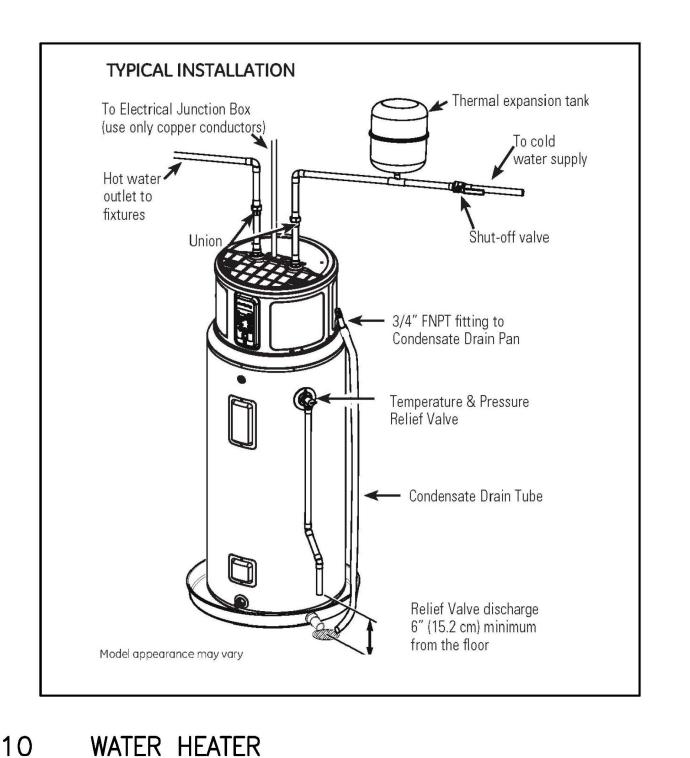


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DRAWING DESCRIPTION

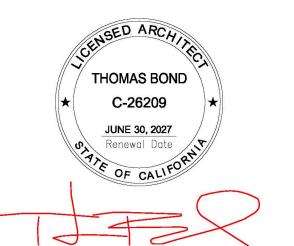TYPICAL DETAILS



PLUMBING NOTES:

- 1. PROVIDE ANTI-SCALDING DEVICE IN TUBS AND SHOWERS.
- 2. PROVIDE 12" X 12" ACCESS PANEL FOR TUB TRAP SLIP JOINT OR USE NON-SLIP (WELDED) JOINTS.
- 3. ALL PLUMBING FIXTURES SHALL COMPLY WITH THE FOLLOWING FLOW RATES:

1.6 GPM WATER CLOSETS 2.5 GPM SHOWER HEADS 2.5 GPM SINK FAUCETS

4. ELECTRIC HEAT PUMP WATER HEATER: RHEEM PROPH50 T2 RH350 D, UEF & NEEA RATED (50 GAL). MINIMUM 30 AMP CIRCUIT INSTALL PER MFGR'S INSTRUCTIONS. PROVIDE SEISMIC STRAPPING.

MECHANICAL NOTES:

- BOILER: FTV SERIES FIRE TUBE BOILER, WALL MOUNTED BY NTI NEW BRUNSWICK, CANADA.
- INDOOR AIR QUALITY FANS: BATHROOM FANS - 2 @ LOWER LEVEL AND 1 @ UPPER LEVEL MINIMUM 53 CFM, 1 SONE MAXIMUM
- KITCHEN FANS: MINIMUM 110 CFM FOR ELECTRIC RANGE MINIMUM 250 CFM FOR GAS RANGE 3 SONES MAXIMUM
- INSTALLED FANS MUST BE LISTD IN THE HVI.ORG DIRECTORY & MEET SYSTEM REQUIREMENTS.

ELECTRICAL NOTES:

- 1. SMOKE DETECTORS ARE REQUIRED TO BE HARD WIRED & INTERCONNECTED W/ BATTERY BACK-UP.
- 2. SMOKE DETECTORS ARE REQUIRED TO BE LOCATED IN EACH BEDROOM, AT HALLWAYS CENTRALLY LOCATED TO BEDROOMS, AND IN ADJACENT ROOMS TO HALLWAYS WHERE THE CEILING IS 2 FT. HIGHER THAN THE HALLWAY, AND AT LEAST ONE ON EACH LEVEL, WHEN
- GFCI PROTECTED OUTLETS ARE REQUIRED FOR ALL COUNTERTOP OUTLETS IN KITCHENS, FOR ALL OUTLETS IN A BATHROOM, GARAGE, AND EXTERIOR.
- 4. LIGHTING IN BATHROOMS, GARAGES, LAUNDRY ROOMS, AND UTILITY ROOMS SHALL EITHER BE HIGH EFFICACY OR SHALL BE CONTROLLED BY AN OCCUPANT SENSOR.
- 5. AT LEAST HALF THE INSTALLED WATTAGE OF LUMINAIRES IN KITCHENS SHALL BE HIGH EFFICACY AND THE ONES THAT ARE NOT MUST BE SWITCHED SEPARATELY.
- 6. OTHER ROOMS SHALL EITHER BE HIGH EFFICACY OR SHALL BE CONTROLLED BY AN OCCUPANT SENSOR OR DIMMER. CLOSETS THAT ARE LESS THAN 70 S.F. ARE EXEMPT FROM THIS REQUIREMENT.
- 7. RECESSED CAN LIGHTS MUST BE I.C. RATED FOR DIRECT CONTACT TO INSULATION AND A.T. RATED TO PRECLUDE INFILTRATION FROM ATTIC INTO THE CONDITIONED SPACE.
- 8. ALL OUTSIDE LUMINAIRES MOUNTED TO THE BUILDING OR TO OTHER BUILDINGS ON THE SAME LOT SHALL BE HIGH EFFICACY LUMINAIRES OR SHALL BE CONTROLLED BY A PHOTOCONTROL/MOTION SENSOR COMBINATION.
- 9. ALL 120-VOLT, SINGLE-PHASE, 15- & 20-AMPERE BRANCH CIRCUITS SUPPLYING OUTLETS OR DEVICES INSTALLED IN DWELLING UNIT KITCHENS, FAMILY ROOMS, DINING ROOMS, LIVING ROOMS, PARLORS, LIBRARIES, DENS, BEDROOMS, SUNROOMS, RECREATION ROOMS, CLOSETS, HALLWAYS, LAUNDRY AREAS, OR SIMILAR ROOMS OR AREAS SHALL BE PROTECTED BY A LISTED COMBINATION-TYPE ARC-FAULT CIRCUIT INTERRUPTER, INSTALLED TO PROVIDE PROTECTION OF THE ENTIRE BRANCH CIRCUIT.

LEGEND OF SYMBOLS:

RECESSED LED PIN-SPOT

SUSPENDED LED DOWNLIGHT

WP = WATERPROOF SUSPENDED CHANDELIER GFI = GROUND FAULT INTERUPTER CEILING FAN MD = MOTION DETECTORWALL MOUNTED SCONCE DED = DEDICATED CIRCUIT RECESSED LED WALL WASH **SWITCH** DUPLEX OUTLET SURFACE MOUNTED LED UTILITY LIGHT FLOOR OUTLET FOURPLEX OUTLET **FLOODLIGHTS** 220v OUTLET COOR. W/ OWNER BATHROOM EXHAUST FAN (5) AIR CHANGES/HR J-B0X SMOKE DETECTOR CABLE HARDWIRED w/ BARTTERY BACKUP & ALARM INTERCONNECTED SURFACE MOUNTED LED DOWNLIGHT SMOKE / CARBON MONOXIDE COMBINATION ALARM RECESSED LED DOWNLIGHT

LED LANDSCAPE LIGHT

(SEE ALSO SITE PLAN)

GAS OUTLET

DANIELS RESIDENCE

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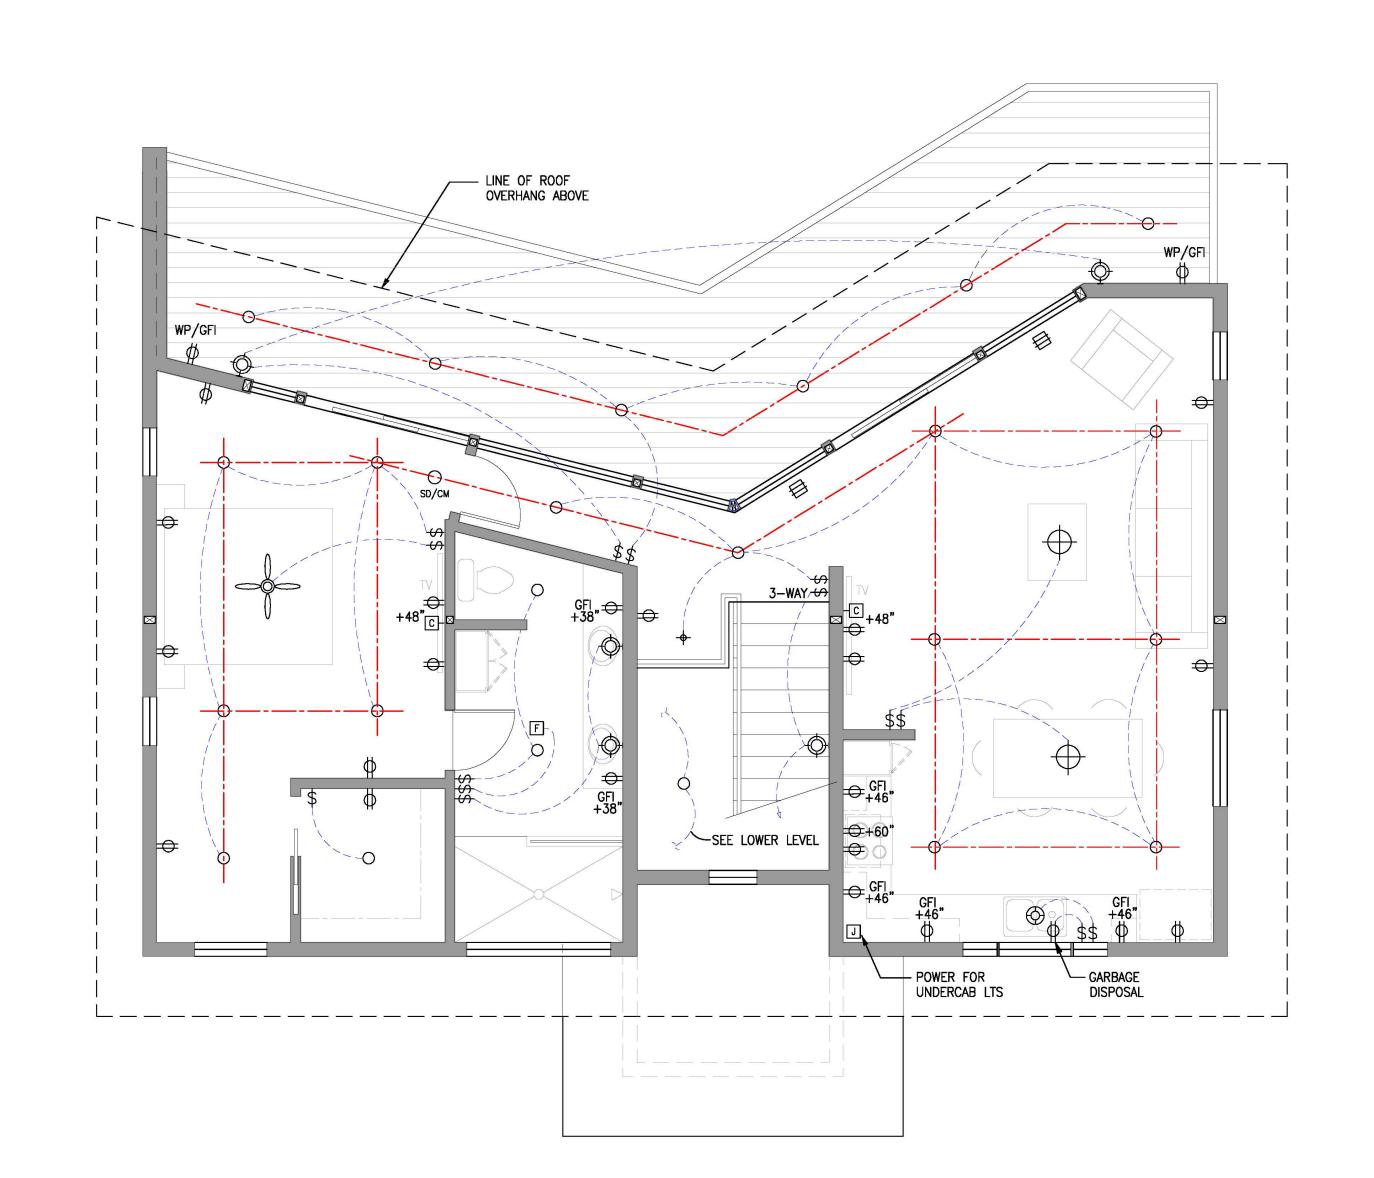
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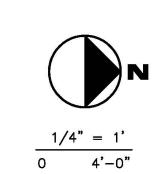
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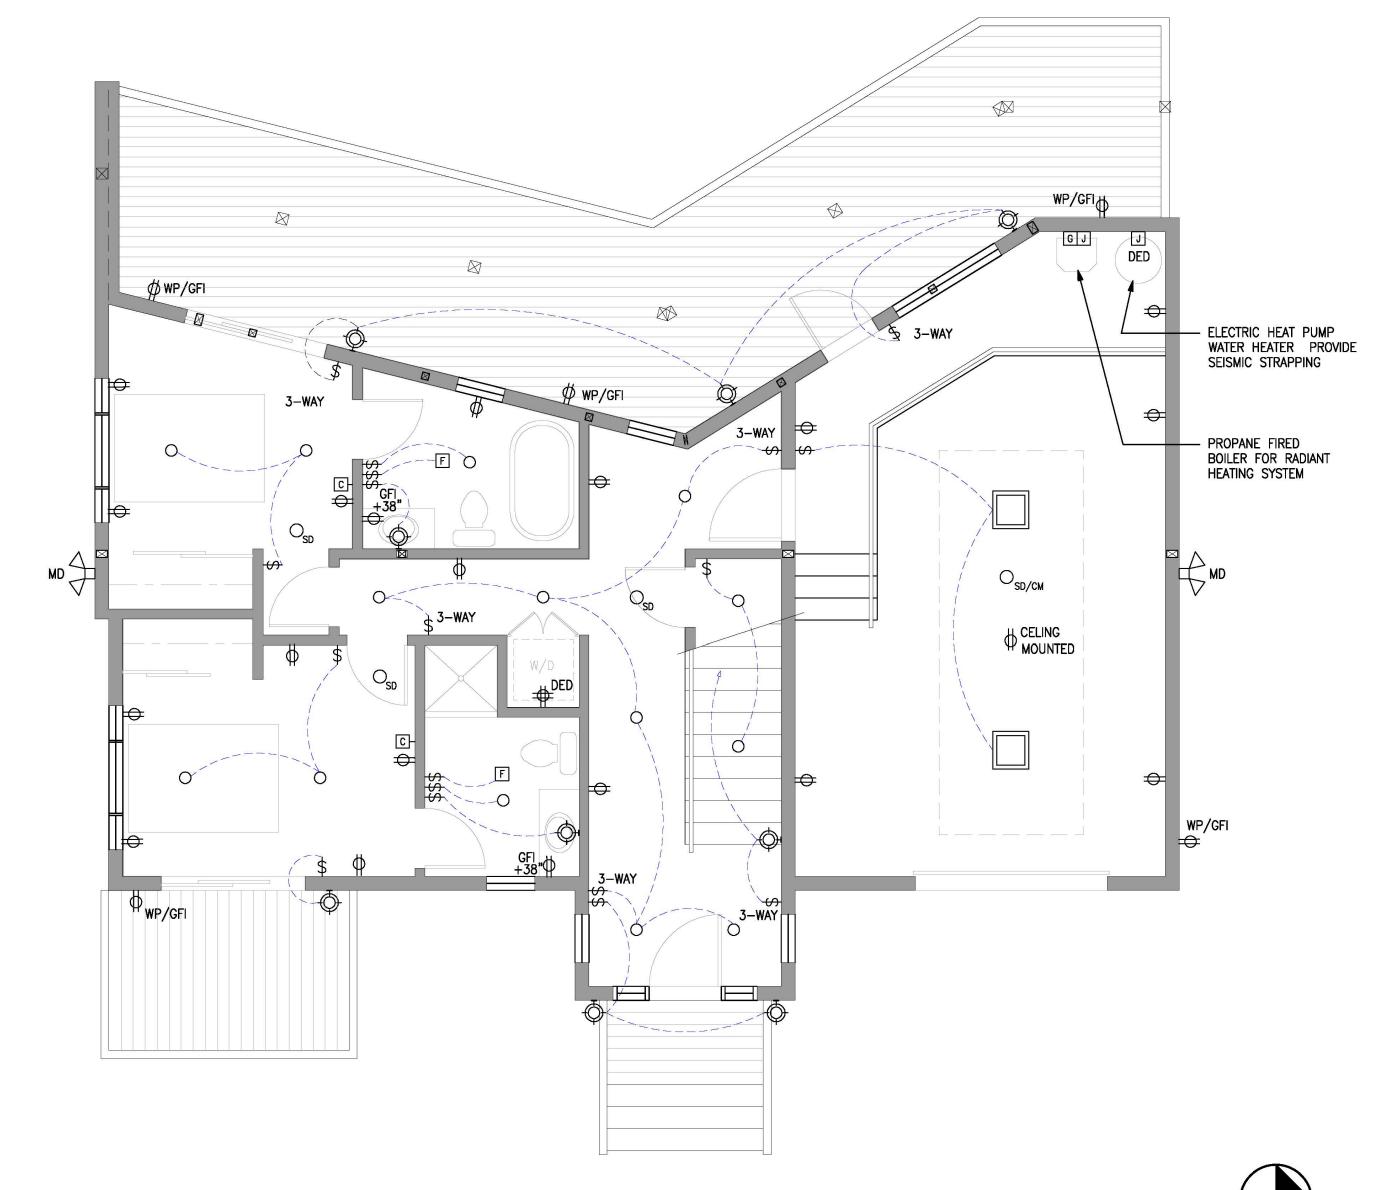
LOWER & UPPER MEP PLANS

DRAWING NUMBER

MEP NOTES & LEGEND







LOWER LEVEL MEP PLAN