

| - 1 | ORIGINAL DRAWING |
|-----|--------------------|
| | |
| 1 | IF NOT ONE INCH OF |
| n | SCALES ACCORDINGL |

| | THE THIRD SHAFT OF THE SAFE | DESIGN SECTION |
|---|-----------------------------|-----------------------|
| N | ROAD NO: F30010 | ENGINEERING |
| | MILE POST: 2.11 | DESIGNED BY: C. HAYE |
| | PROJECT NO.: ER-32L0(255) | DRAWN BY: C. HAYE |
| 1 | CONTRACT NO.: 217400 | REVIEWED BY: J. SVEHL |
| Y | PLOT DATE: 2/2/22 | APPROVED BY: J. SVEH |

STORM DAMAGE REPAIR MATTOLE ROAD PM 2.11

COVER SHEET, SHEET INDEX AND MAPS

MENDOCINO CO.

LOCATION MAP SCALE: 1"=10± MILE

COUNTY OF HUMBOLDT DEPARTMENT OF PUBLIC WORKS

13

FUNDING SOURCE

THIS PROJECT IS FUNDED BY THE US DEPARTMENT OF TRANSPORTATION, FEDERAL HIGHWAY ADMINISTRATION EMERGENCY RELIEF PROGRAM



ABBREVIATIONS (TO SUPPLEMENT CALTRANS STANDARD PLANS A3A, A3B & A3C)

APN ASSESSORS PARCEL NUMBER

CENTERLINE

CALTRANS

EXISTING ELEVATION

K-VALUE

POINT OF VERTICAL CURVATURE

RIGHT SLOPE

COUNTY OF HUMBOLDT DEPARTMENT OF PUBLIC WORKS

PROJECT PLANS FOR CONSTRUCTION OF STORM DAMAGE REPAIRS MATTOLE ROAD (BULL CREEK) (F3D010) AT P.M. 2.11 PROJECT NO. ER-32L0(255) CONTRACT NO. 217400

> TO BE SUPPLEMENTED BY STATE OF CALIFORNIA DEPARTMENT OF TRANSPORTATION STANDARD PLANS, STANDARD SPECIFICATIONS, AND LATEST REVISED STANDARD PLANS AND SPECIFICAITONS.





JEREMY SHANE SVEHLA

2-22-2022 DATE





RCE C72169 CIVIL ENGINEER

APPROVED

SHEET LIST TABLE


PROJEC1

LOCATION

| SILLI | Office Title |
|-------|-------------------------------------|
| 1 | COVER SHEET, SHEET INDEX AND MAPS |
| 2 | SURVEY CONTROL PLAN |
| 3 | TRAFFIC CONTROL PLAN AND QUANTITIES |
| 4 | TYPICAL ROADWAY SECTIONS |
| 5 | ROADWAY PLAN |
| 6 | ROADWAY PROFILE AND SUPERELEVATION |
| 7 | HORIZONTAL DRAIN LAYOUT |
| 8 | DRAINAGE PROFILES |
| 9 | CONSTRUCTION DETAILS |
| 10 | ROADWAY CROSS SECTIONS |
| 11 | ROADWAY CROSS SECTIONS |
| 12 | EROSION CONTROL PLAN |
| 9.2 | |

NOTES

- 1. THE CONTRACTOR SHALL HAVE A CLASS "A" LICENSE FOR THIS
- 2. STANDARD PLAN LIST APPLICABLE TO THIS CONTRACT INCLUDED
- 3. GEOTECHNICAL REPORT: CRAWFORD AND ASSOCIATES, JAN 28,

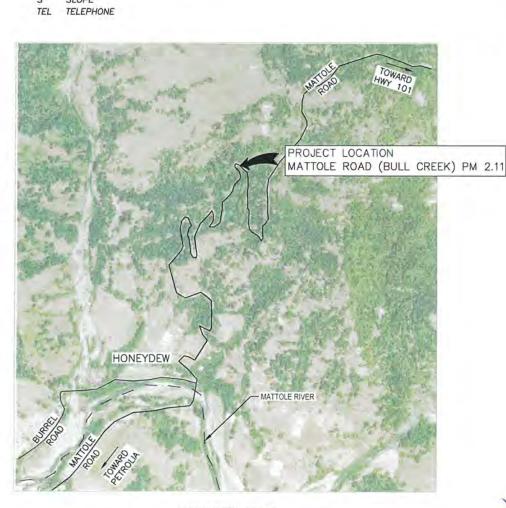

SCALE: 1"=1,000'±

COUNTY OF HUMBOLDT DEPARTMENT OF PUBLIC WORKS DESIGN SECTION ENGINEERING ILE POST: 2.11 SIGNED BY: C. HAYES STORM DAMAGE REPAIR MATTOLE ROAD PM 2.11 SURVEY CONTROL NOTES OJECT NO.: ER-32L0(255 IF NOT ONE INCH ON THIS SHEET, ADJUST SCALES ACCORDINGLY 718 Third Street ONTRACT NO.: 217400 EVIEWED BY: J. SVEHLA ureka California 95501 USA SURVEY CONTROL PLAN 13 THE MAJORITY OF THIS MAP IS BASED ON A FIELD SURVEY PERFORMED FROM 5/5/2015 TO T 1 707 443 8326 F 1 707 444 8330 W www.ghd.com OT DATE: 2/2/22 PPROVED BY: J. SVEHL 5/8/2019. THE AREA LABELED "LIMITS OF 2019 TOPO" WAS RESURVEYED ON 4/17/2019. THE RESURVEY FOUND THAT AREAS NORTHWEST OF THE MAJOR SCARP AT THE APPROXIMATE CENTER OF THE MAP HAD MOVED APPROXIMATELY 5 FEET HORIZONTAL AND SUBSIDED 2 FEET VERTICAL. THIS MOVEMENT CAN BE SEEN IN THE GRAPHIC POSITIONS OF THE GEOLOGIC MONITORING WELLS AND CONTROL POINT #50 SHOWN IN 2015 AND 2019 HEREON; ARROWS INDICATE THE DIRECTION OF HORIZONTAL MOVEMENT. LEGEND HORIZONTAL DATUM IS ASSUMED, WITH BEARINGS BASED ON A TRUE COMPASS BEARING BETWEEN CONTROL POINTS #50 AND #51 OF S 17° E. CP#50 HAD AN ASSUMED COORDINATE TEMPORARY CONTROL POINT OF N 50000.00; E 80000.00 ON THE ORIGINAL 2015 SURVEY; BECAUSE OF THE SITE MATTOLE ROAD R/W MOVEMENT THIS COORDINATE HAS CHANGED. CONTROL POINTS #51 AND #54 WERE FOUND TO BE IN THEIR ORIGINAL POSITION AND WERE HELD FOR THE RESURVEY — — — ALIGNMENT LINE APN 107-061-002 ROBERT SCHULTZ VERTICAL DATUM IS ASSUMED. AN ELEVATION OF 1000.00' WAS HELD ON THE FOUND — — — PROJECT TEMPORARY CONSTRUCTION EASEMENT (TCE) 2014-R09780 TEMPORARY BENCHMARK (TBM) BY TABER ASSOCIATES AS SHOWN HEREON. SAID PROJECT PERMANENT R/W BENCHMARK IS A MAGNAIL AND SHINER. THE 2019 RESURVEY MADE A TIE TO A NAVD88 BENCHMARK, NGS PID "LV1209", THAT LIES SOUTH OF THE PROJECT SITE. PER SAID TIE, ASSUMED ELEVATIONS ARE 214.36 FEET BELOW NAVD88 ELEVATIONS. TREES SHOWN HEREON WERE THOSE FOUND ONSITE WITH A DIAMETER AT BREAST HEIGHT OF 12" OR GREATER. TREES WERE LOCATED TO THE CENTER OF THE BASE OF THE TRUNK; SOME OF THE OAKS ON SITE LEAN SIGNIFICANTLY FROM THE BASE POSITION SHOWN HEREON. TREES WERE NOT LOCATED ALONG THE TOP OF BANK NORTH OF THE ROAD AT THE ON THE NORTHERLY PORTION OF THE PROJECT AS NOTED HEREON. 5. MULTIPLE SCARPS AND CRACKS ARE SHOWN HEREON; THESE ARE WHAT WAS VISIBLE AT THE TIME OF THE SITE VISIT. 6 RIGHT OF WAY WAS NOT DETERMINED AS PART OF THIS PROJECT. THE HUMBOLDT COUNTY SURVEYOR HAS PROVIDED A DETERMINATION TO THE ENGINEERING DEPARTMENT AS TO A PRESCRIPTIVE EASEMENT 40 FEET IN WIDTH CENTERED ON THE EXISTING ROADWAY. PER THE HUMBOLDT COUNTY GIS AND FIRST AMERICAN DATATREE GIS, IT APPEARS THE PROJECT SITE IS BISECTED BY A NORTH-SOUTH PROPERTY LINE, THE TOWNSHIP LINE APN 107-054-036 BETWEEN TOWNSHIP 2 SOUTH RANGE 1 WEST AND TOWNSHIP 2 SOUTH, RANGE 1 EAST KOUCHALAKOS BETWEEN 2 PRIVATE OWNERSHIPS. NO BOUNDARY SURVEYS WERE PERFORMED AS PART 2019-R12146 OF THESE SURVEYS. NO EVIDENCE OF UTILITIES WAS FOUND ONSITE OTHER THAN THE FAILED STORM DRAIN APN 107-061-002 FEATURE NOTED HEREON. ROBERT SCHULTZ 8. THE CREEK THAT FLOWS INTO THE ROADSIDE DITCH AT THE EASTERLY END OF THE PROJECT SITE FLOWS THROUGH THE 24" CPP CULVERT THEN DISAPPEARS INTO THE GROUND IN THE VICINTY OF CP#52. THE NORTHERLY CREEK THAT JOINS THIS DRAINAGE CHANNEL HAD GOOD FLOW AT THE TIME OF THE 2015 AND 2019 SURVEY (E) ESTIMATED OPTIONAL SITE ACCESS GENERAL NOTES **FAILURE PLANE** AT (E) PRIVATE DRIVEWAY CONTRACTOR MUST COMPLY WITH BUSINESS AND PROFESSIONS CODE SECTION 8771 (b) REGARDING REFERENCING, PRESERVING AND RECONSTRUCTING MONUMENTS, WHETHER OR NOT MONUMENTS ARE SHOWN IN THESE PLANS. IF MONUMENT IS DAMAGED BY CONTRACTORS OPERATIONS, CONTRACTOR SHALL REPLACE MONUMENT AT CONTRACTORS EXPENSE - MATTOLE RD. UNDERGROUND UTILITY NOTE 1. UNDERGROUND UTILITIES ARE SHOWN BASED ON A COMBINATION OF VISIBLE PHYSICAL EVIDENCE AND RECORDS MADE AVAILABLE TO THE SURVEYOR. WESTERN RIGHT THE SURVEYOR MAKES NO GUARANTEES THAT THE UNDERGROUND UTILITIES SHOWN COMPRISE ALL SUCH UTILITIES IN THE AREA, EITHER IN SERVICE OR ABANDONED. THE OF WAY LIMITS SURVEYOR FURTHER DOES NOT WARRANT THAT THE UNDERGROUND UTILITIES ARE IN THE EXACT LOCATIONS INDICATED. THE SURVEYOR HAS NOT PHYSICALLY LOCATED THE 3. CALL UNDERGROUND SERVICE ALERT (USA) 1-800-642-2444 A MINIMUM OF 2 WORKING DAYS MATTOLE/RD. CL MATTOLE RD. PM 2.11 CONSTRUCTION CENTERLINE GEOMETRY Type Length Radius Station SURVEY CONTROL POINT TABLE CURVE 111.07 103.72 "R" 2+00.00 "R" 3+11.07 Easting Northing LINE 61.07 N56° 42' 36.92"W "R" 3+11.07 "R" 3+72.15 79928.8328 50001.7086 973.247 CURVE 45.83 195.87 "R" 3+72.15 "R" 4+17 97 STA "R" 2+00 STA "R" 8+80 79918.4427 50032.2062 974.234 CP_SPK CURVE 115.32 "R" 4+17.97 "R" 5+33.29 N 49834.84 N: 49829.86 79956.3318 50100.8788 976.089 E: 80220.39 40.95 "R" 5+74.24 79900 6692 50203.2750 918.676 CP SPK CURVE 918.29 "R" 5+74.24 "R" 6+55.67 81.43 "R" 7+79.77 CURVE 79.82 150.00 "R" 6+99.95 SURVEY CONTROL CP SPK CLRD CULV C9 CURVE 52.80 "R" 7+79.77 120.00 "R" 8+32.58 79663.5840 50176.4572 819.006 LINE 47.53 S7° 51' 12,75"E "R" 8+32 58 79831,5316 50009.6367 939.400 CP SPK

OPTIONAL SITE ACCESS NOTES

- OPTIONAL SITE ACCESS ALONG SOUTHERN PRIVATE GRAVEL ROAD MAY BE USED FOR HORIZONTAL DRILLING OPERATIONS ONLY.
- CONTRACTOR SHALL NOT BLOCK ACCESS ALONG SOUTHERN PRIVATE GRAVEL ACCESS ROAD TO EXISTING RESIDENCES AT ANY TIME. VEHICULAR TRAVEL ALONG EXISTING ACCESS ROAD MUST BE MAINTAINED AT ALL TIMES.
- EXISTING SOUTHERN PRIVATE GRAVEL ACCESS ROAD SHALL BE RESTORED BACK TO PRE-PROJECT CONDITIONS AFTER PROJECT COMPLETION.
- GATE ALONG SOUTHERN PRIVATE GRAVEL ACCESS ROAD SHALL REMAIN CLOSED AT MATTOLE ROAD AT ALL TIMES.

CONSTRUCTION SIGN NOTES:


- EXACT SIGN LOCATIONS AND POSITIONS TO BE APPROVED BY THE
- ALL WARNING SIGNS SHALL HAVE A BLACK LEGEND AND BORDER ON ORANGE BACKGROUND.
- ALTERNATIVE POST CONFIGURATION TO BE APPROVED BY ENGINEER.
- REFER TO TABLE 6H-3 RECOMMENDED ADVANCE WARNING SIGN SPACING FOR RURAL ROAD TYPE.
- REFER TO FIGURE 6-H11 FOR LANE CLOSURE ON A TWO-LANE ROAD WITH LOW TRAFFIC VOLUMES (TA-11).
- REFER TO FIGURE 6H-12 FOR LANE CLOSURE ON A TWO-LANE ROAD USING TRAFFIC CONTROL SIGNALS (TA-12)
- ALL TRAFFIC CONTROL SHALL BE IN ACCORDANCE WITH THE LATEST EDITION OF THE CALIFORNIA MANUAL ON UNIFORM TRAFFIC CONTROL DEVICES (CA-MUTCD) AND CALTRANS 2018 STANDARD PLANS.
- MAINTAIN ALL SIGNS THROUGHOUT DURATION OF CONSTRUCTION.
- MAINTAIN ONE TRAVEL LANE AT ALL TIMES.
- PROVIDE FLAGGERS AS REQUIRED TO ACCOMMODATE CONSTRUCTION.

QUANTITIES

| tem No. | Item No. | | Description | Quantity | Unit |
|----------|------------------|----------|---|-----------|----------|
| 1 | 120090 | | Construction Area Signs | 1 | LS |
| 2 | 120100 | | Traffic Control System | 1 | L\$ |
| 3 | 120202 | | Portable Signal System | 1 | LS |
| 4 | 130100 | | Job Site Management | 1 | L\$ |
| 5 | 130200 | • | Prepare Water Pollution Prevention Plan (SWPPP) for 1.36-acre project | 1 | LS |
| 6 | 129000 | _ | Rain Event Action Plan | 16 | EA |
| 7 | 130320 | _ | Stormwater Sampling and Analysis Day | 8 | EA |
| 8 | 130330 | | Stormwater Annual Report | 1 | EA |
| 9 | 130610 | | Temporary Check Dam | 60 | LF |
| 10 | 130640 | | Temporary Fiber Roll | 100 | LF |
| 11 | 210350 | | Fiber Rolls | 1285 | LF |
| 12 | 130620 | | Temporary Drainage Inlet Protection | 3 | EA |
| 13 | 130680 | | Temporary Silt Fence | 350 | LF |
| 14 | 210430 | | Dry Seed | 22000 | SQFT |
| 15 | 210280 | | Rolled Erosion Control Product (Blanket) | 22000 | SQFT |
| 16 | 170103 | | Clearing and Grubbing | 1 | LS |
| 17 | 190101 | F | Roadway Excavation | 344 | CY |
| 18 | 198050 | F | Roadway Embankment | 134 | CY |
| 19 | 390132 | | Hot Mix Asphalt (Type A) | 409 | TON |
| 20 | 190101 | _ | Place Hot Mix Asphalt Dike (Type D, Case C-2) | 117 | LF |
| 21 | 394076 | | Place Hot Mix Asphalt Dike (Type E, Case R) | 240 | LF |
| 22 | 260203 | F | Class 2 Aggregate Base | 165 | CY |
| 23 | 027124 | _ | Biaxial Geogrid | 1120 | SQYD |
| 24 | 393006 | | Geosynthetic Pavement Interlayer (Paving Grid) | 299 | SQYD |
| 25 | 723095 | | Rock Slope Protection (20 lb, Class I, Method B) | 29 | CY |
| 26 | 723080 | _ | Rock Slope Protection (60 lb. Class II, Method B) | 20 | CY |
| 27 | 723060 | • | Rock Slope Protection (300 lb, Class IV, Method B) | 49 | CY |
| 28 | 680902 | | 6" Perforated Plastic Pipe Underdrain | 218 | LF |
| 29 | 680903 | | 6" Non-Perforated Plastic Pipe | 30 | LF |
| 30 | 641113 | _ | 24" Plastic Pipe (Heat-Fused HDPE) | 266 | LF |
| 31 | 691900 | | 12" Plastic Flume Downdrain | 90 | LF |
| 32 | 692101 | | Tapered Inlet | 2 | EΑ |
| 33 | 692361 | | Flume Anchor Assembly | 2 | EA |
| 34 | 033582 | | 1 1/2" Plastic Pipe (Schedule 80) | 250 | LF |
| 35 | 681501 | <u> </u> | Furnish and Install Drain Pipe (Horizontal Drain) | 8870 | LF. |
| 36 | 681502 | <u> </u> | Drill Hole (Horizontal Drain) | 8870 | LF |
| 37 | 030643 | | 6" Collector System (Horizontal Drain) | 400 | LF |
| 38 | 030644 840505 | - | Horizontal Drain Connector Unit | 25 580 | EA LF |
| 39 40 | 999990 | | 4" Thermoplastic Traffic Stripe Mobilization | 1 580 | LS |

STATIONARY MOUNTED CONSTRUCTION AREA SIGNS

| STATIONARY MOUNTED CONSTRUCTION AREA SIGNS | | | |
|--|--|---|---|
| PANEL SIZE | SIGN MESSAGE | NUMBER & POST SIZE | NO. OF SIGNS |
| 36"x36" | ROAD WORK AHEAD | (1) 4"x4" | 2 |
| 36"x18" | END ROAD WORK | (1) 4"x4" | 2 |
| 36"x36" | ONE LANE ROAD AHEAD | (1) 4"x4" | 2 |
| 24"x36" | STOP HERE ON RED | (1) 4"x4" | 2 |
| 36"x36" | SIGNAL WARNING | (1) 4"x4" | 2 |
| 36"x36" | HORIZONTAL ALIGNMENT | (1) 4"x4" | 2 |
| | PANEL SIZE 36"x36" 36"x18" 36"x36" 24"x36" | PANEL SIZE SIGN MESSAGE 36"x36" ROAD WORK AHEAD 36"x18" END ROAD WORK 36"x36" ONE LANE ROAD AHEAD 24"x36" STOP HERE ON RED 36"x36" SIGNAL WARNING | PANEL SIZE SIGN MESSAGE NUMBER & POST SIZE 36"x36" ROAD WORK AHEAD (1) 4"x4" 36"x18" END ROAD WORK (1) 4"x4" 36"x36" ONE LANE ROAD AHEAD (1) 4"x4" 24"x36" STOP HERE ON RED (1) 4"x4" 36"x36" SIGNAL WARNING (1) 4"x4" |

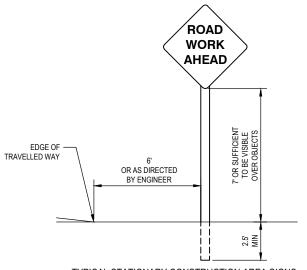


TYPICAL STATIONARY CONSTRUCTION AREA SIGNS

COORDINATE GATE LOCK

COMBINATION WITH THE COUNTY OF HUMBOLDT DEPARTMENT OF PUBLIC

W20-1


ROAD WORK AHEAD WORKS

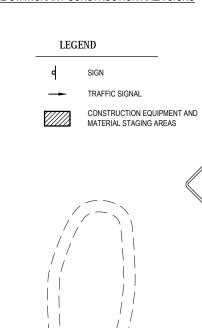



DESIGN SECTION ENGINEERING OAD NO: F3D010 SIGNED BY: C. HAYES MILE POST: 2.11 ROJECT NO.: ER-32L0(255) AWN BY: C. HAYES ONTRACT NO.: 217400 EVIEWED BY: J. SVEHLA LOT DATE: 2/2/22 APPROVED BY: J. SVEHL

| SHEET | COUNTY OF HUMBOLDT DEPARTMENT OF PUBLIC WORKS |
|-------|--|
| ر ا | STORM DAMAGE REPAIR MATTOLE ROAD PM 2.11 |
| 13 | TRAFFIC CONTROL PLAN AND QUANTITIES |

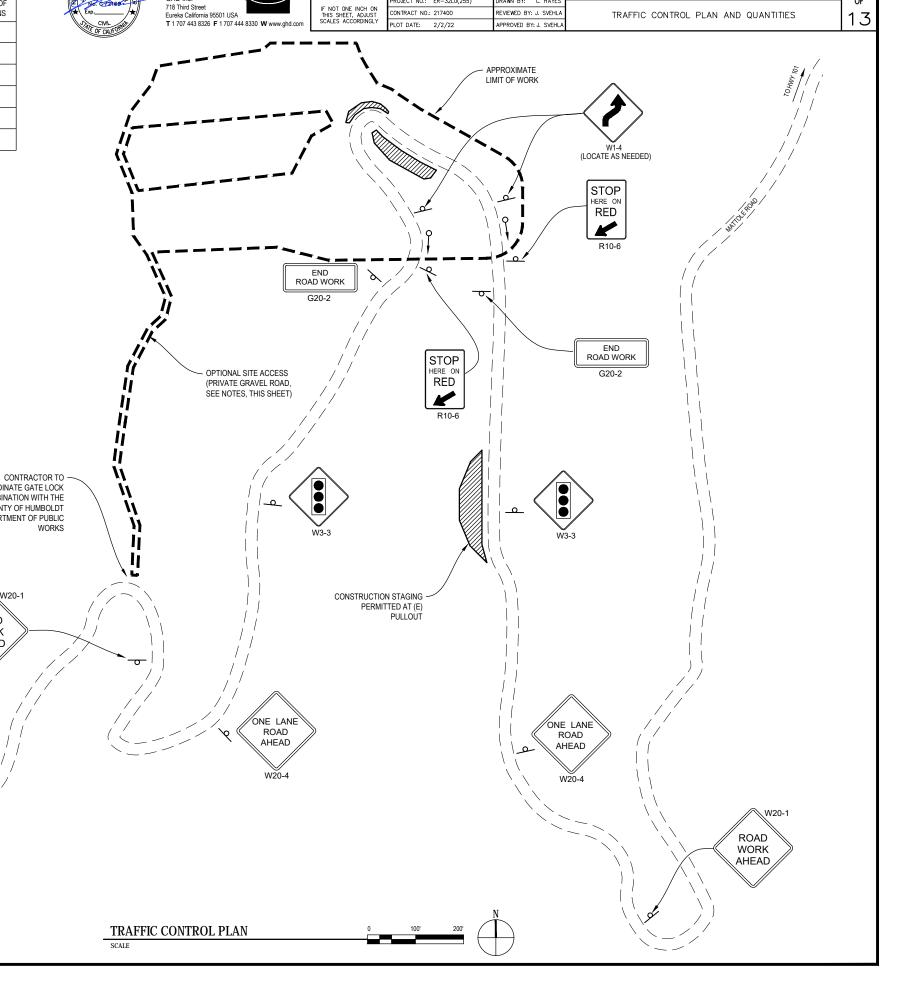



GHD Inc.
718 Third Street
Eureka California 95501 USA
T 1 707 443 8326 F 1 707 444 8330 W www.ghd.com

BAR IS ONE INCH ON ORIGINAL DRAWING

FOOLET NO.: F30010

MILE POST: 2.11

PROJECT NO.: ER-32L0(255)

DRAWIN BY: C. HAYES ONTRACT NO.: 217400

REVIEWED BY: J. SVEHLA PLOT DATE: 2/2/22

APPROVED BY: J. SVEHLA PLOT DATE: 2/2/22

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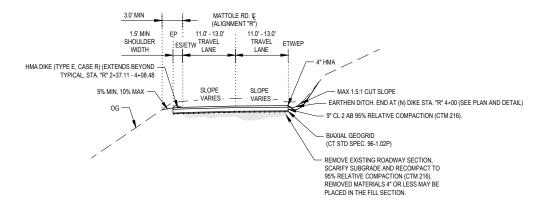
TYPICAL ROADWAY SECTIONS

STORM DAMAGE REPAIR MATTOLE ROAD PM 2.11

COUNTY OF HUMBOLDT DEPARTMENT OF PUBLIC WORKS


4 of 13

SHEET




TYPICAL ROADWAY SECTION STA "R" 3+00 - 4+40

NOT TO SCALE

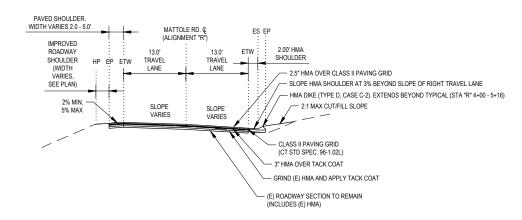


TYPICAL ROADWAY SECTION STA "R" 4+40 - 5+20

NOT TO SCAI

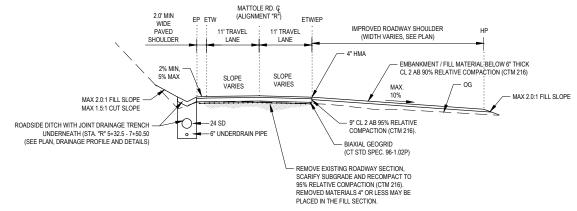


TYPICAL ROADWAY SECTION STA "R" 5+20 - 7+80

NOT TO SCALE

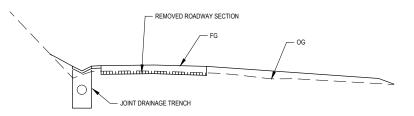


LIMITS OF PAYMENT - CUT


NOT TO SCALE

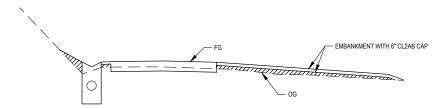



LIMITS OF PAYMENT - FILL


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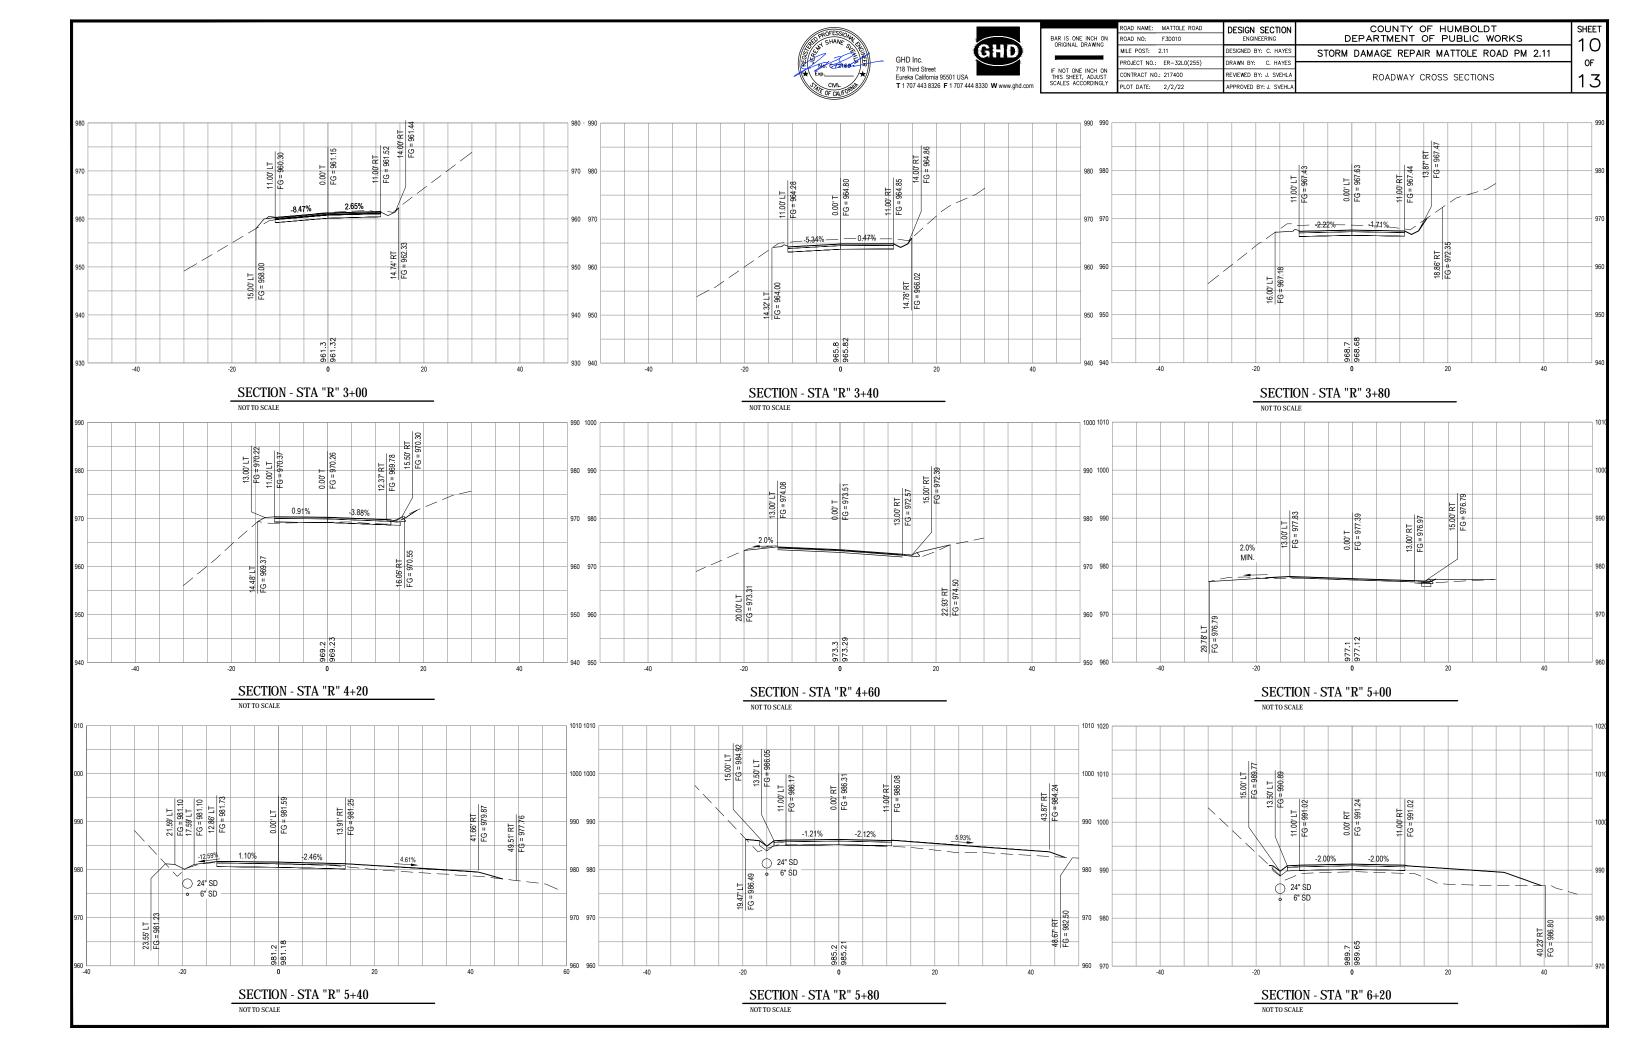


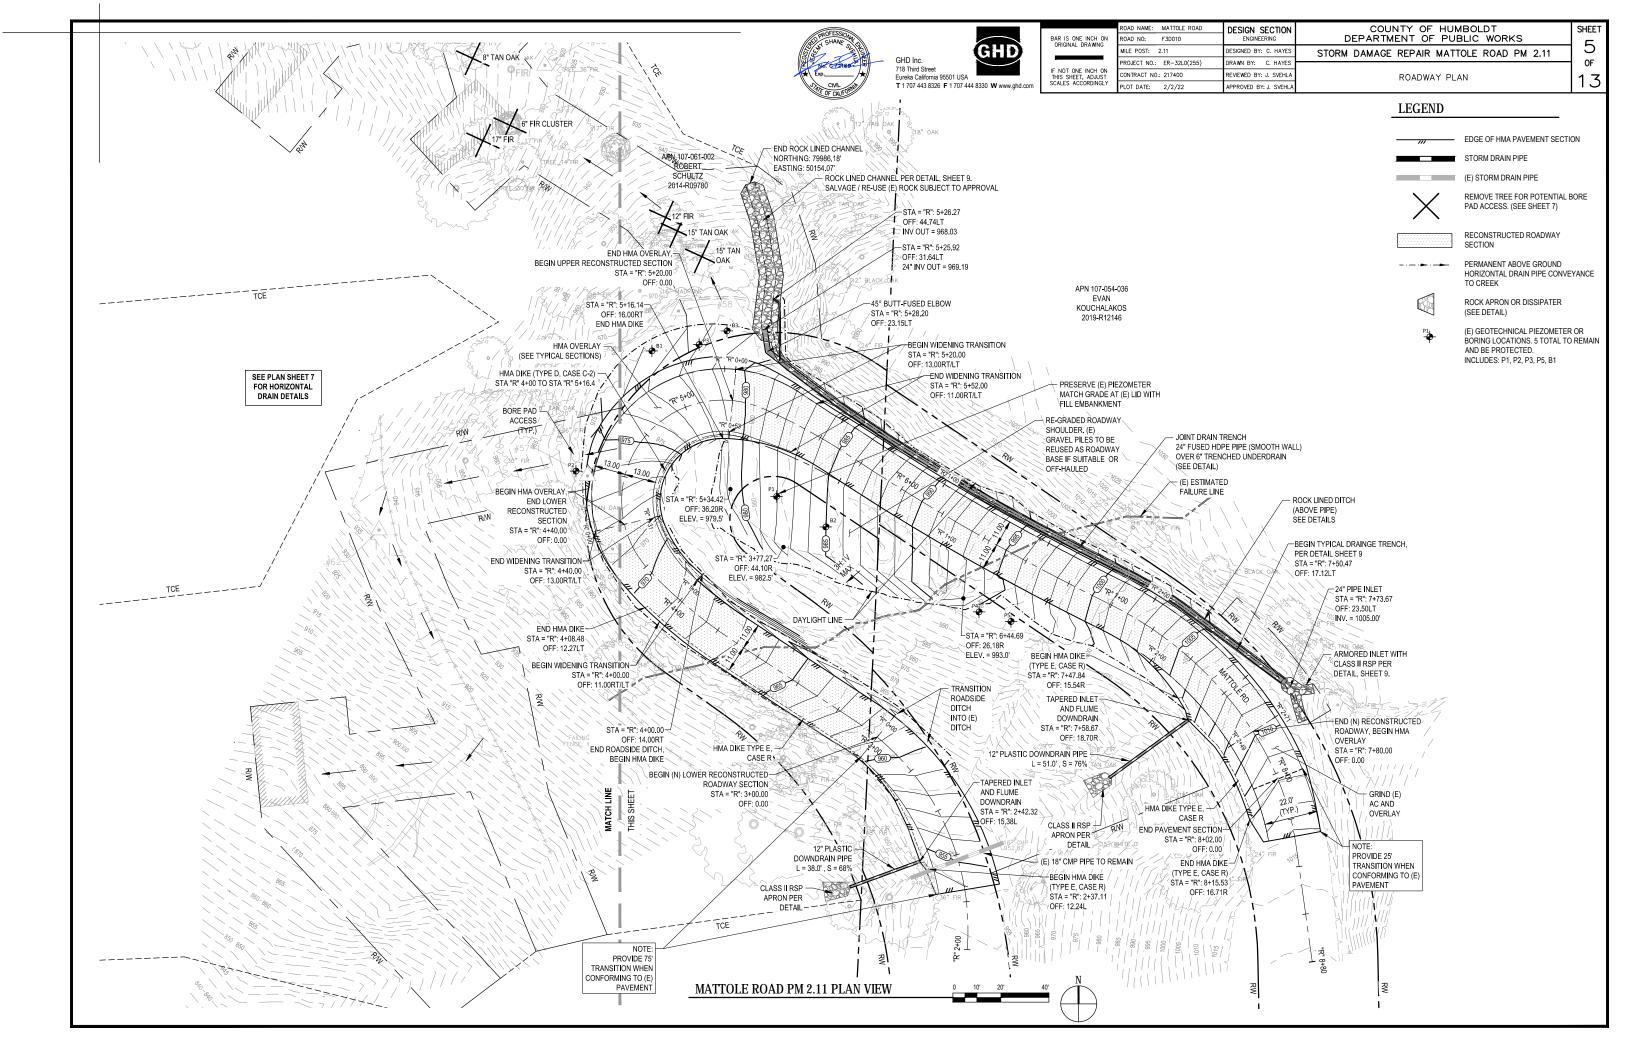

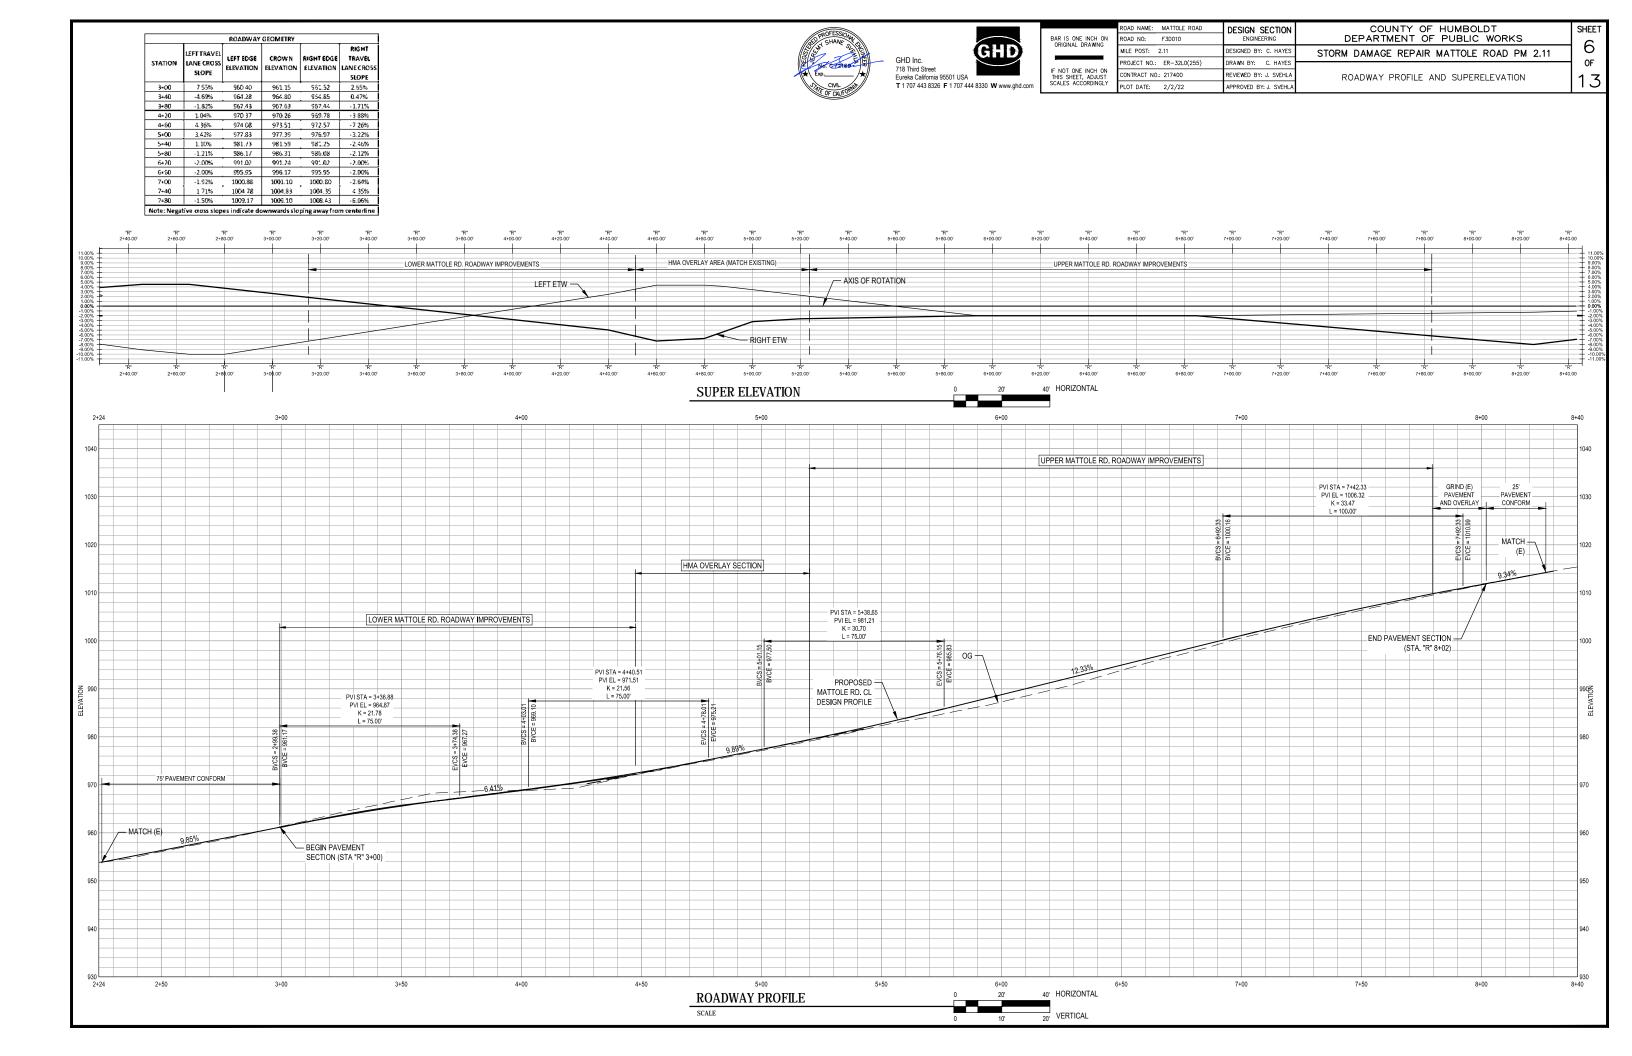

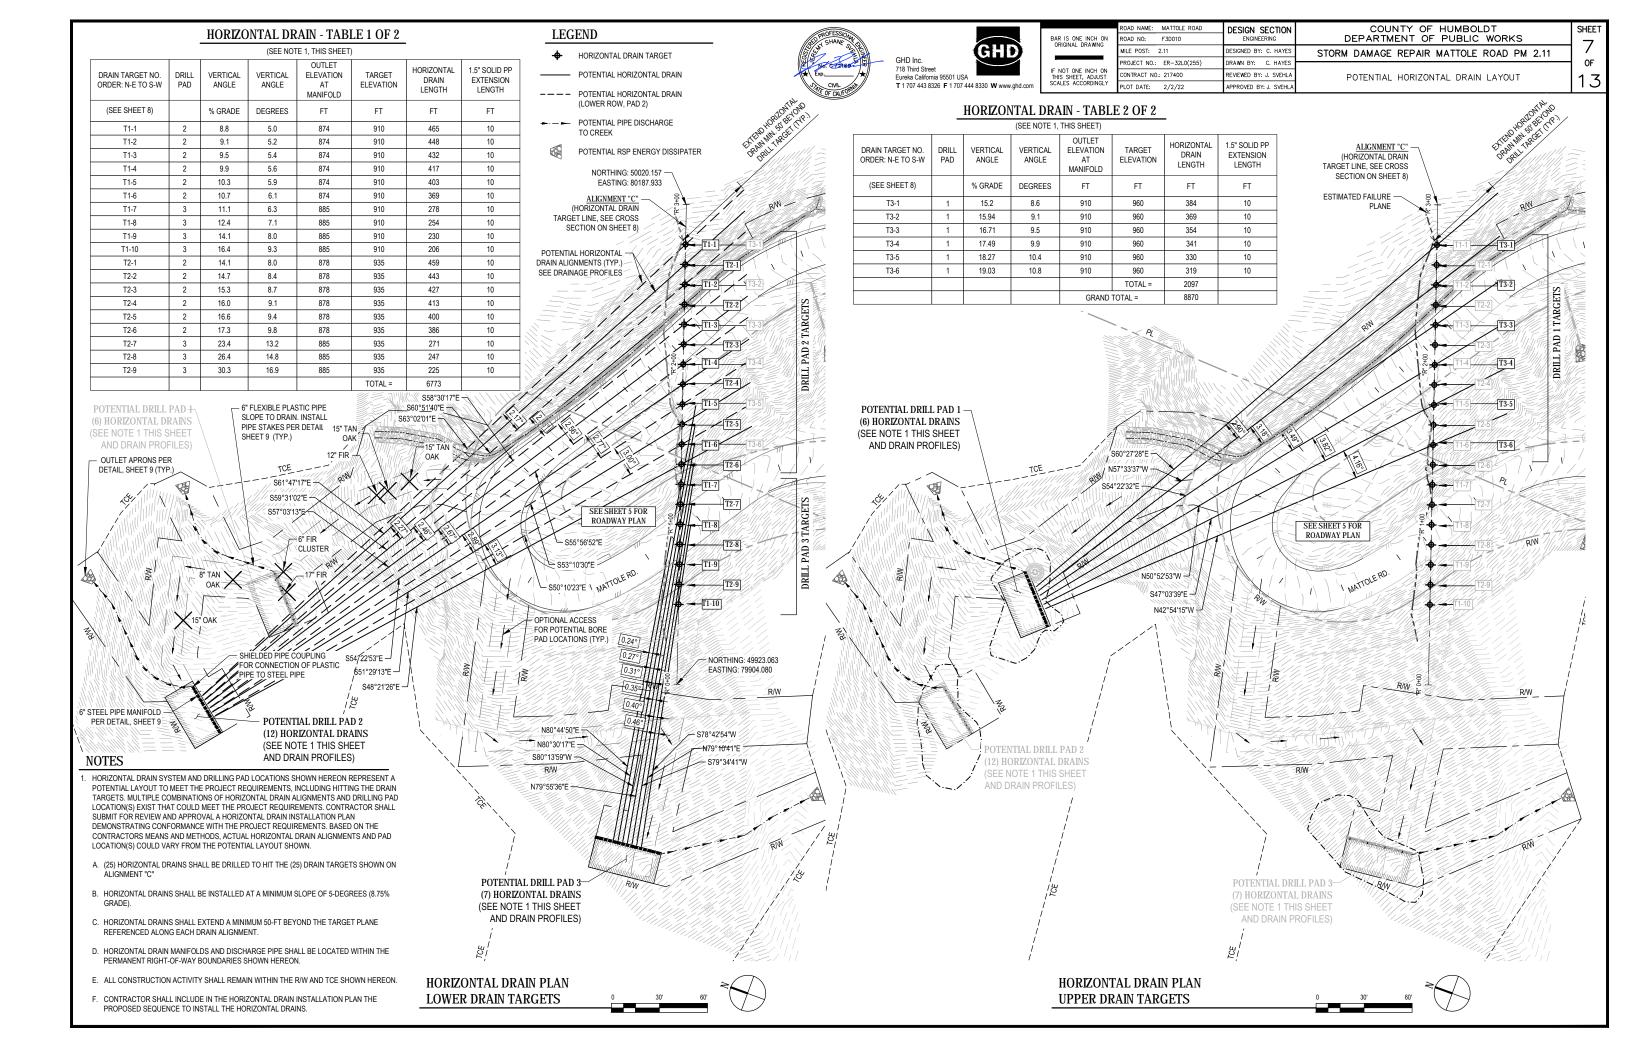

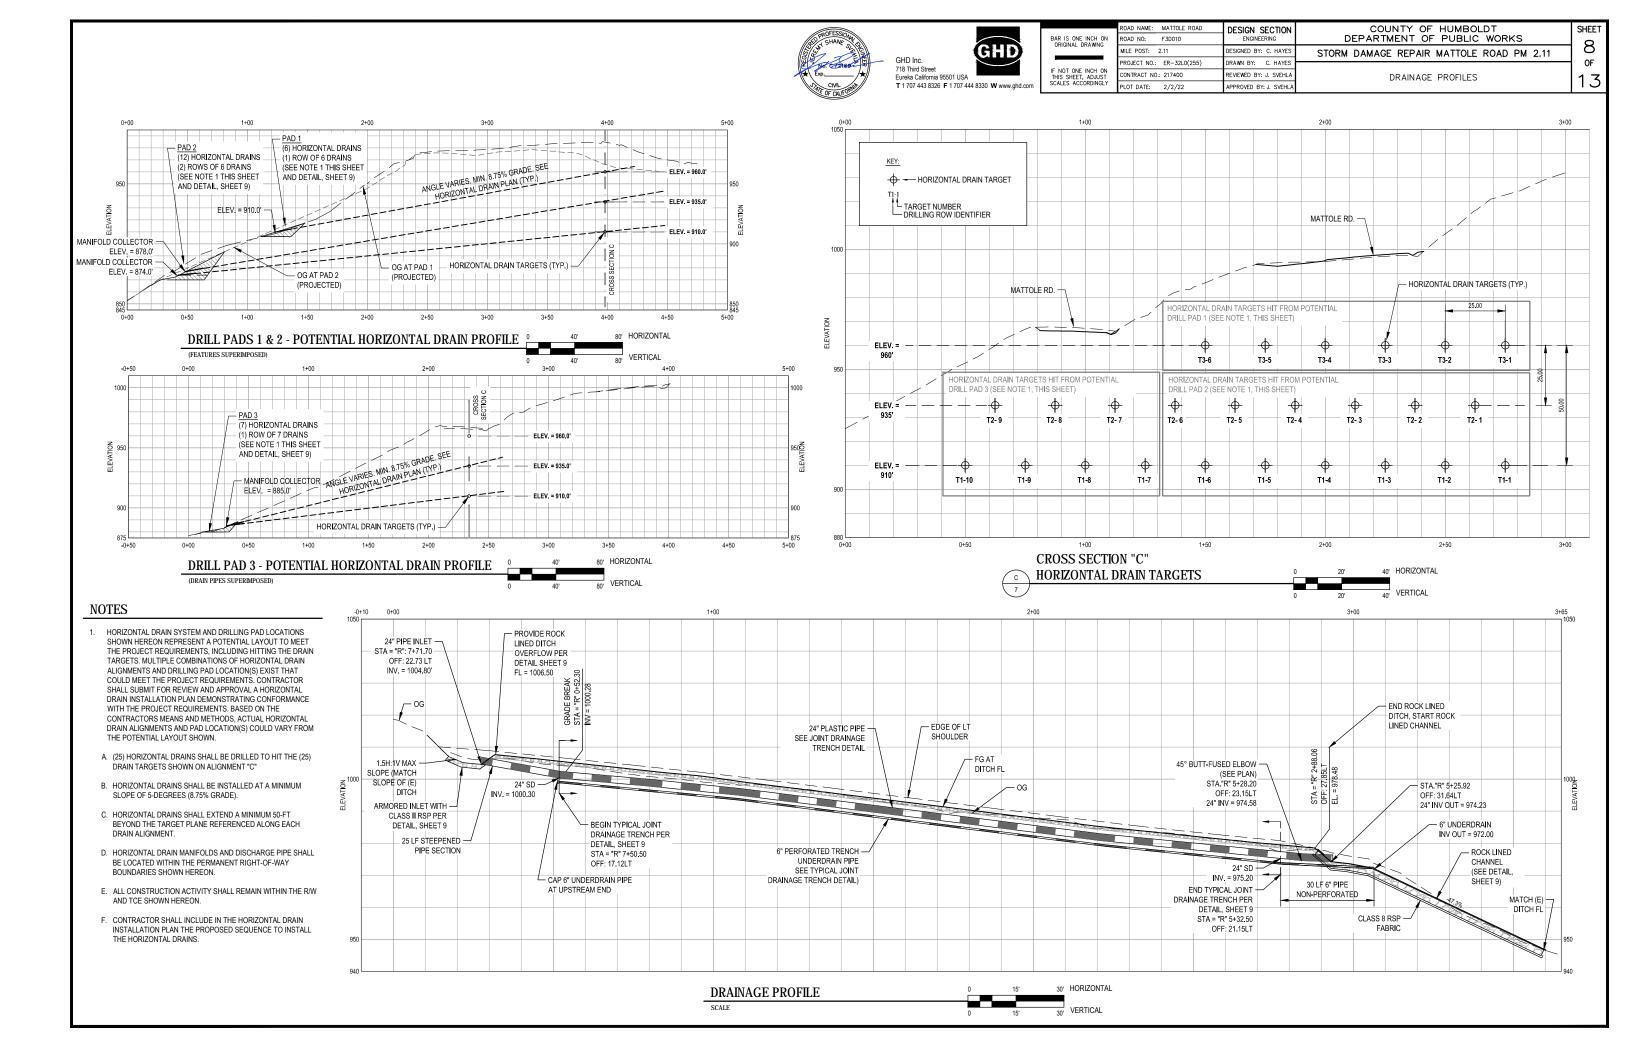

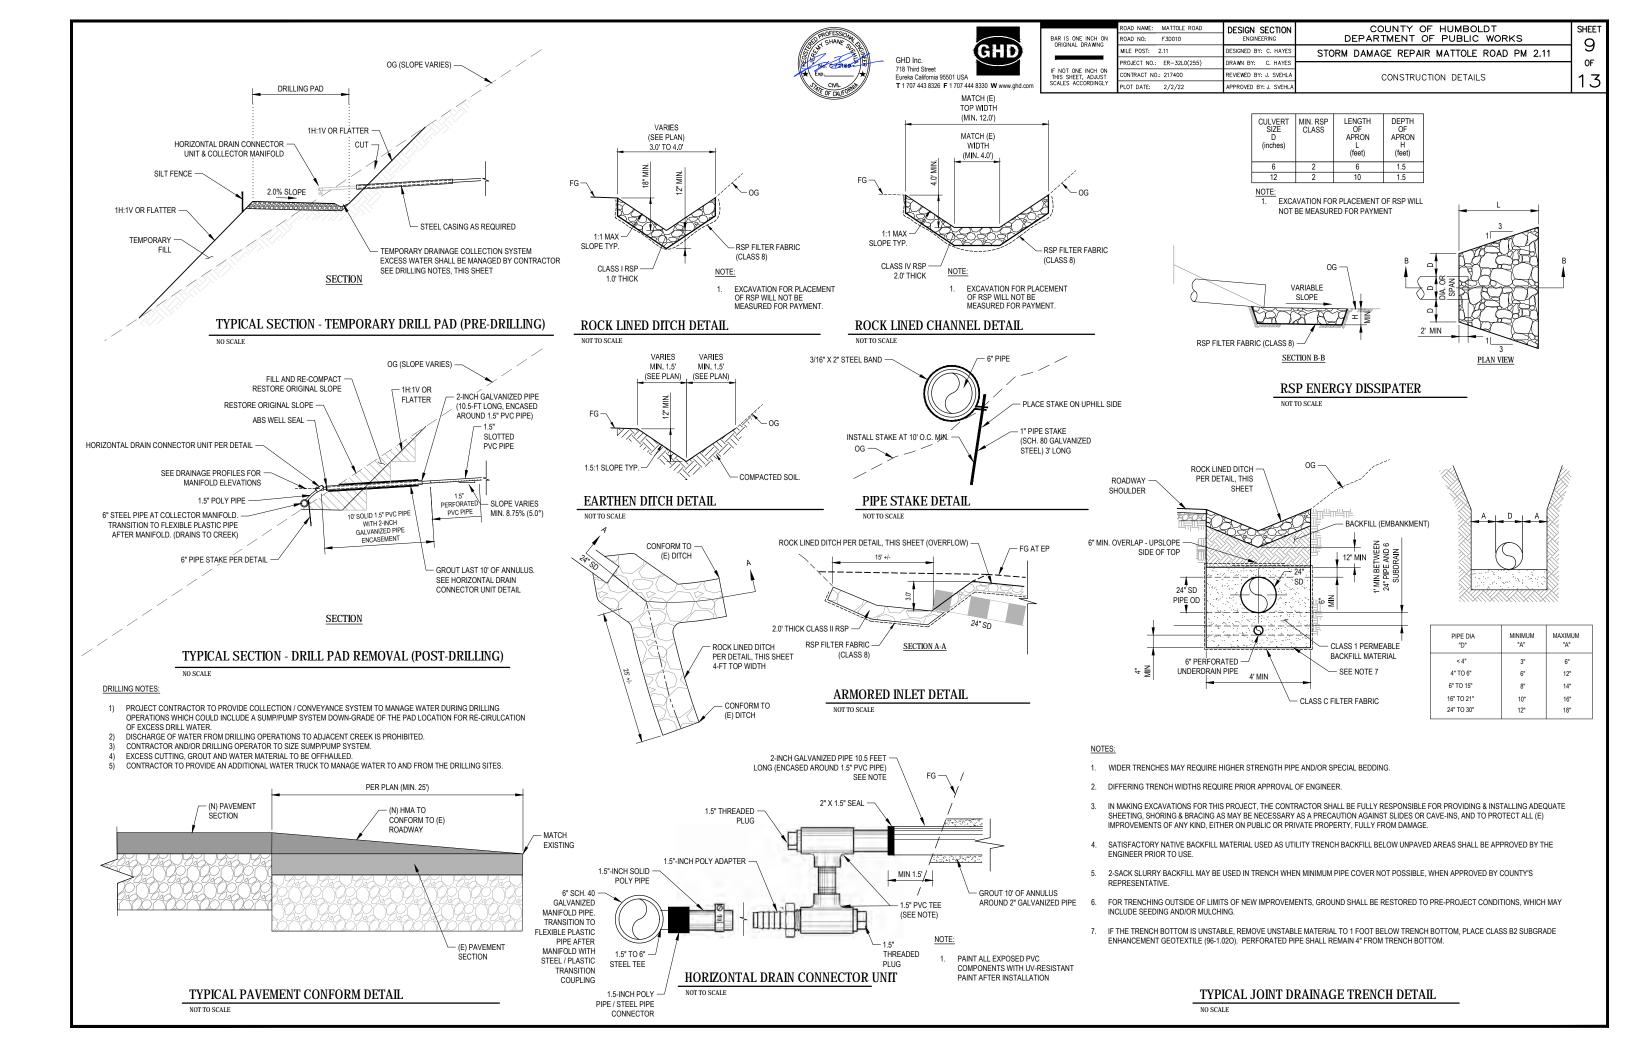




| RIGINAL DRAWING MILE POST: 2.11 DESI | |
|---|-----|
| | GNE |
| PROJECT NO.: ER-32L0(255) DRAW | MN |
| IOT ONE INCH ON SHEET, ADJUST CONTRACT NO.: 217400 REVI | EWE |
| LES ACCORDINGLY PLOT DATE: 2/2/22 APPR | ROV |

| | ROAD NAME: MATTOLE ROAD | DESIGN SECTION | Г |
|----|---------------------------|------------------------|---|
| N | ROAD NO: F3D010 | ENGINEERING | |
| | MILE POST: 2.11 | DESIGNED BY: C. HAYES | |
| | PROJECT NO.: ER-32L0(255) | DRAWN BY: C. HAYES | H |
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| Y. | PLOT DATE: 2/2/22 | APPROVED BY: J. SVEHLA | |


| COUNTY OF HUMBOLDT | SHEE |
|--|----------|
| DEPARTMENT OF PUBLIC WORKS | 1 - |
| STORM DAMAGE REPAIR MATTOLE ROAD PM 2.11 | <u> </u> |
| | OF |

ROADWAY CROSS SECTIONS 13

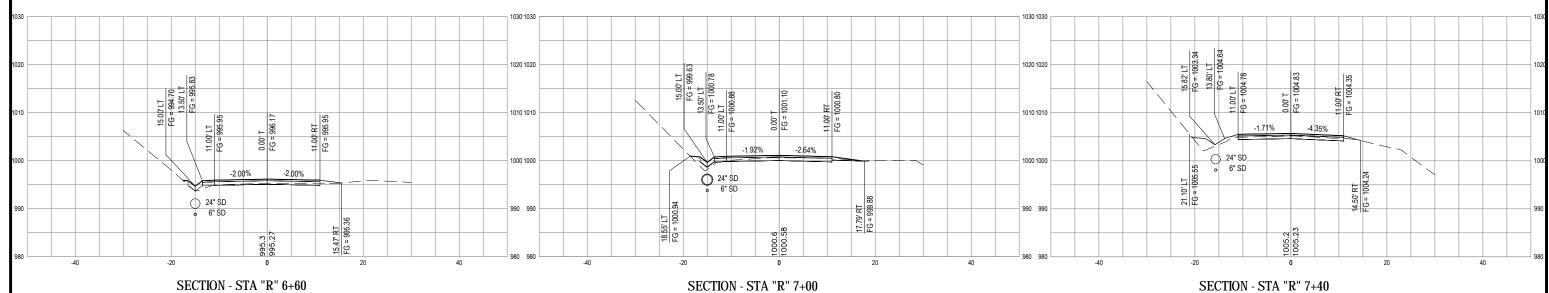

SECTION - STA "R" 7+40

NOT TO SCALE NOT TO SCALE □ 1030

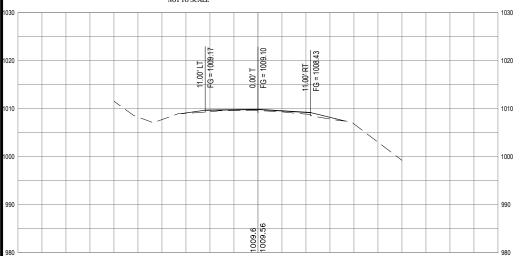

SECTION - STA "R" 7+80 NOT TO SCALE

