

**FUNDING SOURCES**




**FEMA**




**Cal OES**  
GOVERNOR'S OFFICE  
OF EMERGENCY SERVICES

BAR IS ONE INCH ON ORIGINAL DRAWING  IF NOT ONE INCH ON THIS SHEET, ADJUST SCALES ACCORDINGLY	ROAD NAME: WILDER RIDGE ROAD	DESIGN SECTION: ENGINEERING	COUNTY OF HUMBOLDT DEPARTMENT OF PUBLIC WORKS WILDER RIDGE ROAD PM 6.11 STORM DAMAGE REPAIR COVER SHEET, SHEET INDEX AND MAPS	SHEET <b>1</b> OF <b>10</b>
	ROAD NO.: 7D010	MILE POST: 6.11		
FEMA PROJECT NO.: FEMA-4301-DR-CA PW#1045				
CONTRACT NO.: 217310				
DRAWING FILE NAME: 217310_Design				
PLOT DATE: 6/8/2022				

**COUNTY OF HUMBOLDT**  
**DEPARTMENT OF PUBLIC WORKS**  
**PROJECT PLANS FOR CONSTRUCTION OF**  
**STORM DAMAGE REPAIRS ON**  
**WILDER RIDGE ROAD (7D010)**  
**at P.M. 6.11**  
**FEMA-4301-DR-CA PW-1045**  
**CONTRACT NO. 217310**

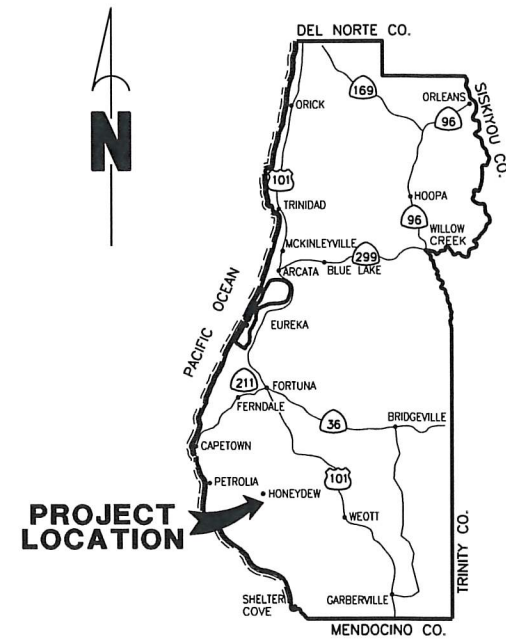

**LOCATION MAP**  
SCALE: 1"=10± MILE

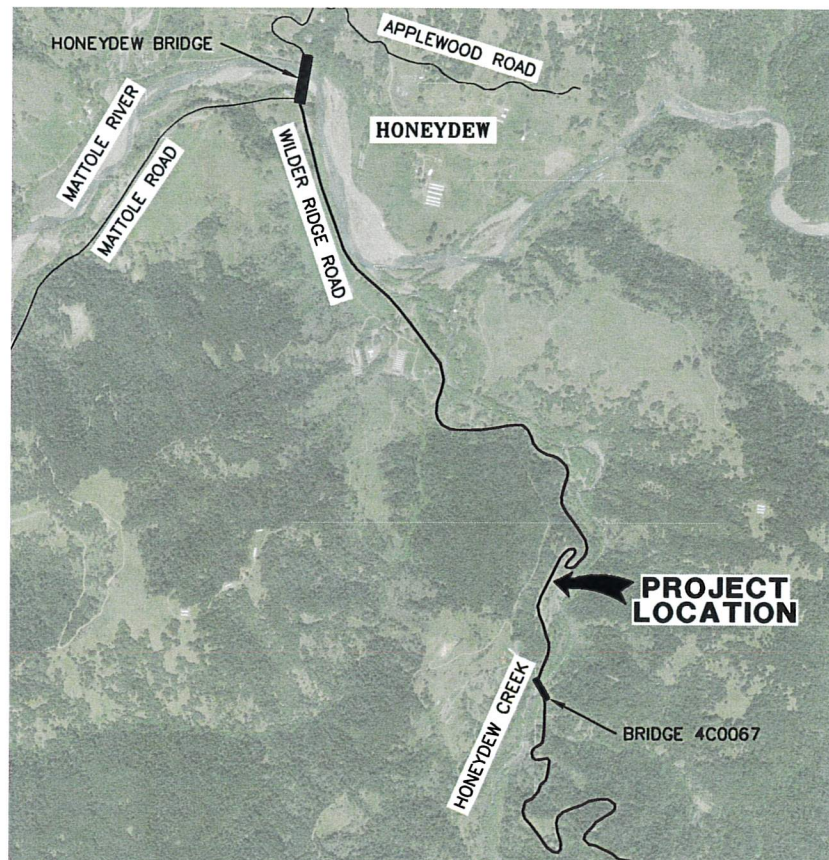

**VICINITY MAP**  
N.T.S.



**INDEX OF SHEETS**

- 1 COVER SHEET, SHEET INDEX, AND MAPS
- 2 CONSTRUCTION SIGNS & QUANTITIES
- 3 SURVEY & CONTROL
- 4-5 TYPICAL SECTION AND DETAILS
- 6-7 PLAN VIEW
- 8-9 PROFILE VIEW
- 10 EROSION CONTROL

**NOTES**

THE CONTRACTOR SHALL HAVE A CLASS "A" LICENSE FOR THIS PROJECT.

PROJECT PLANS AND SPECIAL PROVISIONS TO BE SUPPLEMENTED BY THE STATE OF CALIFORNIA DEPARTMENT OF TRANSPORTATION STANDARD PLANS, STANDARD SPECIFICATIONS, AND THE LATEST REVISED 2018 STANDARD SPECIFICATIONS  
(SEE APPLICABLE STAN PLAN LIST IN SPECIAL PROVISIONS)

**RECOMMENDED**

*Jeffrey A. Ball* 6/8/22  
 JEFFREY A. BALL  
 RCE 70631, EXP. 8/30/2023  
 DATE



**APPROVED**

*Tony R. Seghetti* 6/8/22  
 TONY R. SEGHETTI  
 RCE 63714, EXP. 9/30/2022  
 DATE



ORIGINAL LOW BID PRICE	CONSTRUCTED BY	RESIDENT ENGINEER
	PROJECT COMPLETED / /	CONSTRUCTION COST \$







ROAD NAME: WILDER RIDGE ROAD	DESIGN SECTION: ENGINEERING
ROAD NO.: 7D010	MILE POST: 6.11
FEMA PROJECT NO.: FEMA-4308-DR-CA PW#1045	DESIGNED BY: MMS
CONTRACT NO.: 217310	DRAWN BY: MMS
DRAWING FILE NAME: 217310_Design	REVIEWED BY: JAB
PLOT DATE: 6/8/2022	APPROVED BY: TRS

<b>COUNTY OF HUMBOLDT</b> <b>DEPARTMENT OF PUBLIC WORKS</b>
<b>WILDER RIDGE ROAD PM 6.11 STORM DAMAGE REPAIR</b>
<b>TRAFFIC CONTROL SIGNS AND QUANTITIES</b>

SHEET  
**2**  
OF  
**10**

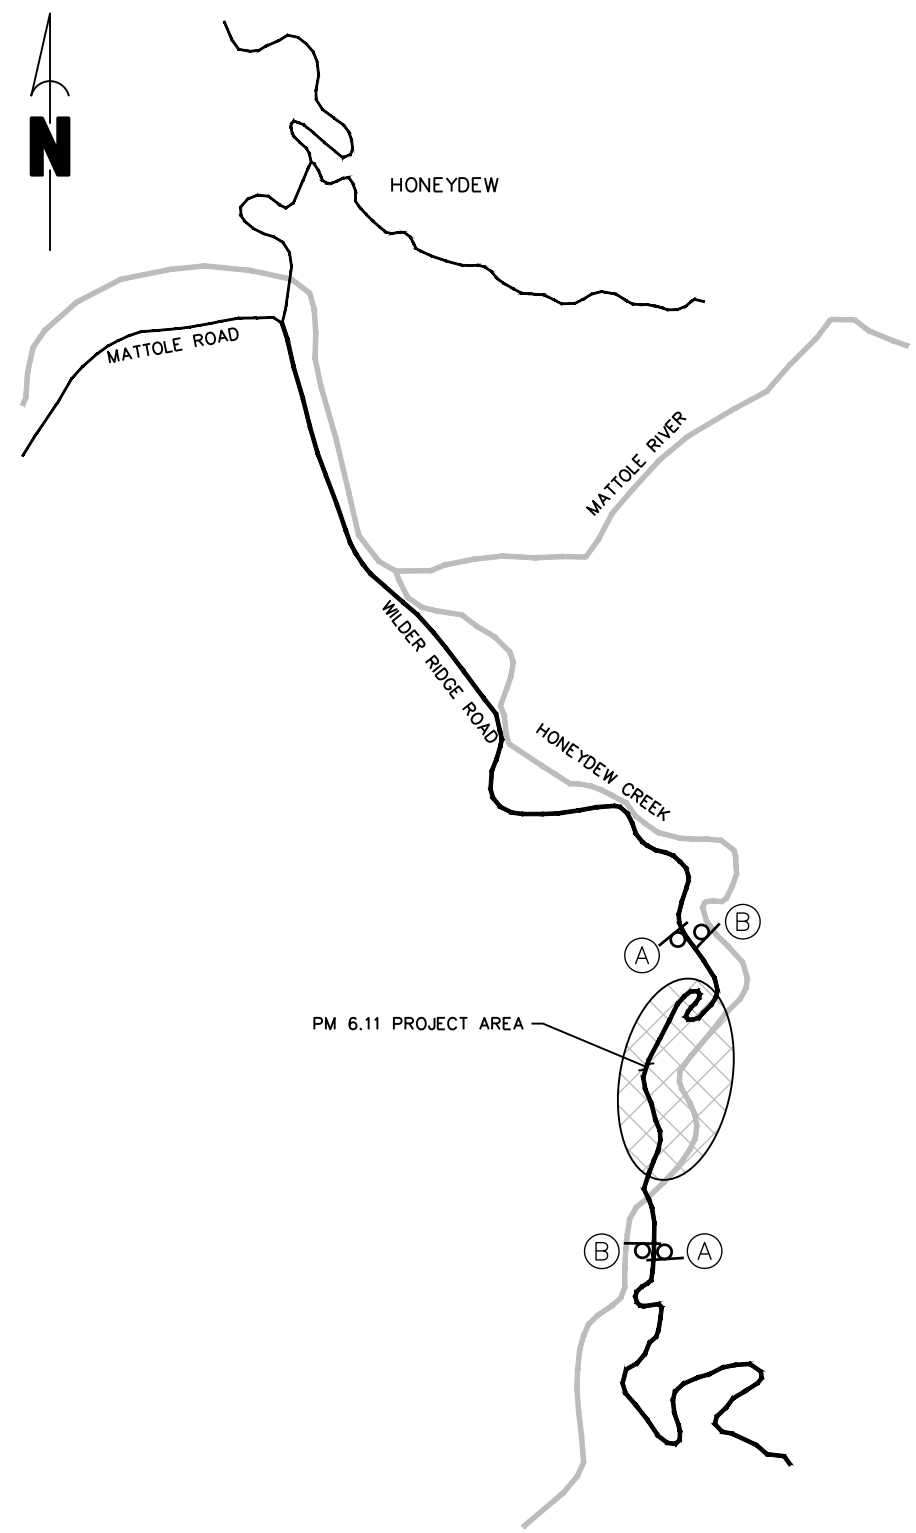

**PLAN VIEW**  
SCALE: 1"=~800'

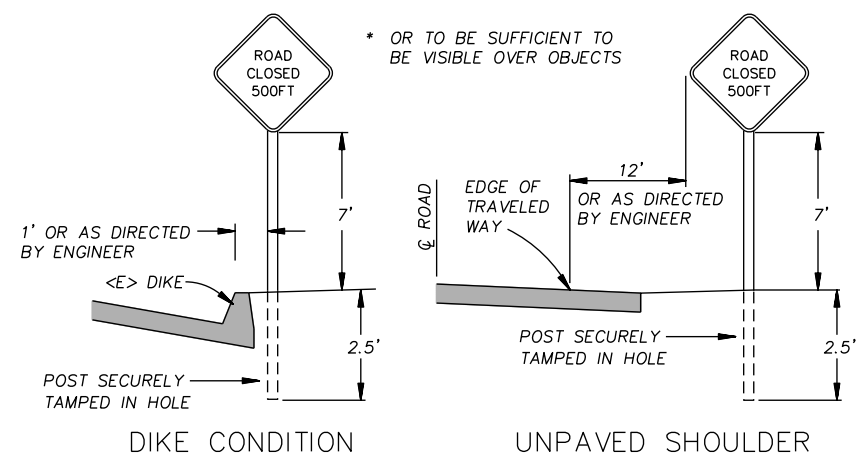

**RURAL CONSTRUCTION AREA SIGN**  
- NOT TO SCALE -

**NOTES**

- 1) SIGNS SHALL BE PLACED AS SHOWN ON PLAN OR AS DIRECTED BY THE ENGINEER.
- 2) FINAL PLACEMENT OF SIGNS SHALL BE APPROVED BY RESIDENT ENGINEER.
- 3) ADDITIONAL PORTABLE SIGNS SHALL BE USED AS REQUIRED FOR OTHER ROADSIDE WORK.
- 4) SEE STANDARD PLAN T13 FOR TRAFFIC CONTROL SYSTEM.
- 5) IN ADDITION TO CONSTRUCTION AREA SIGNS AND WHEN DIRECTED BY THE RESIDENT ENGINEER, THE CONTRACTOR SHALL UTILIZE FLAGMEN AS NECESSARY TO DIRECT TRAFFIC.
- 6) DISTANCE TO W20-1 AND G20-2 MAY BE EXTENDED TO ENCOMPASS SITES WITHIN ONE MILE OF EACH OTHER.
- 7) KEEP A MINIMUM OF 1 TRAFFIC LANE AT LEAST 10' WIDE OPEN FOR TRAFFIC, EXCEPT THE FULL WIDTH OF THE TRAVELED WAY MUST BE OPEN WHEN CONSTRUCTION OPERATIONS ARE NOT ACTIVE OR AN APPROVED TRAFFIC CONTROL PLAN IS IN PLACE.

**STOCKPILE NOTES**

- 1) MANAGE MATERIAL PER SECTION 13-4.03 (C) OF THE 2018 CALTRANS STANDARD SPECIFICATIONS
- 2) IF STOCKPILE AREA IS IN A TURNOUT- THE TURNOUT SHALL BE REESTABLISHED TO PRE-CONSTRUCTION CONDITIONS
- 3) STOCKPILE ON-SITE IF POSSIBLE

**QUANTITIES**

ITEM NO.	ITEM CODE	ITEM DESCRIPTION	UNIT	Total
1	120095	Construction Area Signs	EA	4
2	120100	Traffic Control System	LS	1
3	130100	Job Site Management	LS	1
4	130300	Prepare Storm Water Pollution Prevention Plan	LS	1
5	130310	Rain Event Action Plan	EA	3
6	130320	Storm Water Sampling and Analysis	EA	3
7	130330	Storm Water Annual Report	EA	1
8	130610	Temporary Check Dam	LF	30
9	170103	Clearing and Grubbing	LS	1
10	190101	F Roadway Excavation	CY	240
11	210212	Dry Seed	SQFT	22,430
12	210280	Rolled Erosion Control Product (Blanket)	SQFT	970
13	210350	Fiber Rolls	LF	340
14	210420	Straw	SQFT	21,460
15	260202	Class 2 Aggregate Base	TON	450
16	390132	Hot Mix Asphalt (Type A)	TON	861
17	394073	Place Hot Mix Asphalt Dike (Type A)	LF	200
18	600021	F Remove Retaining Wall	LS	1
19	600029	F Remove Asphalt Concrete Surfacing	SQFT	21,460
20	600030	F Decommission Roadway	LS	1
21	710130	Remove Culvert (EA)	EA	6
22	839752	Remove Guardrail	LF	165
23	999990	Mobilization	LS	1

**CONSTRUCTION AREA SIGN SUMMARY**

REF	SIGN TYPE	QTY	DESCRIPTION	SIZE	REMARKS	POST SIZE	NUMBER
(A)	W20-1	2	ROAD WORK AHEAD	30" x 30"	VISIBLE AT ALL TIMES	4" x 4"	1
(B)	G20-2	2	END ROAD WORK	36" x 18"	VISIBLE AT ALL TIMES	4 x 4	1



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	ROAD NO.: 7D010	MILE POST: 6.11		
	FEMA PROJECT NO.: FEMA-4308-DR-CA PW#1045	DESIGNED BY: MMS		
	CONTRACT NO.: 217310	DRAWN BY: MMS		
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	PLOT DATE: 6/8/2022	APPROVED BY: TRS		

**ALIGNMENT GEOMETRY TABLE**

No.	Type	Length	Radius	Direction	Start Station	End Station	Delta angle	Start Direction	End Direction
L1	Line	128.12'		S54° 01' 15"W	0+00.00'	1+28.12'			
C1	Curve	37.81'	40.00'		1+28.12'	1+65.93'	54°09'11"	S54° 01' 15"W	N71° 49' 34"W
C2	Curve	91.41'	45.00'		1+65.93'	2+57.34'	116°23'05"	N71° 49' 34"W	N44° 33' 31"E
L2	Line	91.26'		N44° 33' 31"E	2+57.34'	3+48.60'			
C3	Curve	30.97'	80.00'		3+48.60'	3+79.56'	22°10'44"	N44° 33' 31"E	N22° 22' 47"E
L3	Line	27.48'		N22° 22' 47"E	3+79.56'	4+07.05'			
C4	Curve	48.60'	35.00'		4+07.05'	4+55.65'	79°34'00"	N22° 22' 47"E	N57° 11' 13"W
C5	Curve	92.96'	80.00'		4+55.65'	5+48.61'	66°34'27"	N57° 11' 13"W	S56° 14' 20"W
C6	Curve	59.99'	140.00'		5+48.61'	6+08.60'	24°33'09"	S56° 14' 20"W	S31° 41' 10"W
L4	Line	119.03'		S31° 41' 10"W	6+08.60'	7+27.64'			
C7	Curve	60.41'	325.00'		7+27.64'	7+88.05'	10°38'59"	S31° 41' 10"W	S21° 02' 11"W
C8	Curve	219.13'	860.00'		7+88.05'	10+07.18'	14°35'57"	S21° 02' 11"W	S35° 38' 08"W
L5	Line	94.66'		S35° 38' 08"W	10+07.18'	11+01.83'			
C9	Curve	177.41'	860.00'		11+01.83'	12+79.24'	11°49'10"	S35° 38' 08"W	S23° 48' 58"W
C10	Curve	247.12'	260.00'		12+79.24'	15+26.36'	54°27'25"	S23° 48' 58"W	S30° 38' 27"E
C11	Curve	113.08'	550.00'		15+26.36'	16+39.44'	11°46'48"	S30° 38' 27"E	S18° 51' 39"E
C12	Curve	28.07'	100.00'		16+39.44'	16+67.50'	16°04'50"	S18° 51' 39"E	S2° 46' 49"E
L6	Line	98.68'		S2° 46' 49"E	16+67.50'	17+66.18'			
C13	Curve	41.95'	150.00'		17+66.18'	18+08.13'	16°01'28"	S2° 46' 49"E	S18° 48' 17"E
L7	Line	50.76'		S18° 48' 17"E	18+08.13'	18+58.89'			

**CONTROL POINTS TABLE**


Point Table				
Point #	Row Description	Elevation	Northing	Easting
51	CP_R+C_PWS_CNTRL	477.933	1972712.2650	5972290.3720
67	FD_COUNTY_MON	436.321	1971600.7760	5972122.7960
75	CP_SPK	442.250	1973100.4419	5972743.1648
52	CP_R+C_PWS_CNTRL	455.281	1972782.5340	5972403.4280
76	CP_SPK	432.295	1973334.1661	5972680.2403
53	CP_12IN_SPIKE	450.190	1972859.7120	5972468.7870
62	FD_60D_HUMCO_CP11	505.283	1972298.5410	5971994.3780
63	CP_SPK	495.823	1972591.2840	5972164.1010
77	CP_SPK	444.998	1972994.3473	5972674.4308
78	CP_SPK	451.344	1972894.9657	5972536.3377
90	CP_12IN_SPIKE	497.588	1972423.2320	5972108.1130
91	CP_12IN_SPIKE	494.246	1972316.4360	5972120.0850
92	CP_12IN_SPIKE	475.645	1972128.1110	5972173.0510
93	CP_MAG	457.014	1971902.8250	5972212.3610
94	CP_SPK	459.338	1972025.6200	5972186.4010
95	CP_SPK_OLD_73	479.566	1972173.9420	5972175.6110
79	CP_MAG	454.531	1972685.8243	5972364.5063

**SURVEY NOTES**

1. THE PURPOSE OF THIS SURVEY IS TO DETERMINE TOPOGRAPHY FOR A PROPOSED PERMANENT ROAD RE-ALIGNMENT AT THE WILDER RIDGE ROAD FAILURE PM 6.11. POINTS WEST PERFORMED SURVEYING TASKS IN FEB. 2017 FOR ORIGINAL DETOUR AND AN AS-BUILT SURVEY OF THE TEMPORARY ROAD; THIS SURVEY APPENDS PRIOR SURVEY WORK. AS ON PREVIOUS PROJECTS POINTS WEST SURVEYING'S WORK IS SUPPLEMENTED WITH SURVEY DATA FROM A 1999 COUNTY PROJECT FOR THIS AREA. DATA FROM SAID SURVEY WAS TRANSLATED TO THIS JOB USING TIES TO CONTROL POINTS 3 AND 11 THEREIN (PWS CONTROL POINTS 67 AND 62 RESPECTIVELY). THE COUNTY SURVEY LOCATED THE APPROXIMATE PROPERTY LINE SHOWN AND INCLUDED TOPOGRAPHY IN THE NOW-FAILED SECTION OF BOTH LANDERGEN AND WILDER RIDGE ROADS; DATA SHOWN WAS NOT VERIFIED AND IS SHOWN TO SHOW ORIGINAL ALIGNMENT OF WILDER RIDGE ROAD AND LANDERGEN ROAD (HORIZONTAL ONLY). SEE NOTE 3 BELOW FOR DATUM TO WHICH COUNTY DATA WAS TRANSLATED. PER COUNTY RIGHT OF WAY DEPT. THE RIGHT OF WAY ON WILDER RIDGE ROAD IS 66 FEET WIDE CENTERED ON EXISTING ROAD PHYSICAL CENTERLINE. THE LIMIT OF OWNERSHIP PER "APPROXIMATE PROPERTY LINE PER COUNTY SURVEY" WAS NOT VERIFIED THIS SURVEY. THE CENTER OF HONEYDEW CREEK IS THE EASTERLY LIMIT OF LANDS OF U.S.A. PER DOCUMENT 1818 O.R. 946 AND WAS NOT LOCATED THIS SURVEY.
2. UNDERGROUND UTILITIES SHOWN HEREON ARE BASED ON TIES MADE IN THE FIELD TO VISIBLE UTILITY STRUCTURES. NO PG&E PLANS WERE MADE AVAILABLE AND THE EXISTENCE OF OTHER UNDERGROUND STRUCTURES INCLUDING SEPTIC TANKS IS UNKNOWN. SEE UNDERGROUND UTILITY NOTE BELOW.
3. COORDINATES FOR THIS SURVEY ARE CALIFORNIA COORDINATE SYSTEM OF 1983 (CCS83) BASED ON A STATIC GPS CONTROL SURVEY. THE MAPPING ANGLE IS 1 DEGREE 22 MINUTES 49 SECONDS- ROTATE BEARINGS COUNTERCLOCKWISE BY THIS ANGLE TO OBTAIN "TRUE" OR GEODETIC BEARINGS. GRID DISTANCES SHOWN SHOULD BE DIVIDED BY THE COMBINED SCALE FACTOR OF 0.99993272 TO OBTAIN GROUND DISTANCES. MAPPING ANGLE AND GRID SCALE FACTOR TAKEN AT CONTROL POINT NO. 51. HORIZONTAL CONTROL IS NAD 83 (2011) BASED STATIC GPS TIE TO NGS PID 'LU2349', AN NGS HPGN NETWORK POINT IN WEOTT WITH DESIGNATION 'HPGN D CA 01 MC'. VERTICAL CONTROL IS ALSO BASED ON NGS PID 'LU2349', NAVD 88 DATUM, WITH ELEVATION OF 335.8 FEET.
4. ONLY TREES GREATER THAN 18 INCHES IN DIAMETER WERE LOCATED- NUMEROUS OTHER TREES EXIST IN SURVEYED AREA AND ARE NOT SHOWN. INTERIOR FENCING NOT SHOWN IN ALL LOCATIONS.
5. ORTHOPHOTO IS 2016 NAIP IMAGERY AND DOES NOT SHOW NEW SLIDE; IT IS INTENDED FOR GENERAL ORIENTATION PURPOSES ONLY.

**MONUMENT PRESERVATION NOTES**

- CONTRACTOR TO USE EXTREME CAUTION WHILE WORKING IN THE VICINITY OF MONUMENTS.
- IMMEDIATELY CONTACT THE HUMBOLDT COUNTY SURVEY DIVISION (707)445-7205, IF MONUMENTS ARE DISTURBED OR WILL BE IMPACTED BY CONSTRUCTION WORK.
- HISTORICAL MONUMENT IS POINT # 67

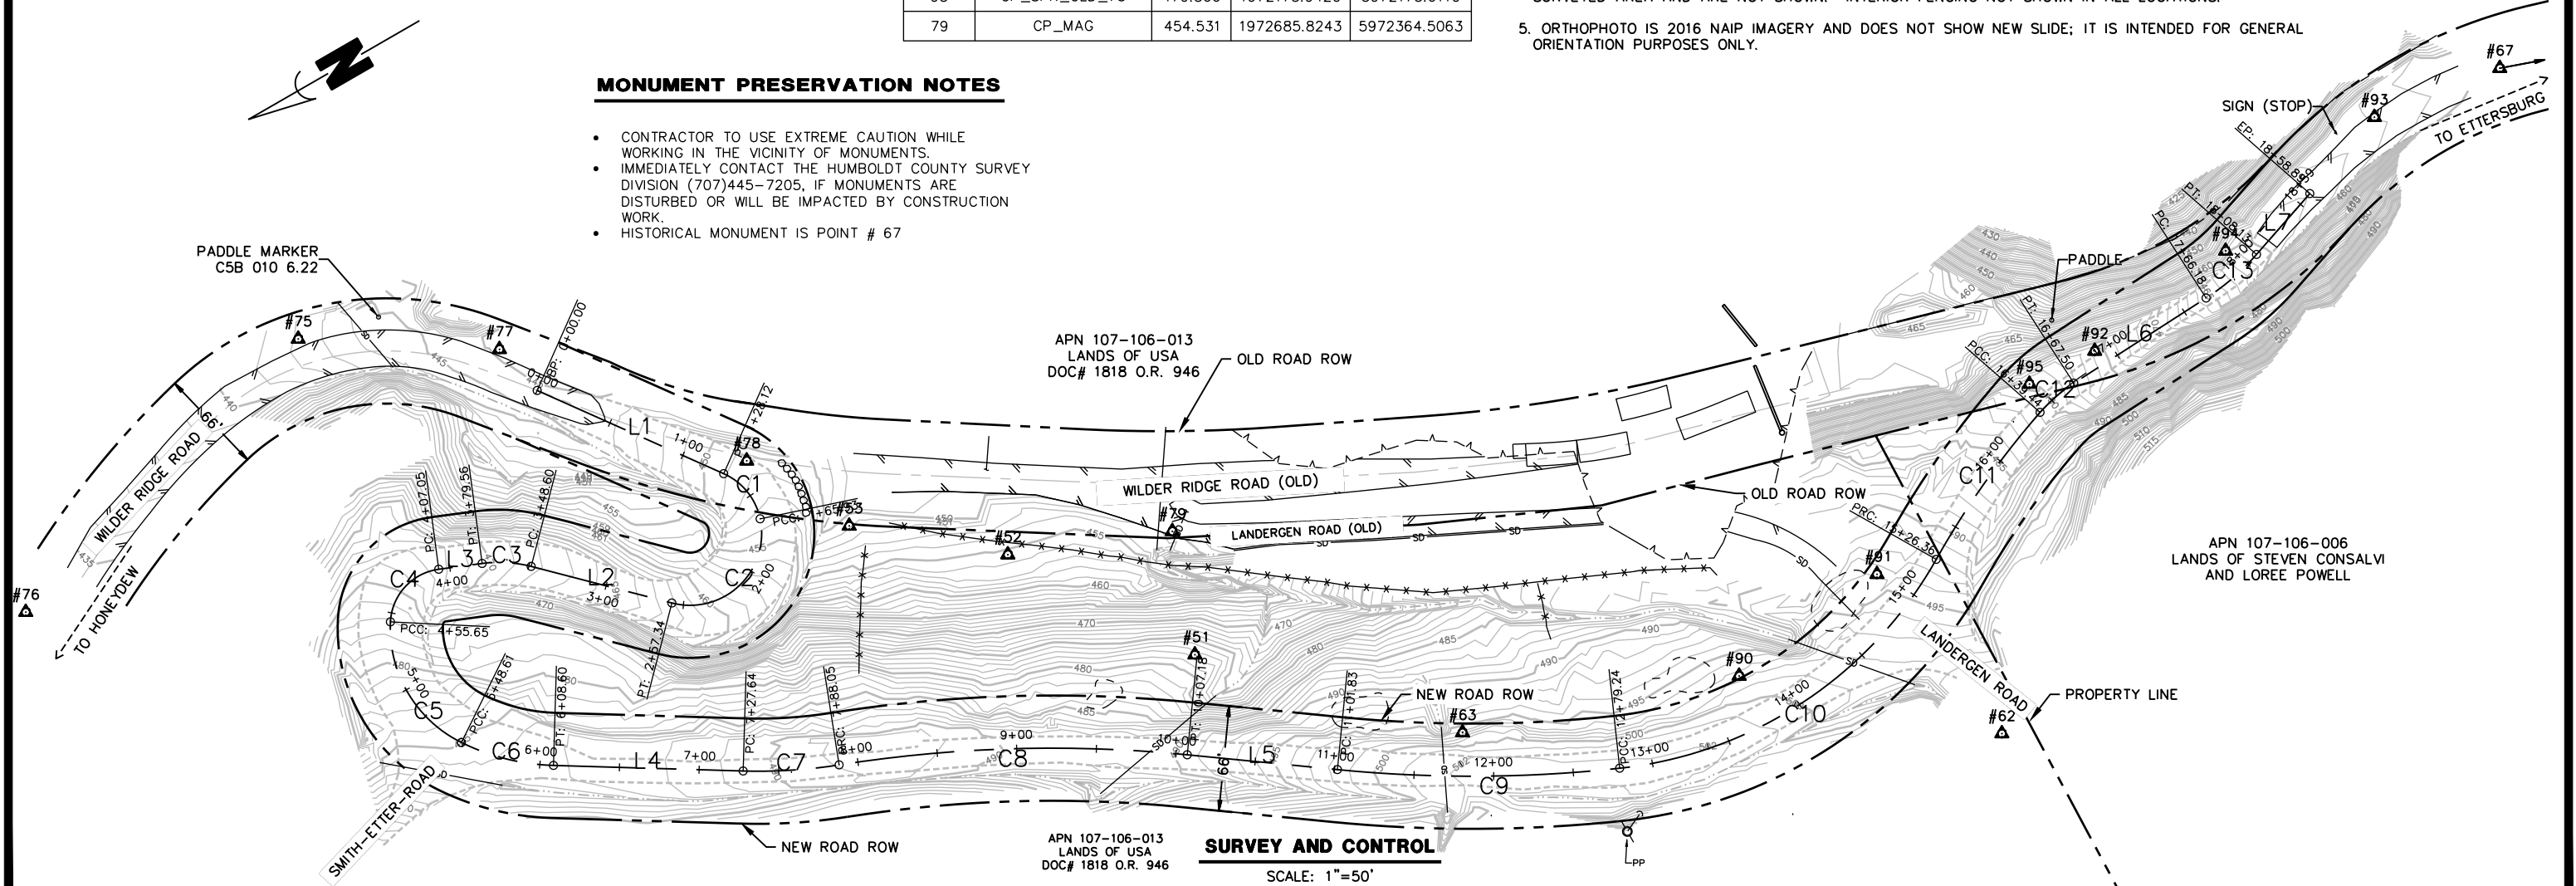


**SURVEY AND CONTROL**  
SCALE: 1"=50'



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	MILE POST: 6.11	DESIGNED BY: MMS
	FEMA PROJECT NO.: FEMA-4308-DR-CA PW#1045	DRAWN BY: MMS
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<b>COUNTY OF HUMBOLDT</b> <b>DEPARTMENT OF PUBLIC WORKS</b> <b>WILDER RIDGE ROAD PM 6.11 STORM DAMAGE REPAIR</b> <b>TYPICAL SECTIONS (1 OF 2)</b>
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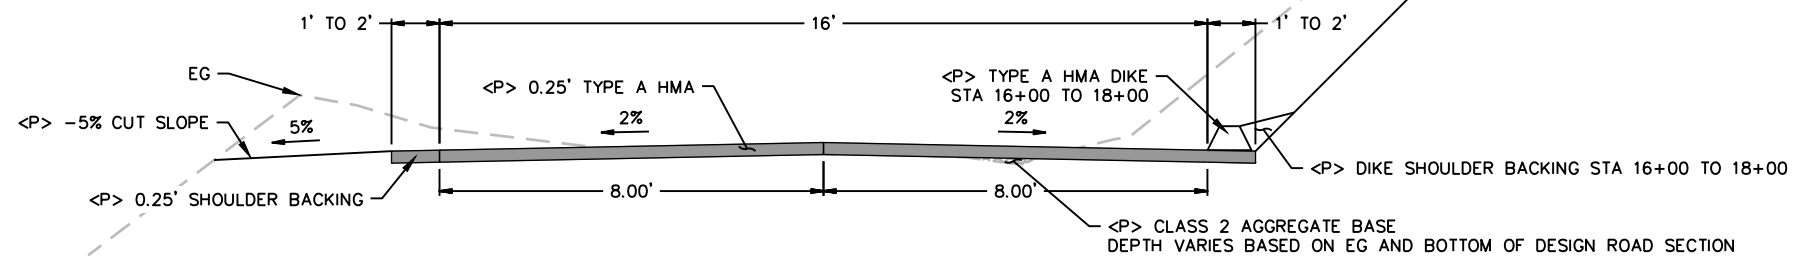
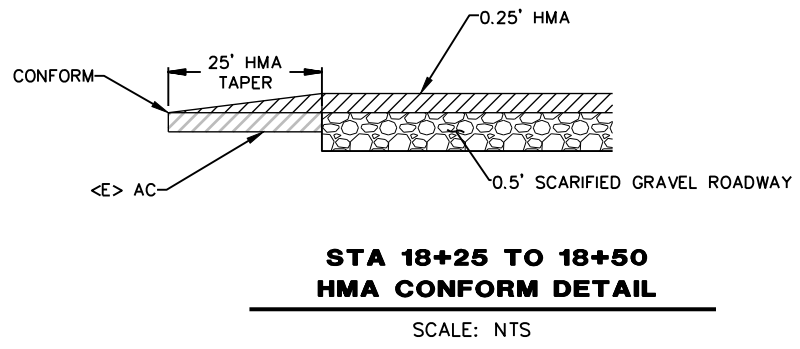
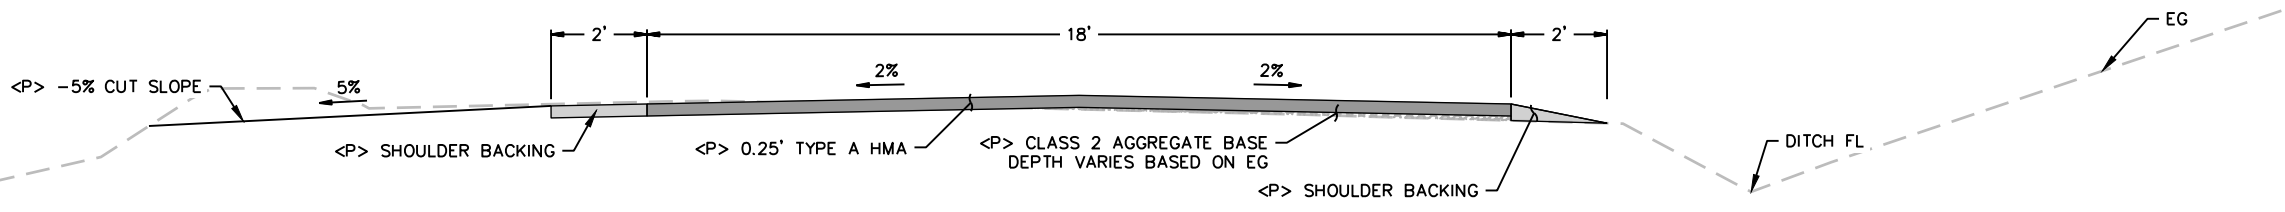
SHEET  
**4**  
OF  
**10**




**ROADWAY EXCAVATION NOTES**

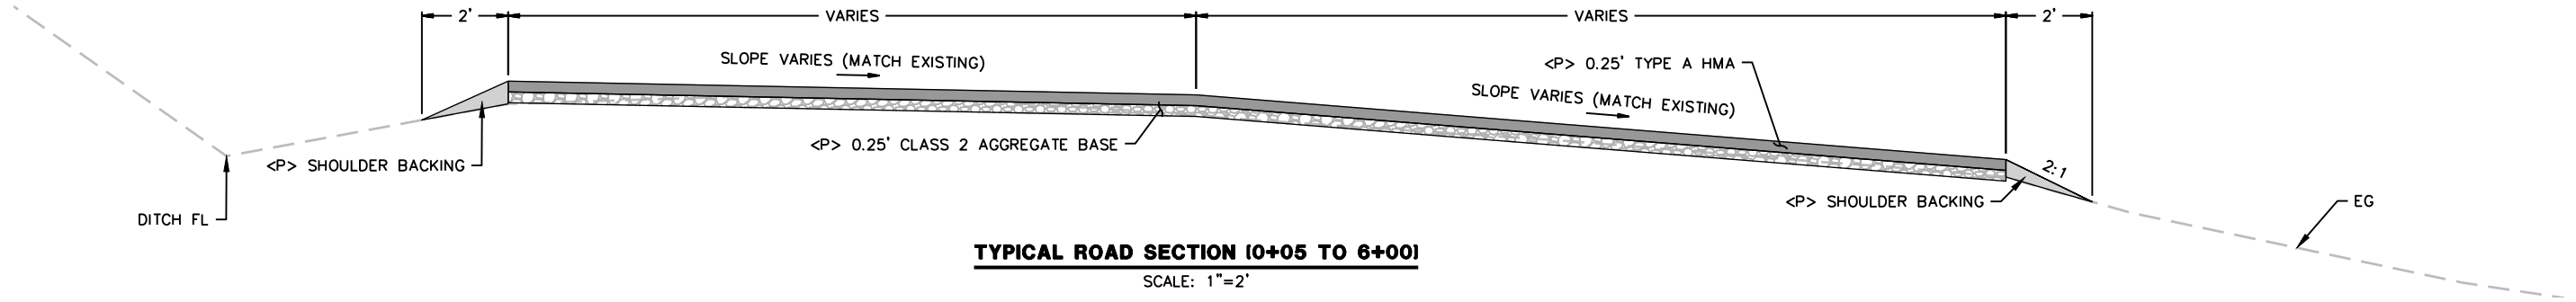1. SCARIFY AND RE-COMPACT THE EXISTING GRAVEL ROADWAY FOR A WIDTH EQUAL TO THE PROPOSED PAVED ROAD WIDTH AND A DEPTH OF 0.50'. AFTER RE-COMPACTION, THE IN-PLACE MATERIAL MUST ACHIEVE 95% RC. SCARIFYING AND RE-COMPACTING EXISTING MATERIAL IS INCIDENTAL TO AGGREGATE BASE AND PAVING ITEMS. SHOULDER BACKING IS INCIDENTAL TO PAVING ITEM.
2. FROM STA 0+05 TO 6+00, PLACE AND COMPACT 0.25' OF CLASS 2 AGGREGATE BASE TO 95% RC. MAINTAIN THE EXISTING ROAD GEOMETRY AND CROSS SLOPES THROUGHOUT THIS SECTION. ROAD WIDTH WILL MATCH THE EXISTING SURVEYED EDGE OF TRAVELED WAY.
3. FROM STA 6+00 TO 16+00, ADDITIONAL FILL REQUIRED TO ACHIEVE THE ASPHALT ROADWAY DESIGN FG IS A QUANTITY PAID UNDER CLASS 2 AGGREGATE BASE.
4. ADDITIONAL PAVING IS INCLUDED FOR THE FORK AT SMITH-ETTER ROAD FROM 5+15 TO 5+75
5. ADDITIONAL PAVING IS INCLUDED FOR THE FORK AT LANDERGEN ROAD FROM 14+25 TO 15+60
6. SHOULDER WIDTH BETWEEN 16+75 AND 18+25 VARIES AS FOLLOWS:
  - 6.1. 16+75 TO 17+10: 2' SHOULDERS
  - 6.2. 17+10 TO 18+00: 1' SHOULDERS
  - 6.3. 18+00 TO 18+25: 2' SHOULDERS
7. STRIPING WILL BE COMPLETED BY COUNTY FORCES

**TYPICAL ROAD SECTION (16+00 TO 16+75)**  
SCALE: 1"=2'



**TYPICAL ROAD SECTION (16+75 TO 18+25)**  
SCALE: 1"=2'

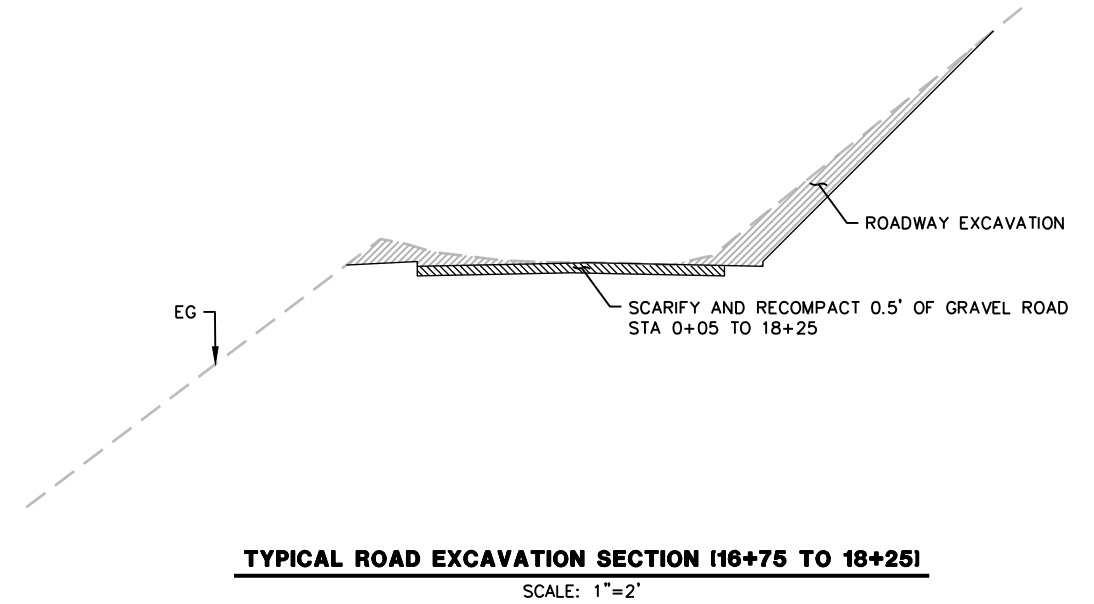


**TYPICAL ROAD EXCAVATION SECTION (16+75 TO 18+25)**  
SCALE: 1"=2'



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	ROAD NO.: 7D010	ENGINEERING	
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SHEET  
**5**  
OF  
**10**

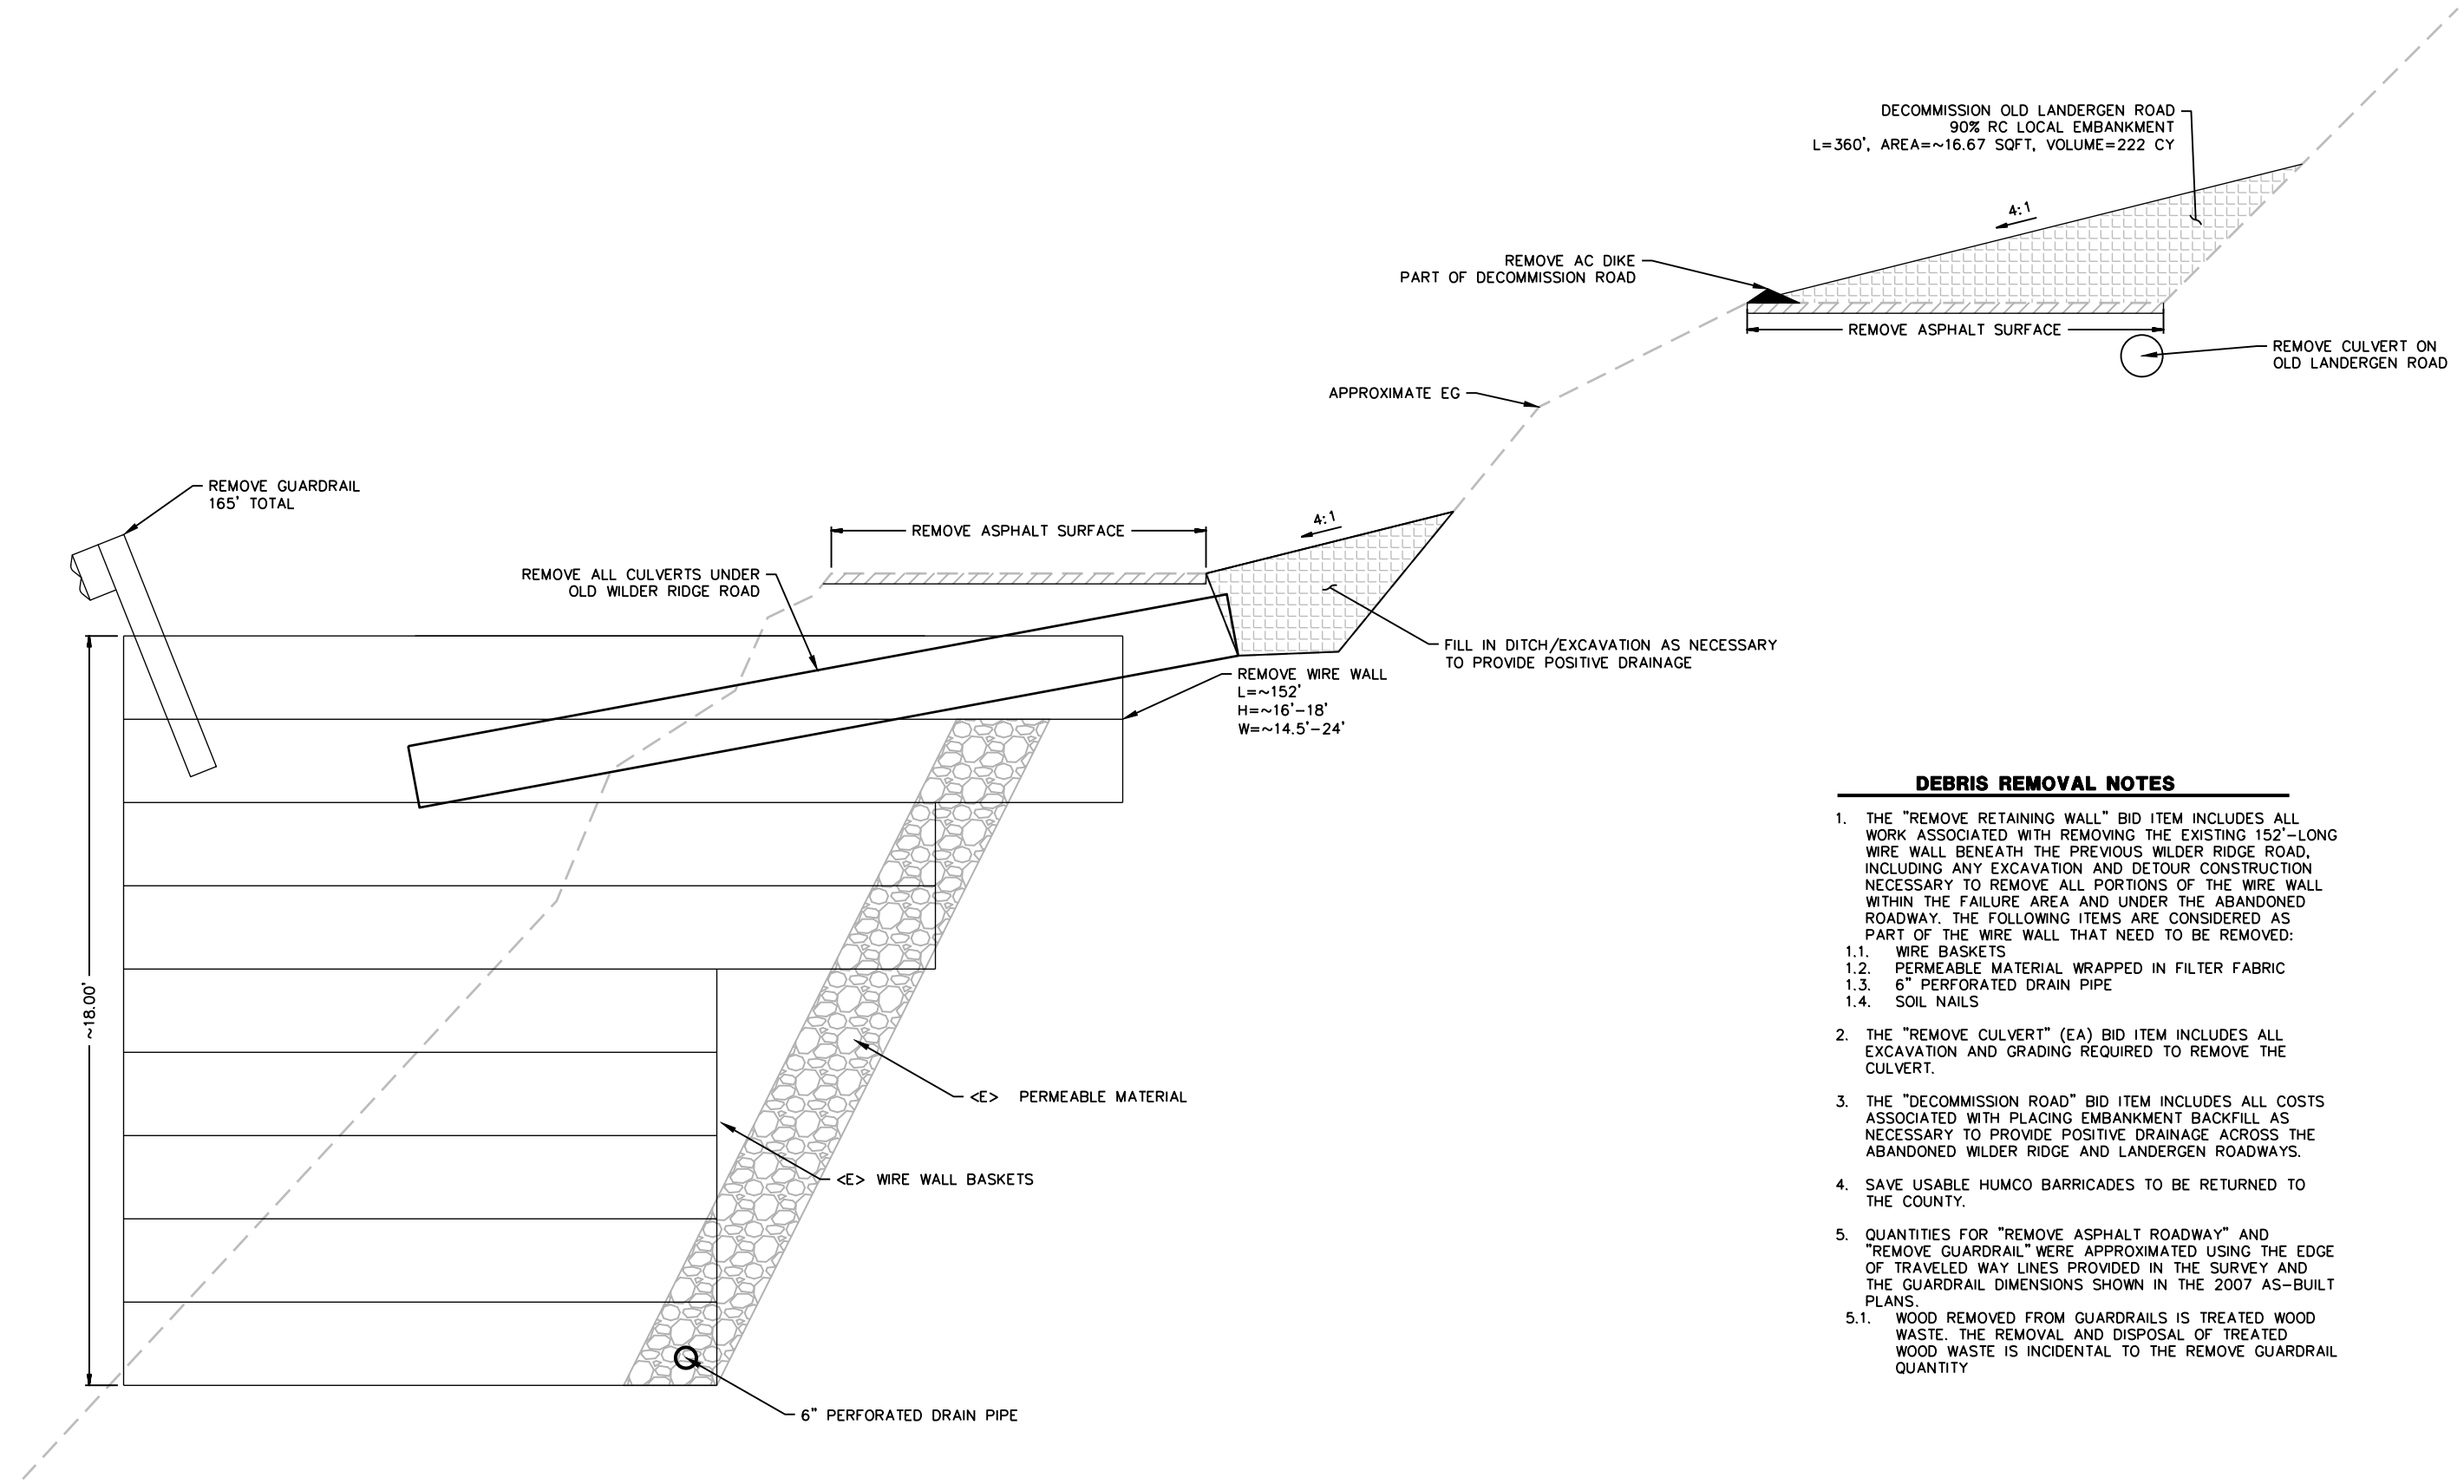

**DEBRIS REMOVAL NOTES**

1. THE "REMOVE RETAINING WALL" BID ITEM INCLUDES ALL WORK ASSOCIATED WITH REMOVING THE EXISTING 152'-LONG WIRE WALL BENEATH THE PREVIOUS WILDER RIDGE ROAD, INCLUDING ANY EXCAVATION AND DETOUR CONSTRUCTION NECESSARY TO REMOVE ALL PORTIONS OF THE WIRE WALL WITHIN THE FAILURE AREA AND UNDER THE ABANDONED ROADWAY. THE FOLLOWING ITEMS ARE CONSIDERED AS PART OF THE WIRE WALL THAT NEED TO BE REMOVED:
  - 1.1. WIRE BASKETS
  - 1.2. PERMEABLE MATERIAL WRAPPED IN FILTER FABRIC
  - 1.3. 6" PERFORATED DRAIN PIPE
  - 1.4. SOIL NAILS
2. THE "REMOVE CULVERT" (EA) BID ITEM INCLUDES ALL EXCAVATION AND GRADING REQUIRED TO REMOVE THE CULVERT.
3. THE "DECOMMISSION ROAD" BID ITEM INCLUDES ALL COSTS ASSOCIATED WITH PLACING EMBANKMENT BACKFILL AS NECESSARY TO PROVIDE POSITIVE DRAINAGE ACROSS THE ABANDONED WILDER RIDGE AND LANDERGEN ROADWAYS.
4. SAVE USABLE HUMCO BARRICADES TO BE RETURNED TO THE COUNTY.
5. QUANTITIES FOR "REMOVE ASPHALT ROADWAY" AND "REMOVE GUARDRAIL" WERE APPROXIMATED USING THE EDGE OF TRAVELED WAY LINES PROVIDED IN THE SURVEY AND THE GUARDRAIL DIMENSIONS SHOWN IN THE 2007 AS-BUILT PLANS.
  - 5.1. WOOD REMOVED FROM GUARDRAILS IS TREATED WOOD WASTE. THE REMOVAL AND DISPOSAL OF TREATED WOOD WASTE IS INCIDENTAL TO THE REMOVE GUARDRAIL QUANTITY

**DEBRIS REMOVAL TYPICAL SECTION**

SCALE: 1"=2'







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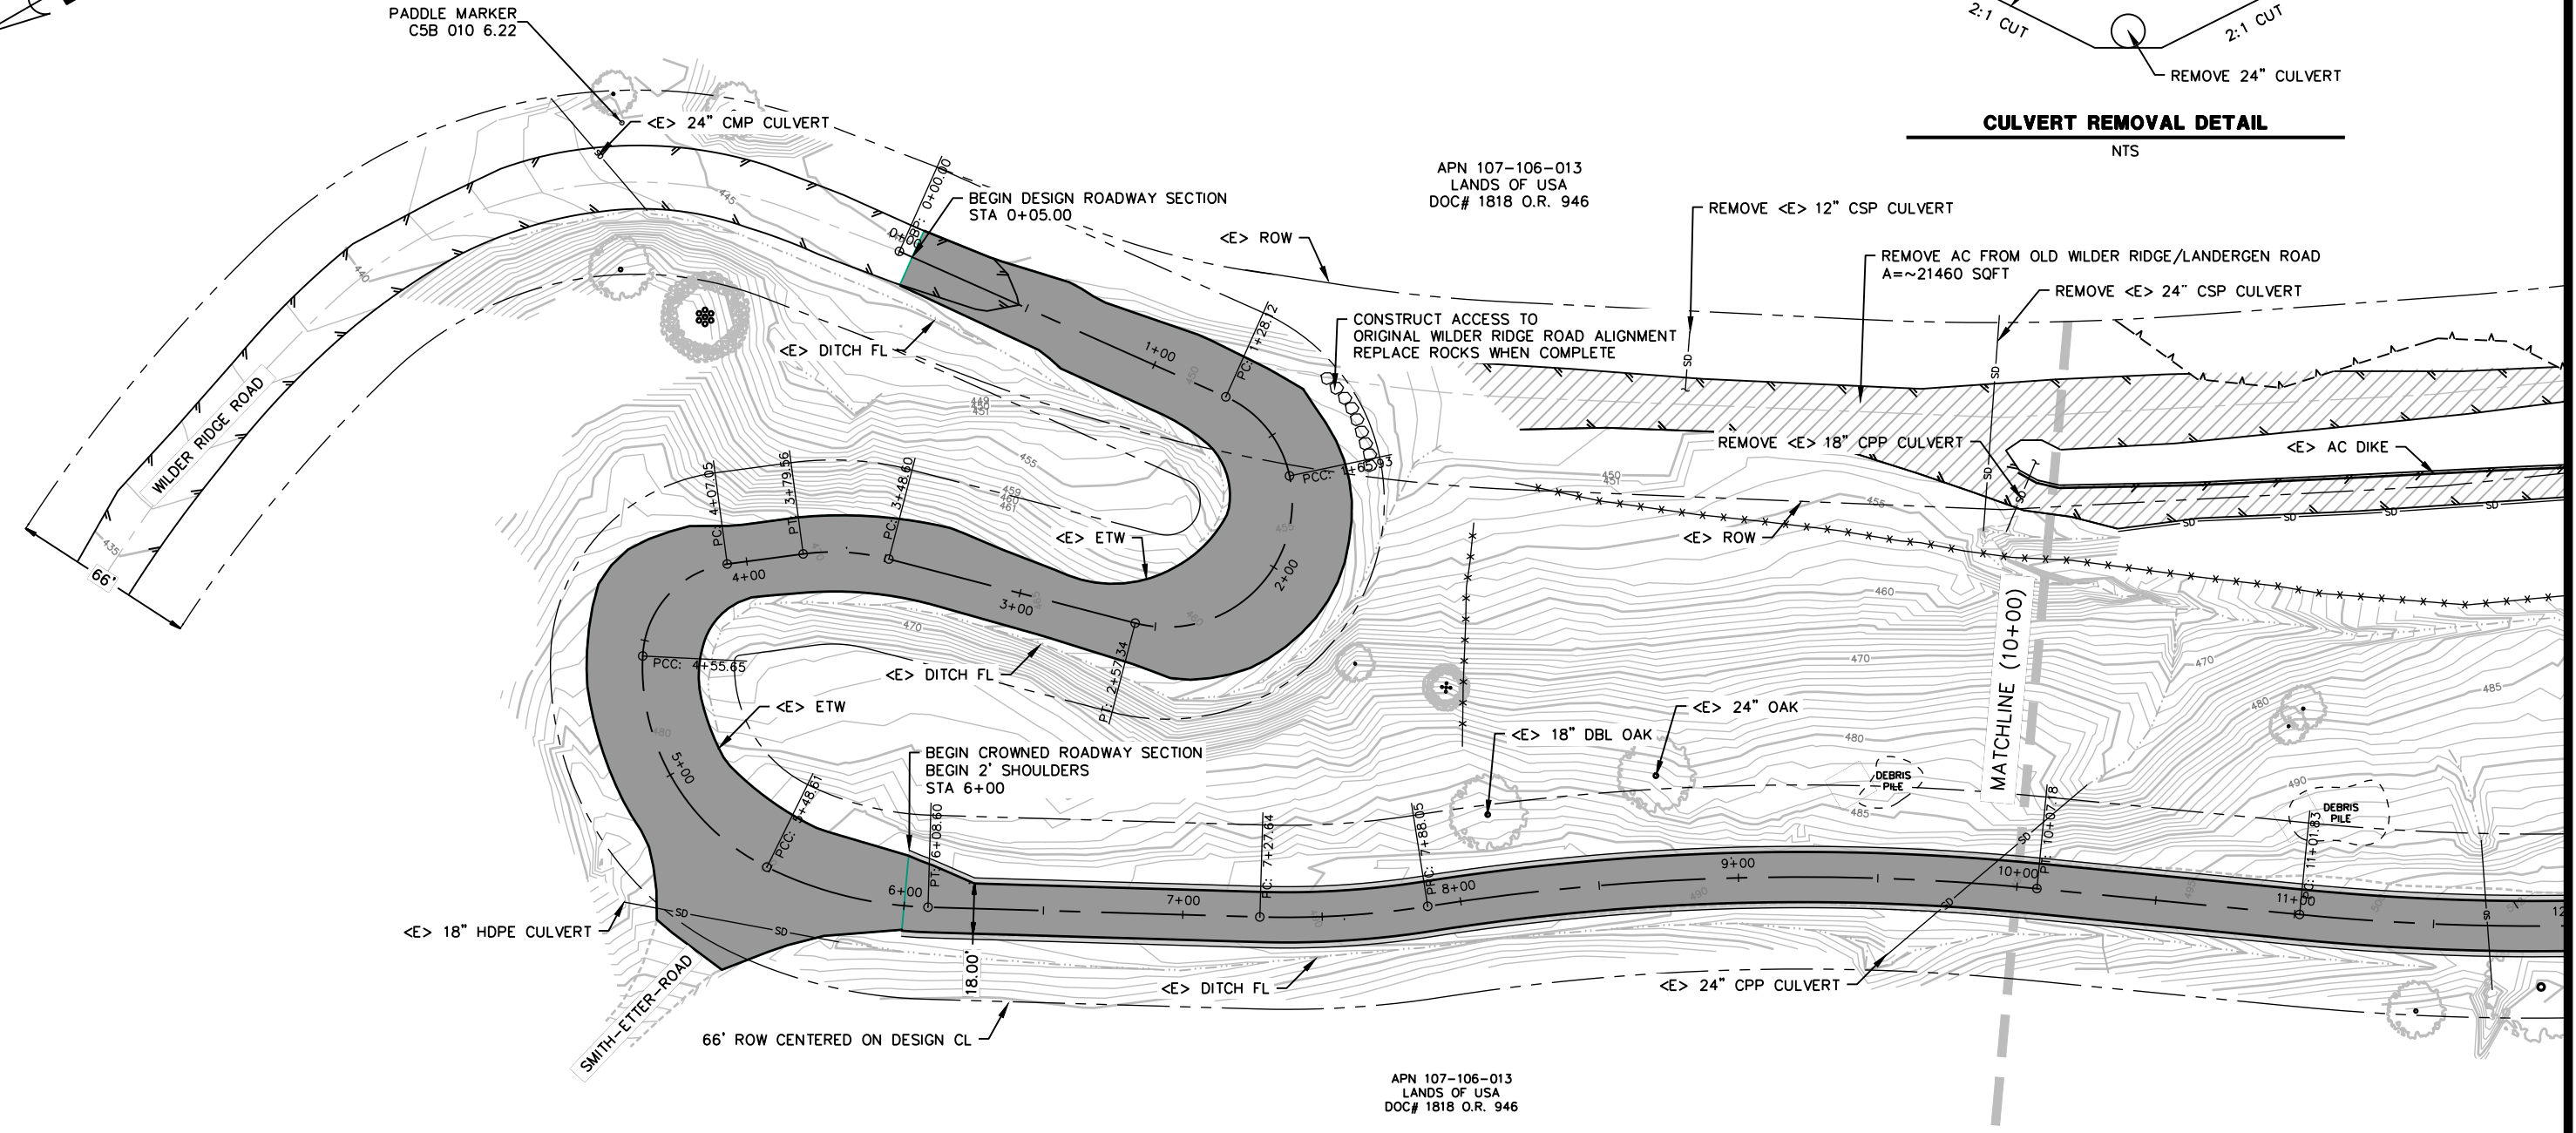
COUNTY OF HUMBOLDT DEPARTMENT OF PUBLIC WORKS <b>WILDER RIDGE ROAD PM 6.11 STORM DAMAGE REPAIR</b> PLAN VIEW - 1 OF 2
--

SHEET  
**6**  
OF  
**10**

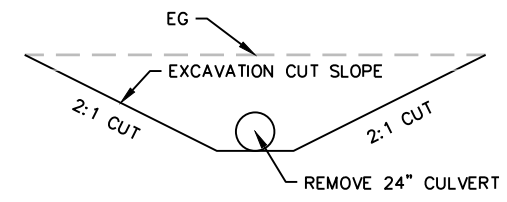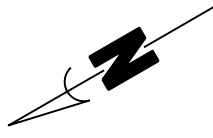

**CULVERT REMOVAL DETAIL**

NTS



**PLAN VIEW (STA 0+00 TO 10+00)**

SCALE: 1"=30'




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<b>COUNTY OF HUMBOLDT</b> <b>DEPARTMENT OF PUBLIC WORKS</b>
<b>WILDER RIDGE ROAD PM 6.11 STORM DAMAGE REPAIR</b>
<b>PLAN VIEW (2 OF 2)</b>

SHEET  
**7**  
OF  
**10**

**LEGEND**

	REMOVE AC (21,460 SQFT)
	ASPHALT PAVEMENT
	SHOULDER (SHOULDER BACKING)
	1:1 OR 0.9:1 ROADWAY EXC

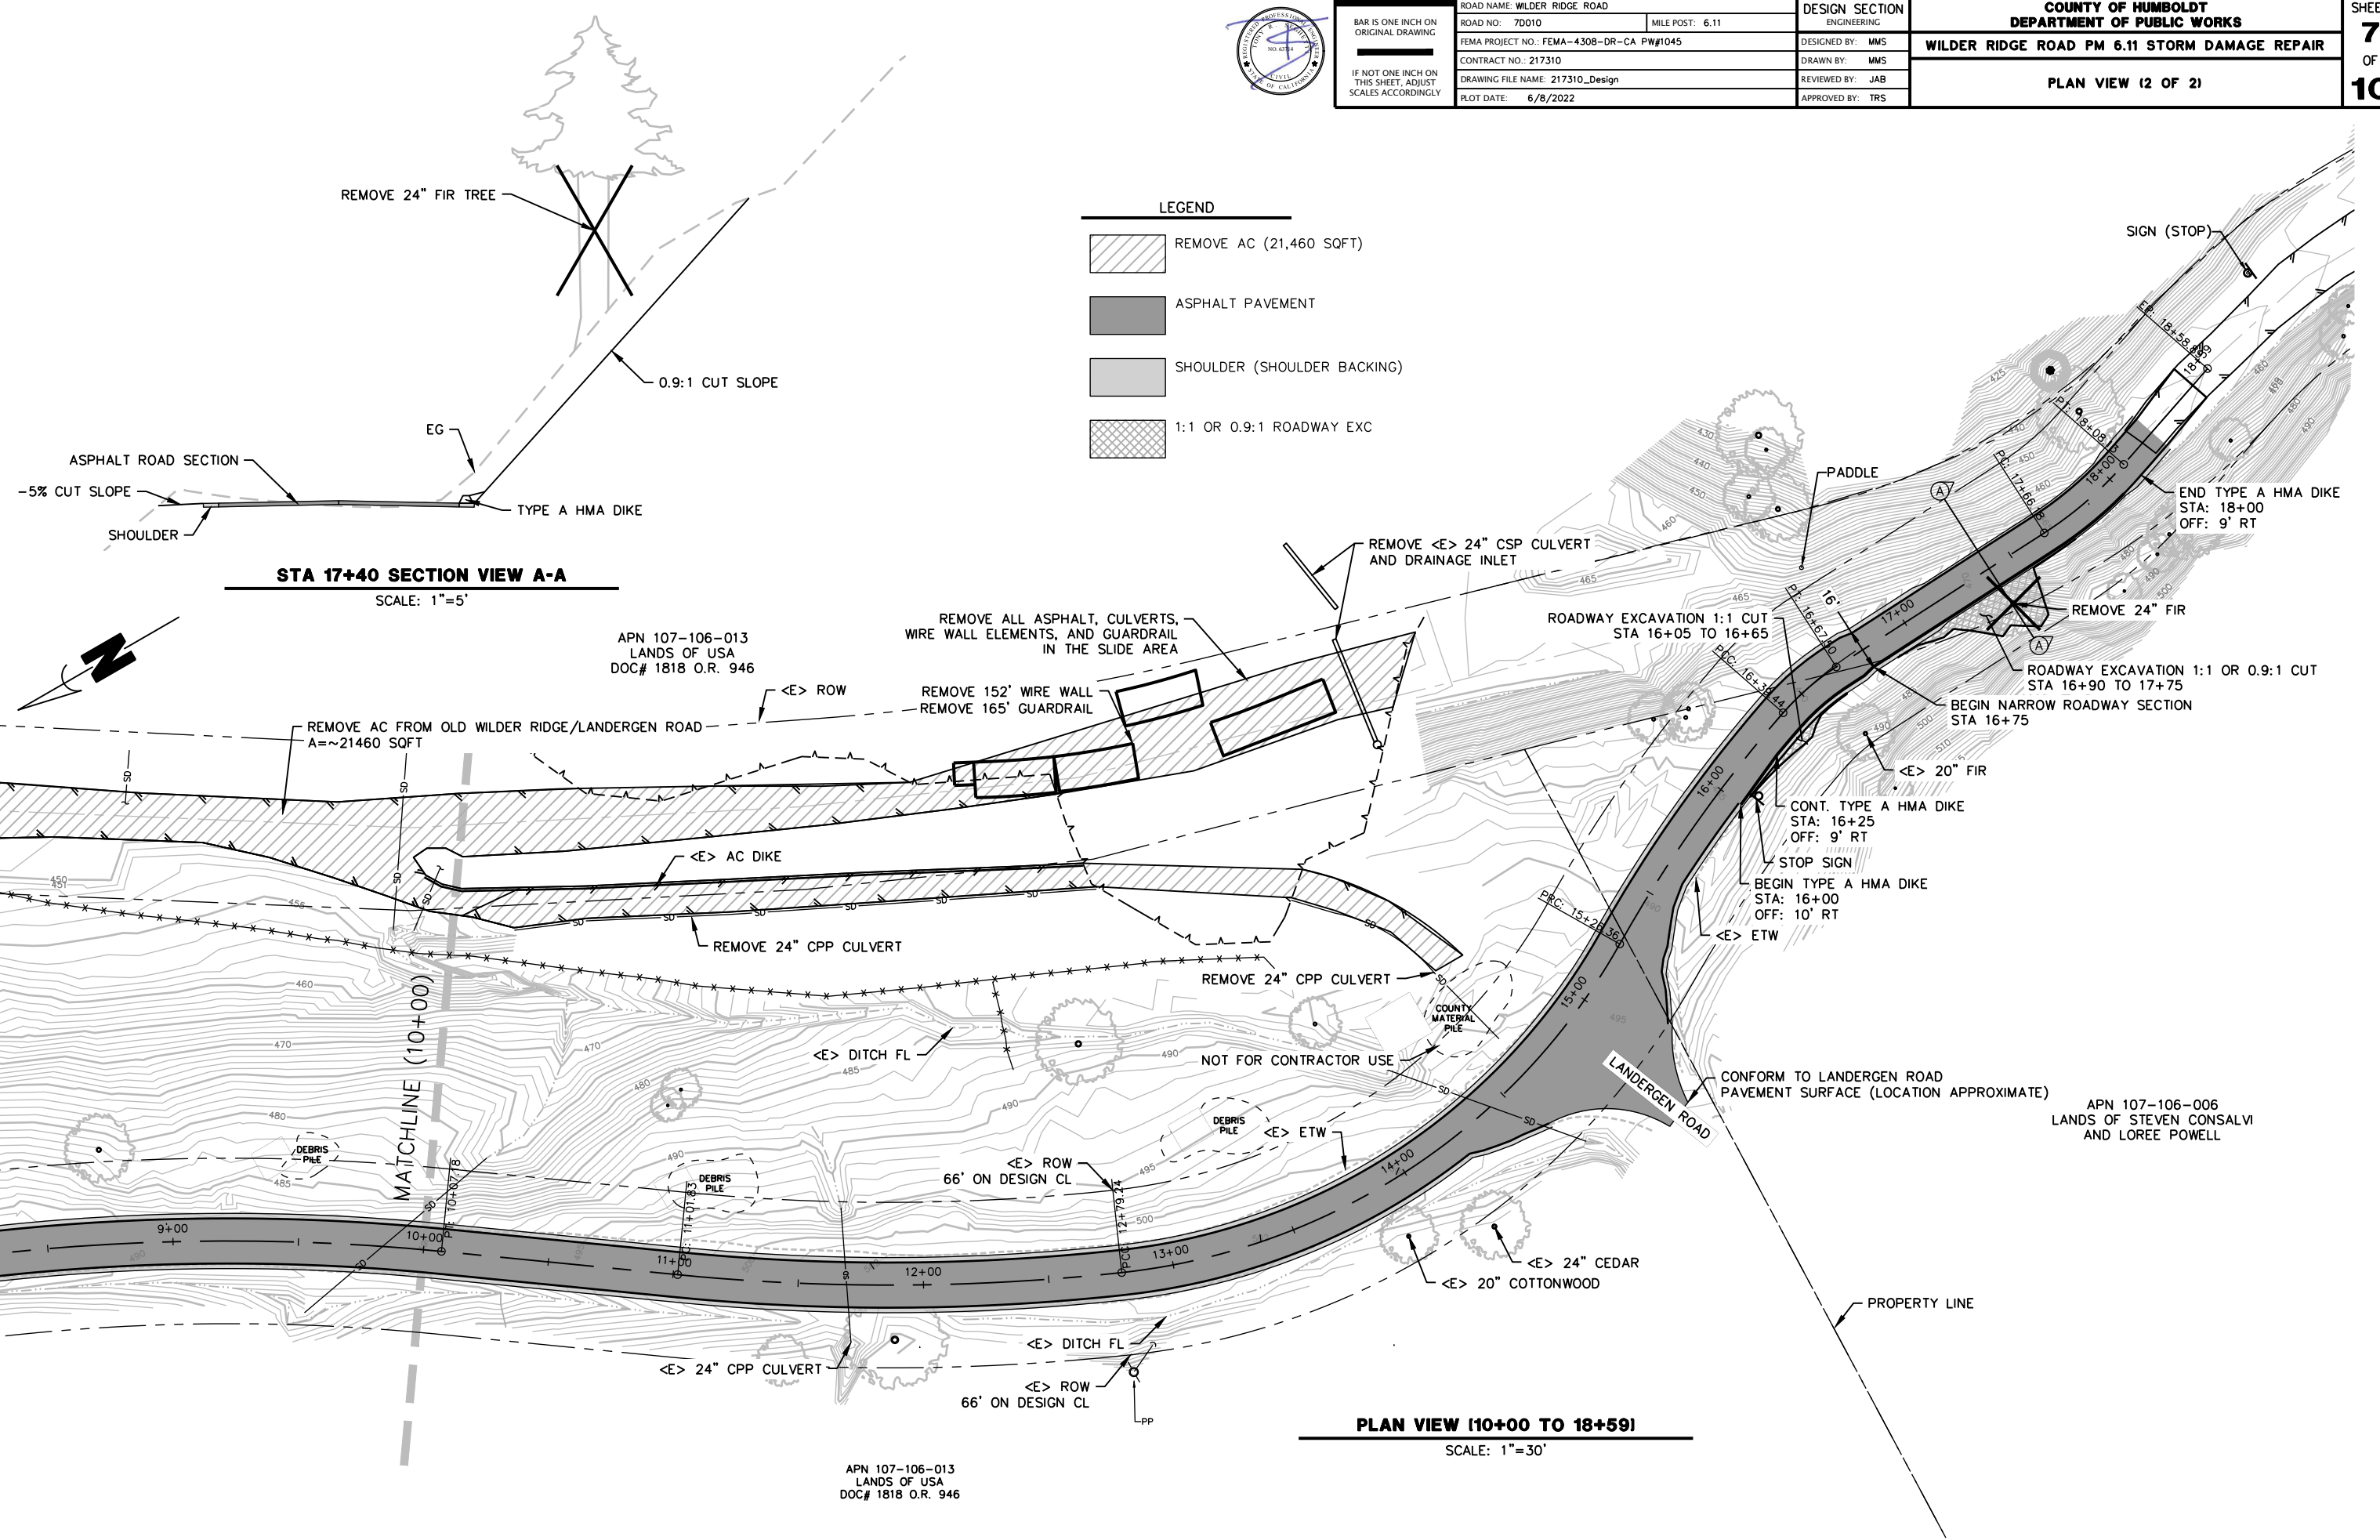

APN 107-106-013  
LANDS OF USA  
DOC# 1818 O.R. 946

APN 107-106-006  
LANDS OF STEVEN CONSALVI  
AND LOREE POWELL

APN 107-106-013  
LANDS OF USA  
DOC# 1818 O.R. 946



BAR IS ONE INCH ON ORIGINAL DRAWING  
 IF NOT ONE INCH ON THIS SHEET, ADJUST SCALES ACCORDINGLY


ROAD NAME: WILDER RIDGE ROAD  
 ROAD NO.: 7D010 MILE POST: 6.11  
 FEMA PROJECT NO.: FEMA-4308-DR-CA PW#1045  
 CONTRACT NO.: 217310  
 DRAWING FILE NAME: 217310\_Design  
 PLOT DATE: 6/8/2022

DESIGN SECTION  
 ENGINEERING  
 DESIGNED BY: MMS  
 DRAWN BY: MMS  
 REVIEWED BY: JAB  
 APPROVED BY: TRS

COUNTY OF HUMBOLDT  
 DEPARTMENT OF PUBLIC WORKS  
 WILDER RIDGE ROAD PM 6.11 STORM DAMAGE REPAIR  
 PROFILE VIEW (STA 0+00 TO 9+20)

SHEET  
**8**  
 OF  
**10**

No.	PVI Station	PVI Elevation	Grade In	Grade Out	A (Grade Change)	Profile Curve Type	Profile Curve Length	Curve Radius
1	0+00.70'	445.20'	1.95%					
2	0+46.95'	446.11'	1.95%	6.45%	4.49%	Sag	16.14'	359.36'
3	1+01.00'	449.59'	6.45%	6.32%	0.12%	Crest	24.19'	19916.94'
4	1+71.17'	454.03'	6.32%	10.54%	4.22%	Sag	78.40'	1860.02'
5	2+34.00'	460.65'	10.54%	8.44%	2.10%	Crest	26.74'	1274.20'
6	3+09.96'	467.06'	8.44%	4.80%	3.64%	Crest	45.60'	1253.55'
7	3+77.09'	470.29'	4.80%	9.06%	4.26%	Sag	61.02'	1433.97'
8	4+55.76'	477.42'	9.06%	11.76%	2.70%	Sag	46.11'	1706.34'
9	5+02.94'	482.96'	11.76%	5.80%	5.97%	Crest	33.37'	559.44'
10	5+59.74'	486.26'	5.80%	2.41%	3.38%	Crest	21.10'	623.72'
11	6+02.94'	487.30'	2.41%	0.87%	1.54%	Crest	32.09'	2082.96'
12	6+70.71'	487.89'	0.87%	3.00%	2.12%	Sag	60.04'	2828.43'
13	8+17.02'	492.27'	3.00%	-2.83%	5.83%	Crest	71.74'	1231.03'
14	9+07.77'	489.70'	-2.83%	-0.31%	2.52%	Sag	73.77'	2925.94'

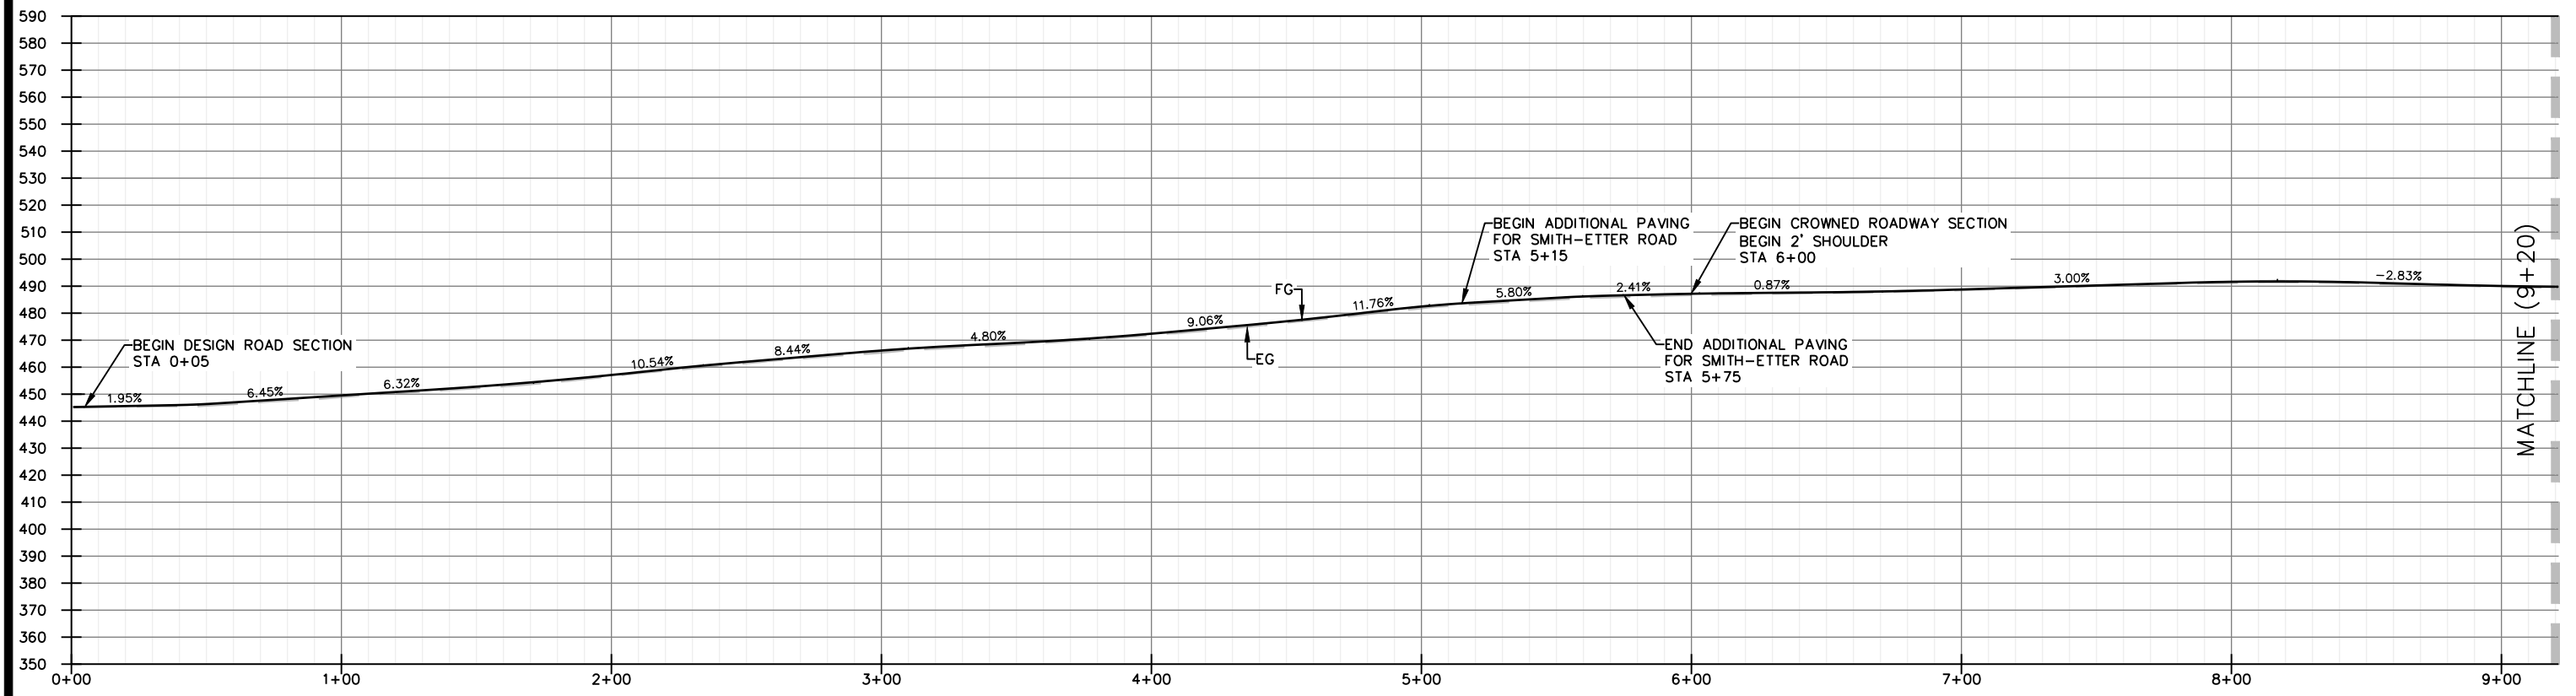

**PROFILE VIEW ISTA 0+00 TO 9+20**  
 SCALE: 1"=30'






BAR IS ONE INCH ON ORIGINAL DRAWING  IF NOT ONE INCH ON THIS SHEET, ADJUST SCALES ACCORDINGLY	ROAD NAME: WILDER RIDGE ROAD	DESIGN SECTION	<b>COUNTY OF HUMBOLDT</b> <b>DEPARTMENT OF PUBLIC WORKS</b> <b>WILDER RIDGE ROAD PM 6.11 STORM DAMAGE REPAIR</b> <b>PROFILE VIEW (STA 9+20 TO 18+59)</b>	
	ROAD NO.: 7D010	MILE POST: 6.11		ENGINEERING
	FEMA PROJECT NO.: FEMA-4308-DR-CA PW#1045			DESIGNED BY: MMS
	CONTRACT NO.: 217310			DRAWN BY: MMS
	DRAWING FILE NAME: 217310_Design	REVIEWED BY: JAB		
	PLOT DATE: 6/8/2022	APPROVED BY: TRS		

SHEET  
**9**  
OF  
**10**

No.	PVI Station	PVI Elevation	Grade In	Grade Out	A (Grade Change)	Profile Curve Type	Profile Curve Length	Curve Radius
15	9+95.61'	489.43'	-0.31%	8.71%	9.02%	Sag	63.89'	708.00'
16	10+57.72'	494.84'	8.71%	8.78%	0.06%	Sag	42.64'	68139.53'
17	11+15.02'	499.87'	8.78%	4.83%	3.94%	Crest	31.38'	795.43'
18	11+73.21'	502.69'	4.83%	-0.28%	5.11%	Crest	73.54'	1439.03'
19	12+46.63'	502.48'	-0.28%	-0.20%	0.08%	Sag	54.78'	65685.18'
20	13+50.96'	502.28'	-0.20%	-4.21%	4.02%	Crest	31.60'	786.42'
21	14+03.56'	500.06'	-4.21%	-4.13%	0.09%	Sag	45.01'	51264.26'
22	14+65.65'	497.50'	-4.13%	-7.75%	3.63%	Crest	38.08'	1050.10'
23	14+95.22'	495.21'	-7.75%	-9.79%	2.04%	Crest	12.04'	590.52'
24	16+72.08'	477.89'	-9.79%	-12.96%	3.17%	Crest	89.73'	2828.07'
25	17+78.73'	464.06'	-12.96%	-11.90%	1.07%			
26	18+06.63'	460.74'	-11.90%	-6.68%	5.22%			
27	18+18.84'	459.93'	-6.68%	-2.52%	4.15%	Sag	12.45'	299.77'
28	18+50.00'	459.14'	-2.52%					

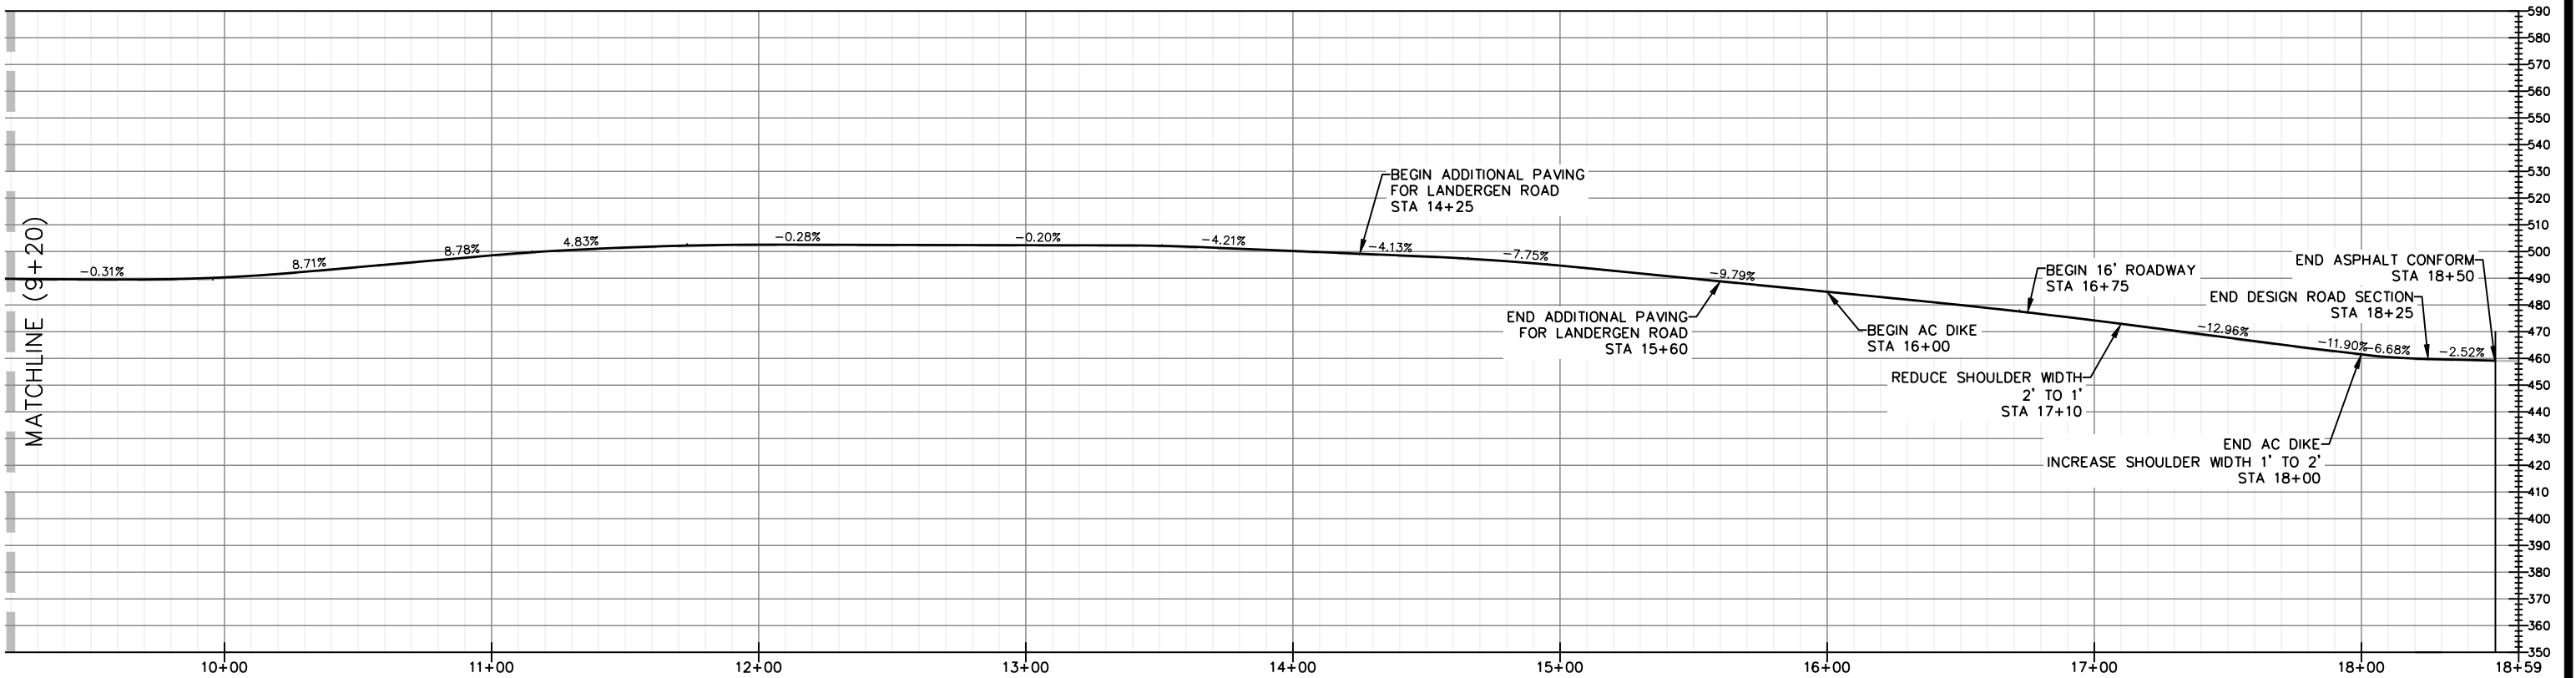

**PROFILE VIEW (STA 9+20 TO 18+59)**

Scale: 1" = 30'



BAR IS ONE INCH ON ORIGINAL DRAWING	ROAD NAME: WILDER RIDGE ROAD	DESIGN SECTION
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COUNTY OF HUMBOLDT DEPARTMENT OF PUBLIC WORKS WILDER RIDGE ROAD PM 6.11 STORM DAMAGE REPAIR EROSION CONTROL PLAN	SHEET <b>10</b> OF <b>10</b>
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LEGEND

	SEED AND STRAW
	SEED AND ROLLED EROSION CONTROL PRODUCT
	FR FIBER ROLL

