

# CITY OF FERNDALE WATER QUALITY AND DRAINAGE IMPROVEMENT PROJECT SEWER OVERFLOW AND STORMWATER REUSE MUNICIPAL GRANT


AGREEMENT NO. D2219002

65% DESIGN

SEPTEMBER 2024


PROJECT NUMBER: 12638533

## AREA MAP

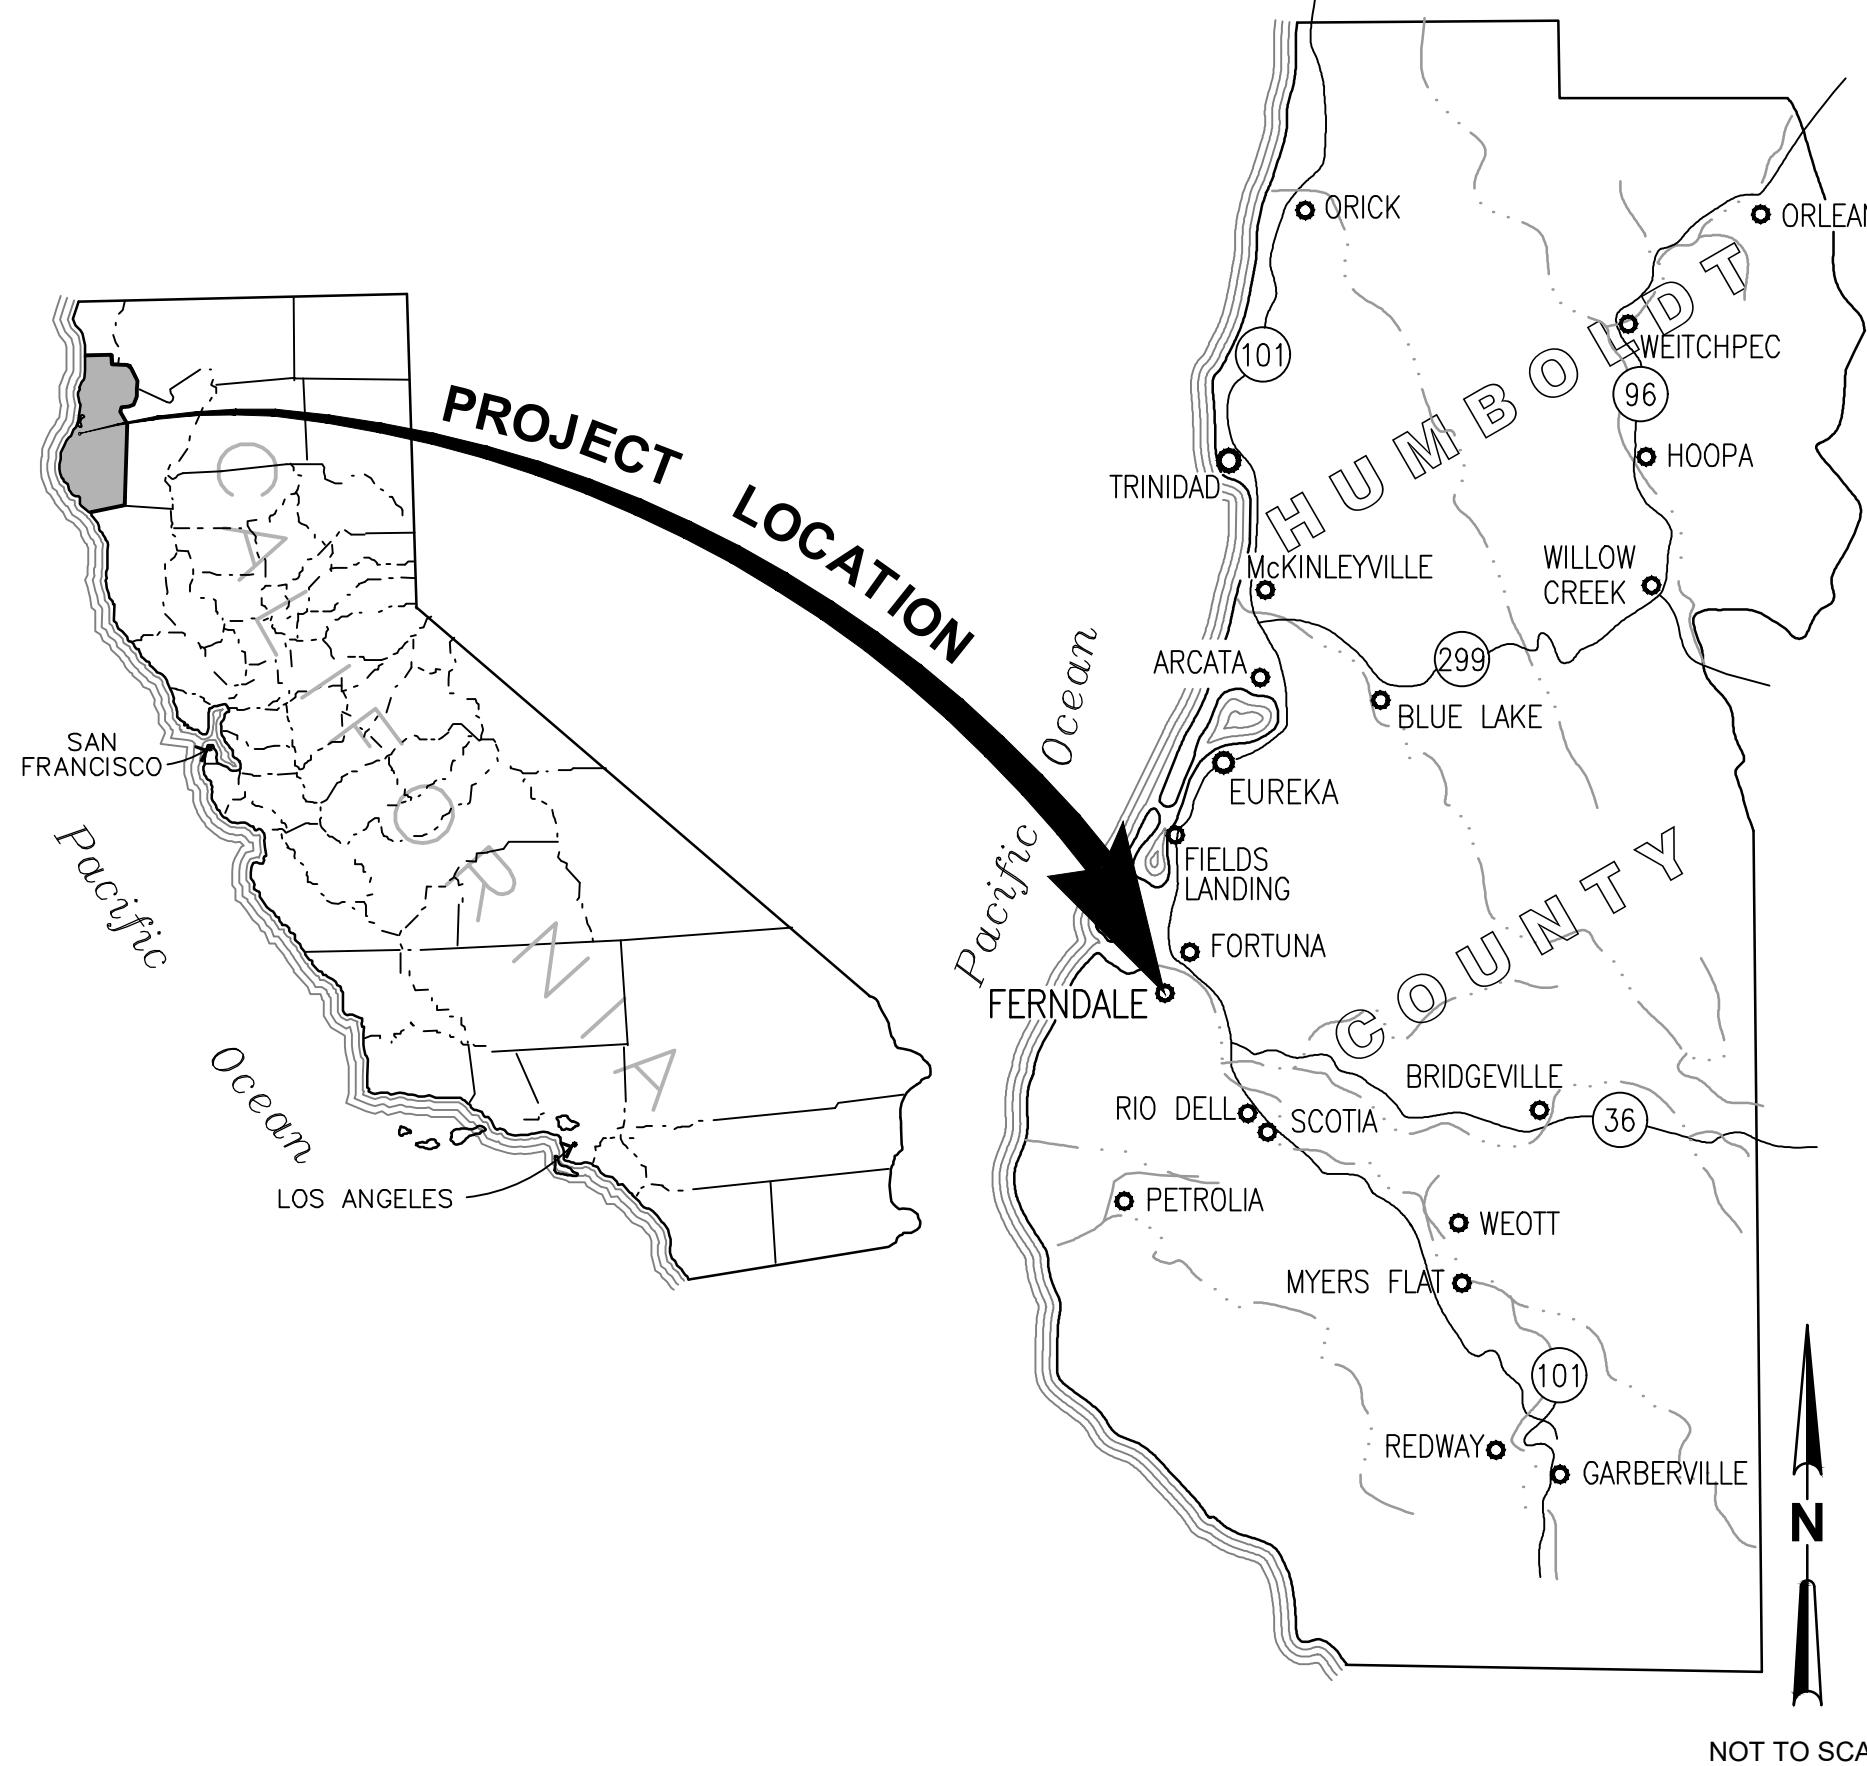

## LOCATION MAP

### PROJECT LOCATION

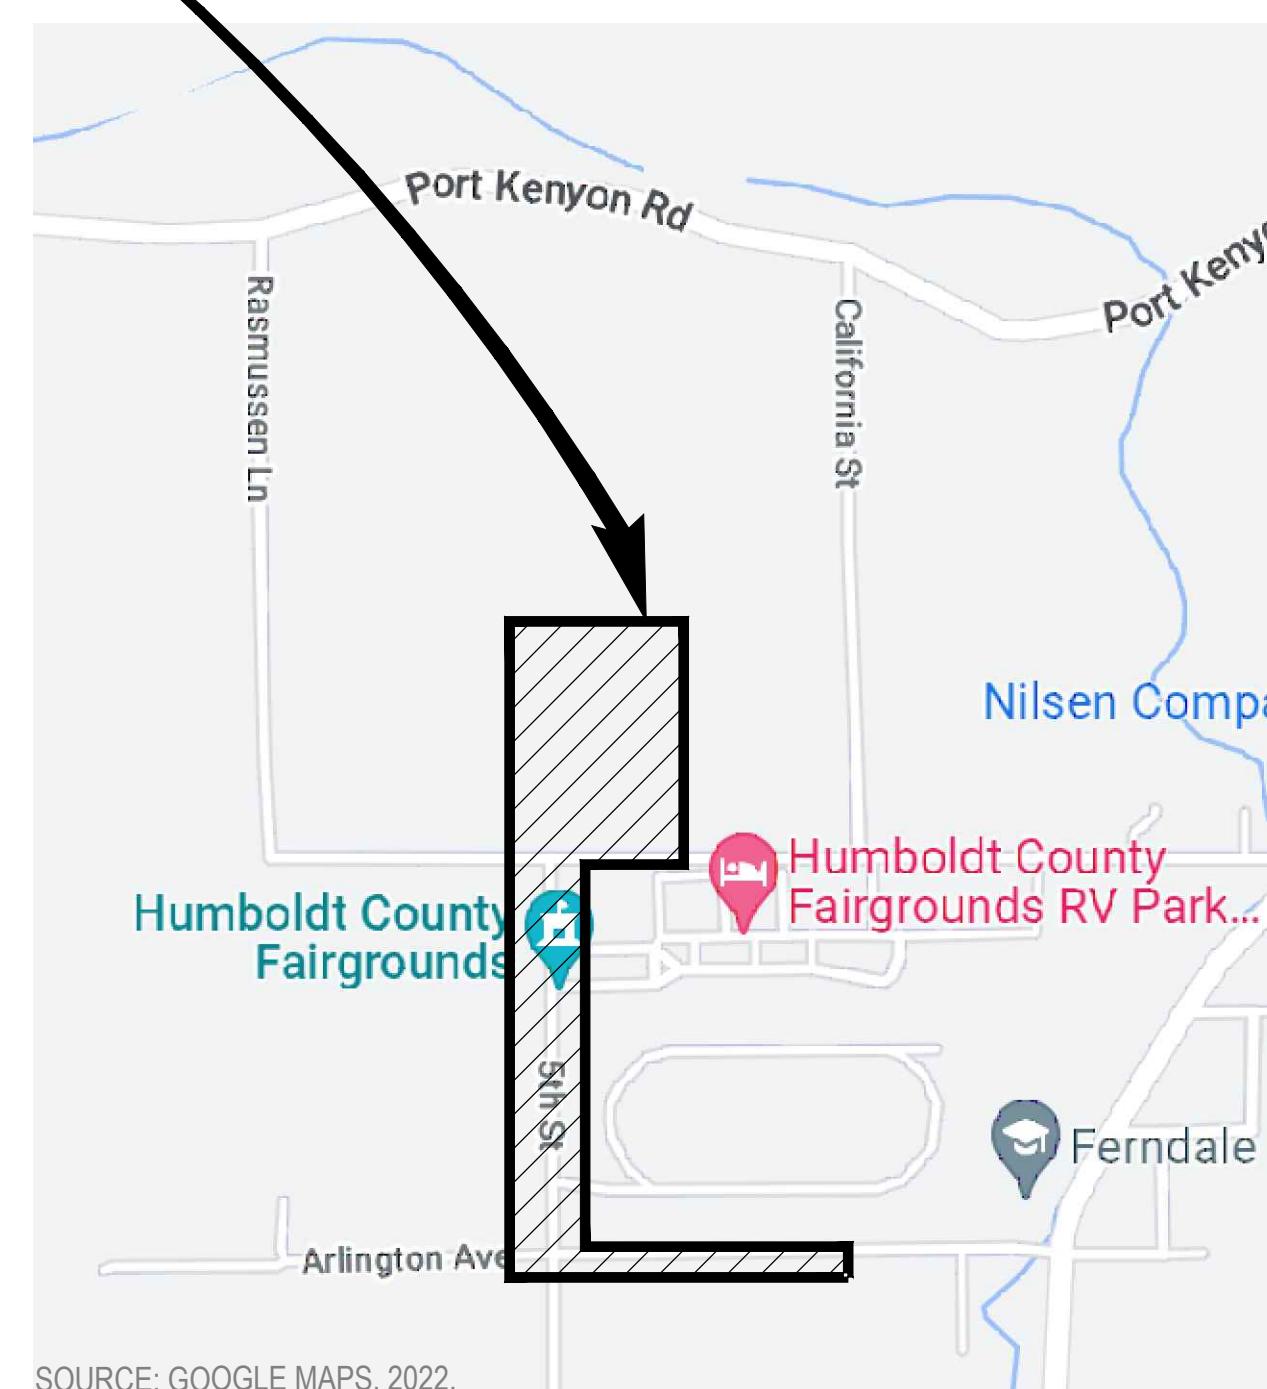

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CITY OF FERNDALE

Project WATER QUALITY AND DRAINAGE  
IMPROVEMENTS PROJECT

Project No.  
12561178

Date  
2024-09-12

Scale  
AS SHOWN




Title COVER SHEET

Size

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Sheet No  
G-001

Sheet  
1 of 13

GENERAL NOTES		UTILITY NOTES	ABBREVIATIONS	LEGEND
1. PROJECT REQUIRES A CLASS A GENERAL ENGINEERING CONTRACTOR'S LICENSE IN THE STATE OF CALIFORNIA.		1. LOCATIONS OF EXISTING UNDERGROUND UTILITIES ARE PLOTTED FROM RECORD DRAWINGS, LOCATION MARK-UP, AND INTERPOLATION OF PHYSICAL EVIDENCE ON THE SITE AND ARE SUBJECT TO FIELD VERIFICATION BY THE CONTRACTOR.	CITY CITY OF FERNDALE	 EXISTING
2. CONTRACTOR SHALL FIELD VERIFY ALL EXISTING SITE CONDITIONS PRIOR TO THE COMMENCEMENT OF WORK AND REPORT ANY DISCREPANCIES TO THE CITY'S PROJECT MANAGER. CONTRACTOR IS RESPONSIBLE FOR VISITING THE SITE AND BECOMING FAMILIAR WITH THE SITE CONDITIONS PRIOR TO BIDDING. SHOULD EXISTING CONDITIONS DIFFER FROM THOSE SHOWN OR INDICATED, OR IF IT APPEARS THAT THESE PLANS, AND SPECIFICATIONS DO NOT ADEQUATELY DETAIL THE WORK TO BE DONE, CONTRACTOR SHALL NOTIFY THE CITY'S PROJECT MANAGER PRIOR TO CONTINUING WITH ANY RELATED WORK. NO ALLOWANCE WILL BE MADE ON CONTRACTOR'S BEHALF FOR ANY EXTRA EXPENSE RESULTING FROM FAILURE OR NEGLECT IN DETERMINING THE CONDITIONS UNDER WHICH WORK IS TO BE PERFORMED. NOTED DIMENSIONS TAKE PRECEDENCE OVER SCALE.		2. ALL LOCATIONS FOR WORK SHALL BE CHECKED AND COORDINATED WITH EXISTING CONDITIONS IN THE FIELD BEFORE BEGINNING CONSTRUCTION UNDER THIS SECTION OR ANY OTHER SECTION.	DIA, Ø DIAMETER	 PROPOSED
3. CONTRACTOR IS RESPONSIBLE FOR CONFIRMING THAT NEW FEATURES TIE INTO EXISTING SITE DEVELOPMENT, PAVEMENT JOINTS MATCH CORRECTLY, AND THAT GENERAL DESIGN ELEVATIONS FOR NEW CONSTRUCTION PROVIDE PROPER PAVEMENT AND DRAINAGE SLOPES FROM EXISTING TIE IN POINTS. REPORT DISCREPANCIES TO CITY'S PROJECT MANAGER PRIOR TO CONSTRUCTION.		3. THE WORKING DRAWINGS ARE GENERALLY DIAGRAMMATIC. THEY DO NOT SHOW EVERY OFFSET, BEND OR ELBOW REQUIRED FOR INSTALLATION IN THE SPACE PROVIDED. THEY DO NOT SHOW EVERY DIMENSION, COMPONENT PIECE, OR FITTING REQUIRED TO COMPLETE THE PROJECT. CONTRACTOR IS RESPONSIBLE FOR PROVIDING A COMPLETE AND WORKING SYSTEM.	EL, ELEV ELEVATION	 OVERHEAD ELECTRICAL
4. QUANTITIES OF ITEMS, LENGTH OF PROJECT, AND SITE CONDITIONS SHOWN IN THE PLANS ARE APPROXIMATE. ALL MATERIALS SHALL BE FURNISHED AND INSTALLED BY THE CONTRACTOR UNLESS OTHERWISE NOTED.		4. CONTRACTOR SHALL COORDINATE A UTILITY LOCATE AT LEAST TWO WORKING DAYS PRIOR TO BEGINNING ANY UTILITY CONSTRUCTION FOR LOCATION MARK-UP OF ALL EXISTING UTILITIES. CONTRACTOR SHALL COORDINATE THE UTILITY LOCATE WITH CITY FOR ALL UTILITY WORK. INFORM CITY'S PROJECT MANAGER IMMEDIATELY IF LOCATE INDICATES THAT EXISTING UTILITIES ARE DIFFERENT THAN SHOWN ON DRAWINGS.	EG EXISTING GROUND	 STORM DRAIN PIPE
5. CONTRACTOR AGREES TO ASSUME SOLE AND COMPLETE RESPONSIBILITY FOR THE JOB SITE DURING THE COURSE OF CONSTRUCTION OF THIS PROJECT, INCLUDING SAFETY OF ALL PERSONS AND PROPERTY; THAT THIS REQUIREMENT SHALL APPLY CONTINUOUSLY AND NOT BE LIMITED TO NORMAL WORKING HOURS.		5. CONTRACTOR IS RESPONSIBLE FOR ANY DAMAGE TO UTILITIES, FEATURES, AND STRUCTURES LOCATED ON THE SITE. LOCATE, PROTECT, AND AVOID DISRUPTION OF ALL ABOVE AND BELOW GRADE UTILITIES DURING CONSTRUCTION. CONTRACTOR SHALL REPAIR ANY DAMAGE TO EQUAL OR BETTER THAN THE EXISTING CONDITION AT CONTRACTOR'S SOLE EXPENSE.	EX EXISTING	 STORM DRAIN INLET
6. CONTRACTOR SHALL BE HELD RESPONSIBLE FOR ANY AND ALL DAMAGES TO EXISTING STRUCTURES, ROADS, AND UTILITIES DURING CONSTRUCTION. ALL DAMAGE SHALL BE RESTORED TO EQUAL OR BETTER CONDITION AT THE CONTRACTOR'S EXPENSE.		6. ALL UTILITY CONSTRUCTION SHALL CONFORM TO CITY STANDARDS, AND CURRENT CALIFORNIA CODES.	FG FINISHED GRADE	 STORM DRAIN MANHOLE
7. A SET OF SIGNED WORKING DRAWINGS AND A SET OF SPECIFICATIONS WILL BE KEPT AT ALL TIMES AT THE JOB SITE ON WHICH ALL CHANGES OR VARIATIONS IN THE WORK, INCLUDING ALL EXISTING UTILITIES, ARE TO BE RECORDED AND/OR CORRECTED DAILY AND SUBMITTED TO THE CITY'S PROJECT MANAGER WHEN THE WORK TO BE DONE IS COMPLETED.		7. ALL BURIED LINES TO HAVE 12 INCHES MINIMUM COVER, UNLESS NOTED OTHERWISE.	FL FLOW LINE	 SANITARY SEWER PIPE
8. CONTRACTOR SHALL PROVIDE AND MAINTAIN SUFFICIENT TEMPORARY BARRIERS TO PROVIDE FOR THE SAFETY OF THE STAFF AND PUBLIC TO THE SATISFACTION OF THE CITY'S PROJECT MANAGER.		8. ALL EXISTING UTILITIES AND TIE-IN POINTS SHOULD BE CONSIDERED ACTIVE UTILITIES UNLESS OTHERWISE INDICATED.	FT FOOT OR FEET	 SANITARY SEWER MANHOLE
9. CONTRACTOR SHALL NOTIFY THE CITY'S PROJECT MANAGER AT LEAST 72 HOURS IN ADVANCE OF COMMENCEMENT OF ANY PART OF THE WORK AND SHALL COORDINATE CONSTRUCTION SCHEDULE ACCORDINGLY.		9. CONFIRM ALL UTILITY APPURTENANCES WITH CITY.	G GAS	 WATER MAIN
10. UNSUITABLE EXCAVATED MATERIAL SHALL BE REMOVED FROM SITE AND DISPOSED OF IN A MANNER CONSISTENT WITH APPLICABLE REGULATIONS. THE CONTRACTOR SHALL ASSUME FULL RESPONSIBILITY AND EXPENSE FOR PROPER DISPOSAL OF UNSUITABLE MATERIALS TAKEN FROM SITE.		10. CONTRACTOR SHALL COORDINATE ALL UTILITY SHUTDOWNS WITH THE CITY PROJECT MANAGER, A MINIMUM OF TWO WEEKS IN ADVANCE.	HMA HOT MIX ASPHALT	 WATER VALVE
11. THE DESIGN FEATURES INCLUDING HORIZONTAL AND VERTICAL ALIGNMENTS, TYPICAL SECTIONS, APPROACHES, AND OTHER DESIGN DETAILS SHOWN ON THESE DESIGN PLANS SHALL NOT BE ALTERED OR MODIFIED IN ANY WAY DURING CONSTRUCTION WITHOUT THE EXPRESSED, WRITTEN DIRECTION AND APPROVAL OF THE CITY'S PROJECT MANAGER. DRAINAGE STRUCTURES SHALL BE INSTALLED AS SHOWN ON THE PLANS WITH ONLY MINOR CORRECTIONS IN LOCATION, SKEW AND/OR ELEVATIONS AS NEEDED TO FIT FIELD CONDITIONS AS DETERMINED BY THE CITY'S PROJECT MANAGER.			JT JOINT TRENCH	 FIRE HYDRANT
12. THE CONTRACTOR SHALL READ AND MAKE CAREFUL EXAMINATION OF THE PLANS, SPECIFICATIONS, QUANTITIES AND MATERIAL ESTIMATES AND VISIT THE SITE OF THE PROPOSED CONSTRUCTION TO BECOME FAMILIAR WITH THE SITE CONDITIONS AND LIMITATIONS BEFORE MAKING A BID. THE CONTRACTOR SHALL BE RESPONSIBLE FOR ANY AND ALL ERRORS RESULTING FROM THE FAILURE TO MAKE SUCH AN EXAMINATION. ANY INFORMATION DERIVED FROM THE MAPS, PLANS, SPECIFICATIONS, PROFILES, DRAWINGS OR FROM THE ENGINEER WILL NOT RELIEVE THE CONTRACTOR FROM ANY RISK OR FROM FULFILLING THE TERMS OF THE CONTRACT.			LF LINEAR FEET	 FENCE
13. NO WORK SHALL BE PERFORMED OUTSIDE OF THE DESIGNATED LIMITS OF WORK WITHOUT THE APPROVAL OF THE CITY'S PROJECT MANAGER.			MAX MAXIMUM	 ELECTRICAL POLE
14. THE CONTRACTOR IS RESPONSIBLE FOR COORDINATING STAGING AREAS WITH THE CITY'S PROJECT MANAGER.			MIN MINIMUM	 PROPERTY LINE
15. UPON COMPLETION OF THE CONSTRUCTION PROJECT, THE CONTRACTOR SHALL LEAVE THE PROJECT AREA FREE OF DEBRIS AND UNUSED MATERIAL. ALL DAMAGE CAUSED BY THE CONTRACTOR SHALL BE RESTORED TO AN "AS GOOD OR BETTER" CONDITION.			(N) NEW	 EDGE OF PAVEMENT
16. THE CONTRACTOR SHALL BE REQUIRED TO SAWCUT OR GRIND THE EXISTING ASPHALT PAVEMENT WHERE OLD ASPHALT IS TO TIE INTO THE NEW ASPHALT PAVEMENT. THE CONTRACTOR SHALL BE REQUIRED TO TAPER THE NEW ASPHALT CONCRETE SURFACING TO MATCH THE EXISTING PAVEMENT SECTION AT TIE-IN POINTS AND TO PROVIDE FOR A SMOOTH TRANSITION AS DIRECTED BY THE CITY'S PROJECT MANAGER.			OHE OVERHEAD ELECTRICAL	 STORM WATER DITCH
17. UNLESS OTHERWISE NOTED, THE CONTRACTOR SHALL PROTECT EXISTING SURVEY MONUMENTS WITHIN WORK LIMITS. ANY MONUMENT DAMAGED BY THE CONTRACTOR SHALL BE RESET IN ACCORDANCE WITH THE CALIFORNIA PROFESSIONAL LAND SURVEYORS ACT.			SD STORM DRAIN	 MINOR CONTOUR
18. WHENEVER ANY MATERIAL OR EQUIPMENT IS INDICATED OR SPECIFIED BY PATENT OR PROPRIETARY NAME OR BY THE NAME OF THE MANUFACTURER, SUCH SPECIFICATION SHALL BE CONSIDERED AS USED FOR DESCRIBING THE MATERIAL OR EQUIPMENT DESIRED AND SHALL BE CONSIDERED AS USED FOR DESCRIBING THE MATERIAL OR EQUIPMENT DESIRED AND SHALL BE CONSIDERED AS FOLLOWED BY THE WORDS "OR APPROVED EQUAL". THE CONTRACTOR MAY OFFER ANY MATERIAL OR EQUIPMENT WHICH SHALL BE EQUAL IN EVERY RESPECT TO THAT SPECIFIED, PROVIDED THAT WRITTEN APPROVAL FIRST IS OBTAINED FROM THE CITY'S PROJECT MANAGER.			SS SANITARY SEWER	 MAJOR CONTOUR
			STA. STATION	 LIMITS OF DISTURBANCE
			TYP TYPICAL	 LIMITS OF GRADING
			W WATER	
		<b>WATER POLLUTION CONTROL NOTES</b>		
		1. AT A MINIMUM, THE CONTRACTOR SHALL EMPLOY THE FOLLOWING BEST MANAGEMENT PRACTICES (BMPs) AS DESCRIBED IN THE CURRENT CALIFORNIA STORMWATER BMP HANDBOOK FOR CONSTRUCTION (WWW.CASQA.ORG):		
		EC-1 SCHEDULING		
		SE-1 SILT FENCE		
		SE-5 FIBER ROLLS		
		SE-7 STREET SWEEPING AND VACUUMING		
		SE-10 STORM DRAIN INLET PROTECTION		
		WE-1 WIND EROSION CONTROL		
		NS-3 PAVING AND GRINDING OPERATIONS		
		NS-9 VEHICLE EQUIPMENT AND FUELING		
		NS-10 VEHICLE & EQUIPMENT MAINTENANCE		
		WM-1 MATERIALS DELIVERY AND STORAGE		
		WM-2 MATERIAL USE		
		WM-3 STOCKPILE MANAGEMENT		
		WM-4 SPILL PREVENTION AND CONTROL		
		WM-5 SOLID WASTE MANAGEMENT		
		WM-8 CONCRETE WASTE MANAGEMENT		
		WM-9 SANITARY/SEPTIC WASTE MANAGEMENT		
		2. IT IS THE RESPONSIBILITY OF THE CONTRACTOR TO MINIMIZE EROSION AND PREVENT THE TRANSPORT OF SEDIMENT TO SENSITIVE AREAS.		
		3. SUFFICIENT EROSION CONTROL SUPPLIES SHALL BE AVAILABLE ON-SITE AT ALL TIMES TO DEAL WITH AREAS SUSCEPTIBLE TO EROSION DURING RAIN EVENTS.		
		4. MINIMIZE DISTURBANCE OF EXISTING VEGETATION TO THAT NECESSARY TO COMPLETE THE WORK.		
		5. THE CONTRACTOR SHALL MAKE ADEQUATE PREPARATIONS, INCLUDING TRAINING & EQUIPMENT, TO CONTAIN SPILLS OF OIL AND OTHER HAZARDOUS MATERIALS.		
		6. ACTIVITIES SUCH AS VEHICLE WASHING ARE TO BE CARRIED OUT AT AN OFF-SITE FACILITY WHEREIN THE WATER IS DISCHARGED INTO A SANITARY SEWER.		
		7. THE CONTRACTOR SHALL PROVIDE COVERED WASTE RECEPTEACLE FOR COMMON SOLID WASTES AT CONVENIENT LOCATIONS ON THE JOB SITE AND PROVIDE REGULAR COLLECTION OF WASTES.		
		8. THE CONTRACTOR SHALL PROVIDE SANITARY FACILITIES OF SUFFICIENT NUMBER AND SIZE TO ACCOMMODATE CONSTRUCTION CREWS AND ENSURE ADEQUATE ANCHORAGE OF SUCH FACILITIES TO PREVENT THEM FROM BEING TIPPED BY THE WEATHER OR VANDALISM.		
		9. APPROPRIATE STORAGE AND DISPOSAL OF WATER FROM DEWATERING OPERATIONS SHALL BE EXERCISED IN THE EVENT THAT ACCUMULATED WATER MUST BE REMOVED FROM A WORK LOCATION.		
		10. COVERED AND SECURED STORAGE AREAS FOR POTENTIALLY TOXIC MATERIALS SHALL BE PROVIDED. ALL HAZARDOUS MATERIAL CONTAINERS SHOULD BE PLACED IN SECONDARY CONTAINMENT.		
		11. VEHICLE AND EQUIPMENT & MAINTENANCE SHOULD BE PERFORMED OFF-SITE WHENEVER PRACTICAL.		
		12. SOIL STOCKPILES SHALL BE COVERED, AND LOCATED AT LEAST 50 FEET AWAY FROM DRAINAGE CHANNELS AND STORMWATER SYSTEMS.		
		13. CONTRACTOR MUST ENSURE THAT THE CONSTRUCTION SITE IS PREPARED PRIOR TO THE ONSET OF ANY STORM.		
		14. ALL SEDIMENT DEPOSITED ON PAVED SURFACES SHALL BE SWEEP AT THE END OF EACH WORKING DAY, AS NECESSARY OR AS DIRECTED BY THE OWNER'S REPRESENTATIVE. A STABILIZED CONSTRUCTION ENTRANCE MAY BE REQUIRED TO PREVENT SEDIMENT FROM BEING DEPOSITED ON PAVED ROADWAYS.		
		15. ALL EROSION AND SEDIMENT CONTROL MEASURES SHALL BE MAINTAINED IN ACCORDANCE TO THEIR RESPECTIVE BMP FACT SHEET UNTIL DISTURBED AREAS ARE STABILIZED.		
		16. THIS PLAN MAY NOT COVER ALL THE SITUATIONS THAT ARISE DURING CONSTRUCTION DUE TO UNANTICIPATED FIELD CONDITIONS. VARIATIONS MAY BE MADE TO THE PLAN IN THE FIELD SUBJECT TO THE APPROVAL OF OR AT THE DIRECTION OF THE OWNERS REPRESENTATIVE.		
		17. IT WILL BE THE RESPONSIBILITY OF THE CONTRACTOR TO FIX ANY DEFICIENCIES INDICATED BY THE CITY'S PROJECT MANAGER TO PREVENT EROSION AND CONTROL SEDIMENT.		

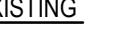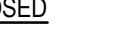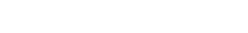

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Client CITY OF FERNDALE



Project **WATER QUALITY AND DRAINAGE  
IMPROVEMENTS PROJECT**


## Title **NOTES AND ABBREVIATIONS**

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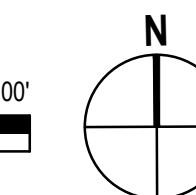
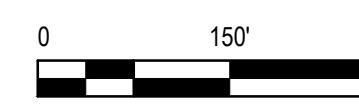
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### PROJECT OVERVIEW

SCALE: 1" = 150'



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Designer	TAYLOR ALLEN	Design Check	BRETT VIVIAN	Project Director

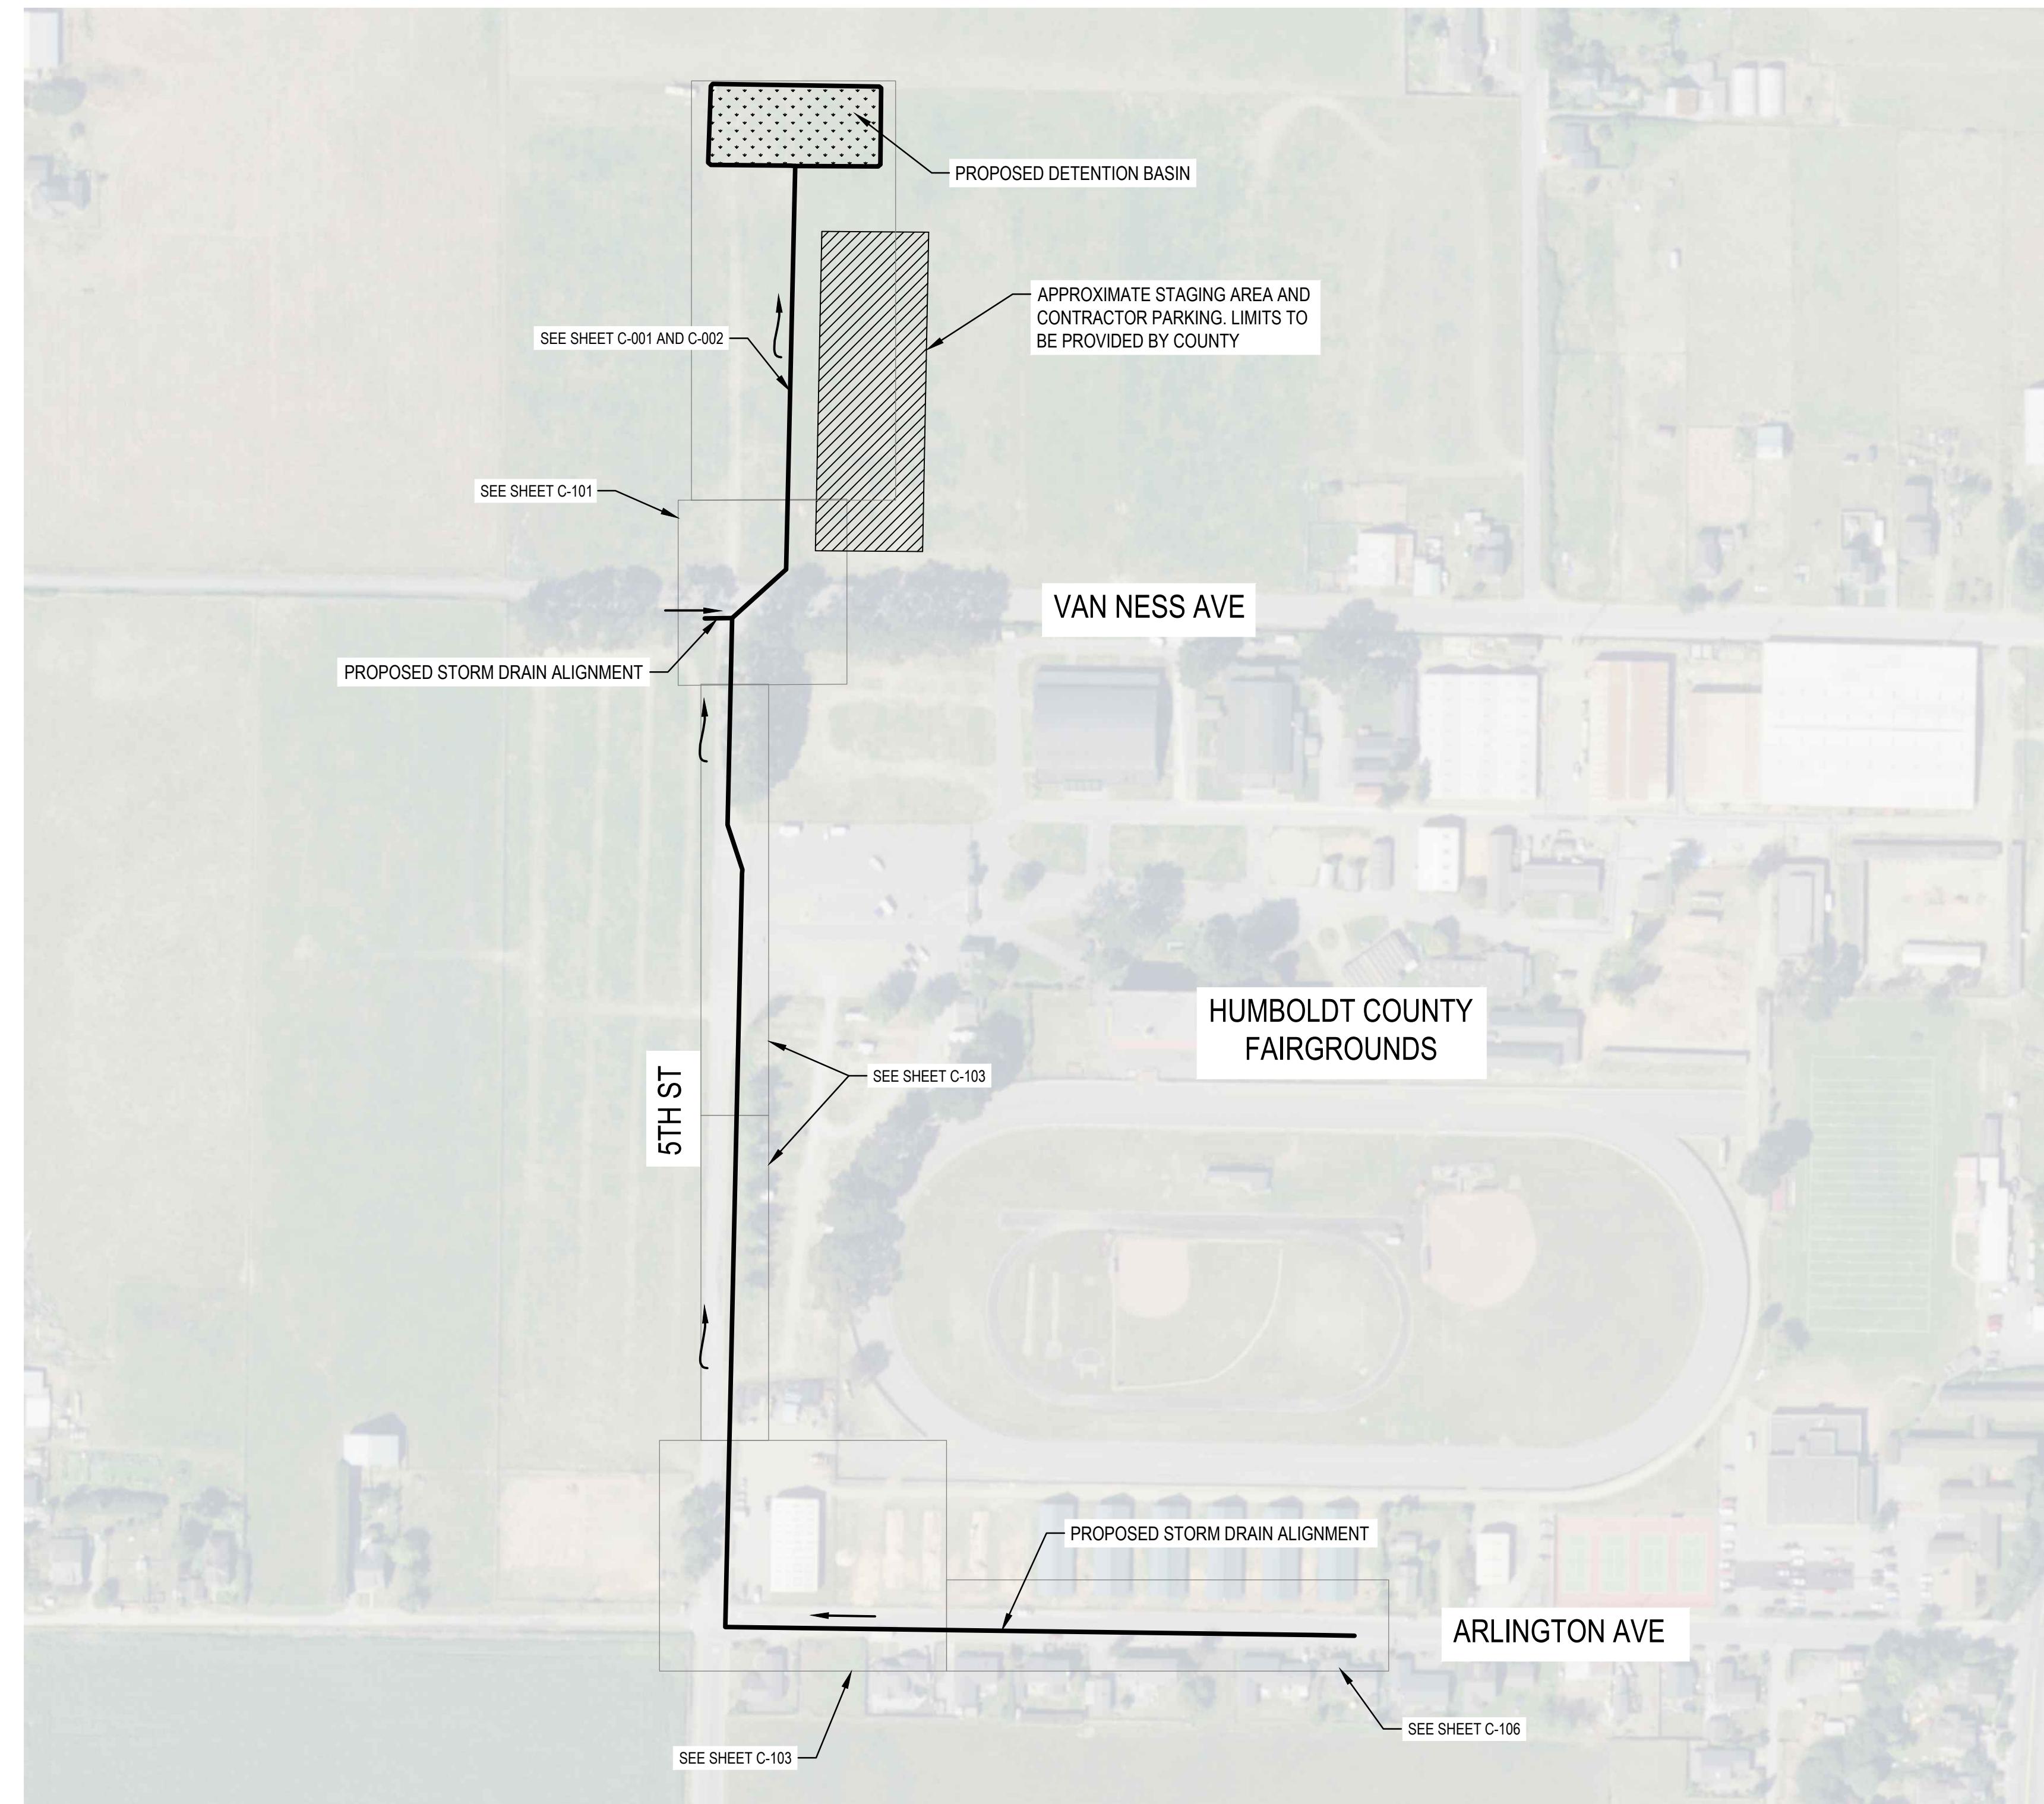

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CITY OF FERNDALE

Project WATER QUALITY AND DRAINAGE  
IMPROVEMENTS PROJECT

Project No. 12561178 Date 2024-09-12 Scale AS SHOWN


Title PROJECT OVERVIEW

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Sheet No. G-003  
Sheet 3 of 13

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Project **WATER QUALITY AND DRAINAGE  
IMPROVEMENTS PROJECT**  
Project No. **12561178** Date **2024-09-12** Scale **AS SHOWN**


Title **EXISTING CONDITIONS AND  
DEMOLITION PLAN**

Size  
**ANSI D**

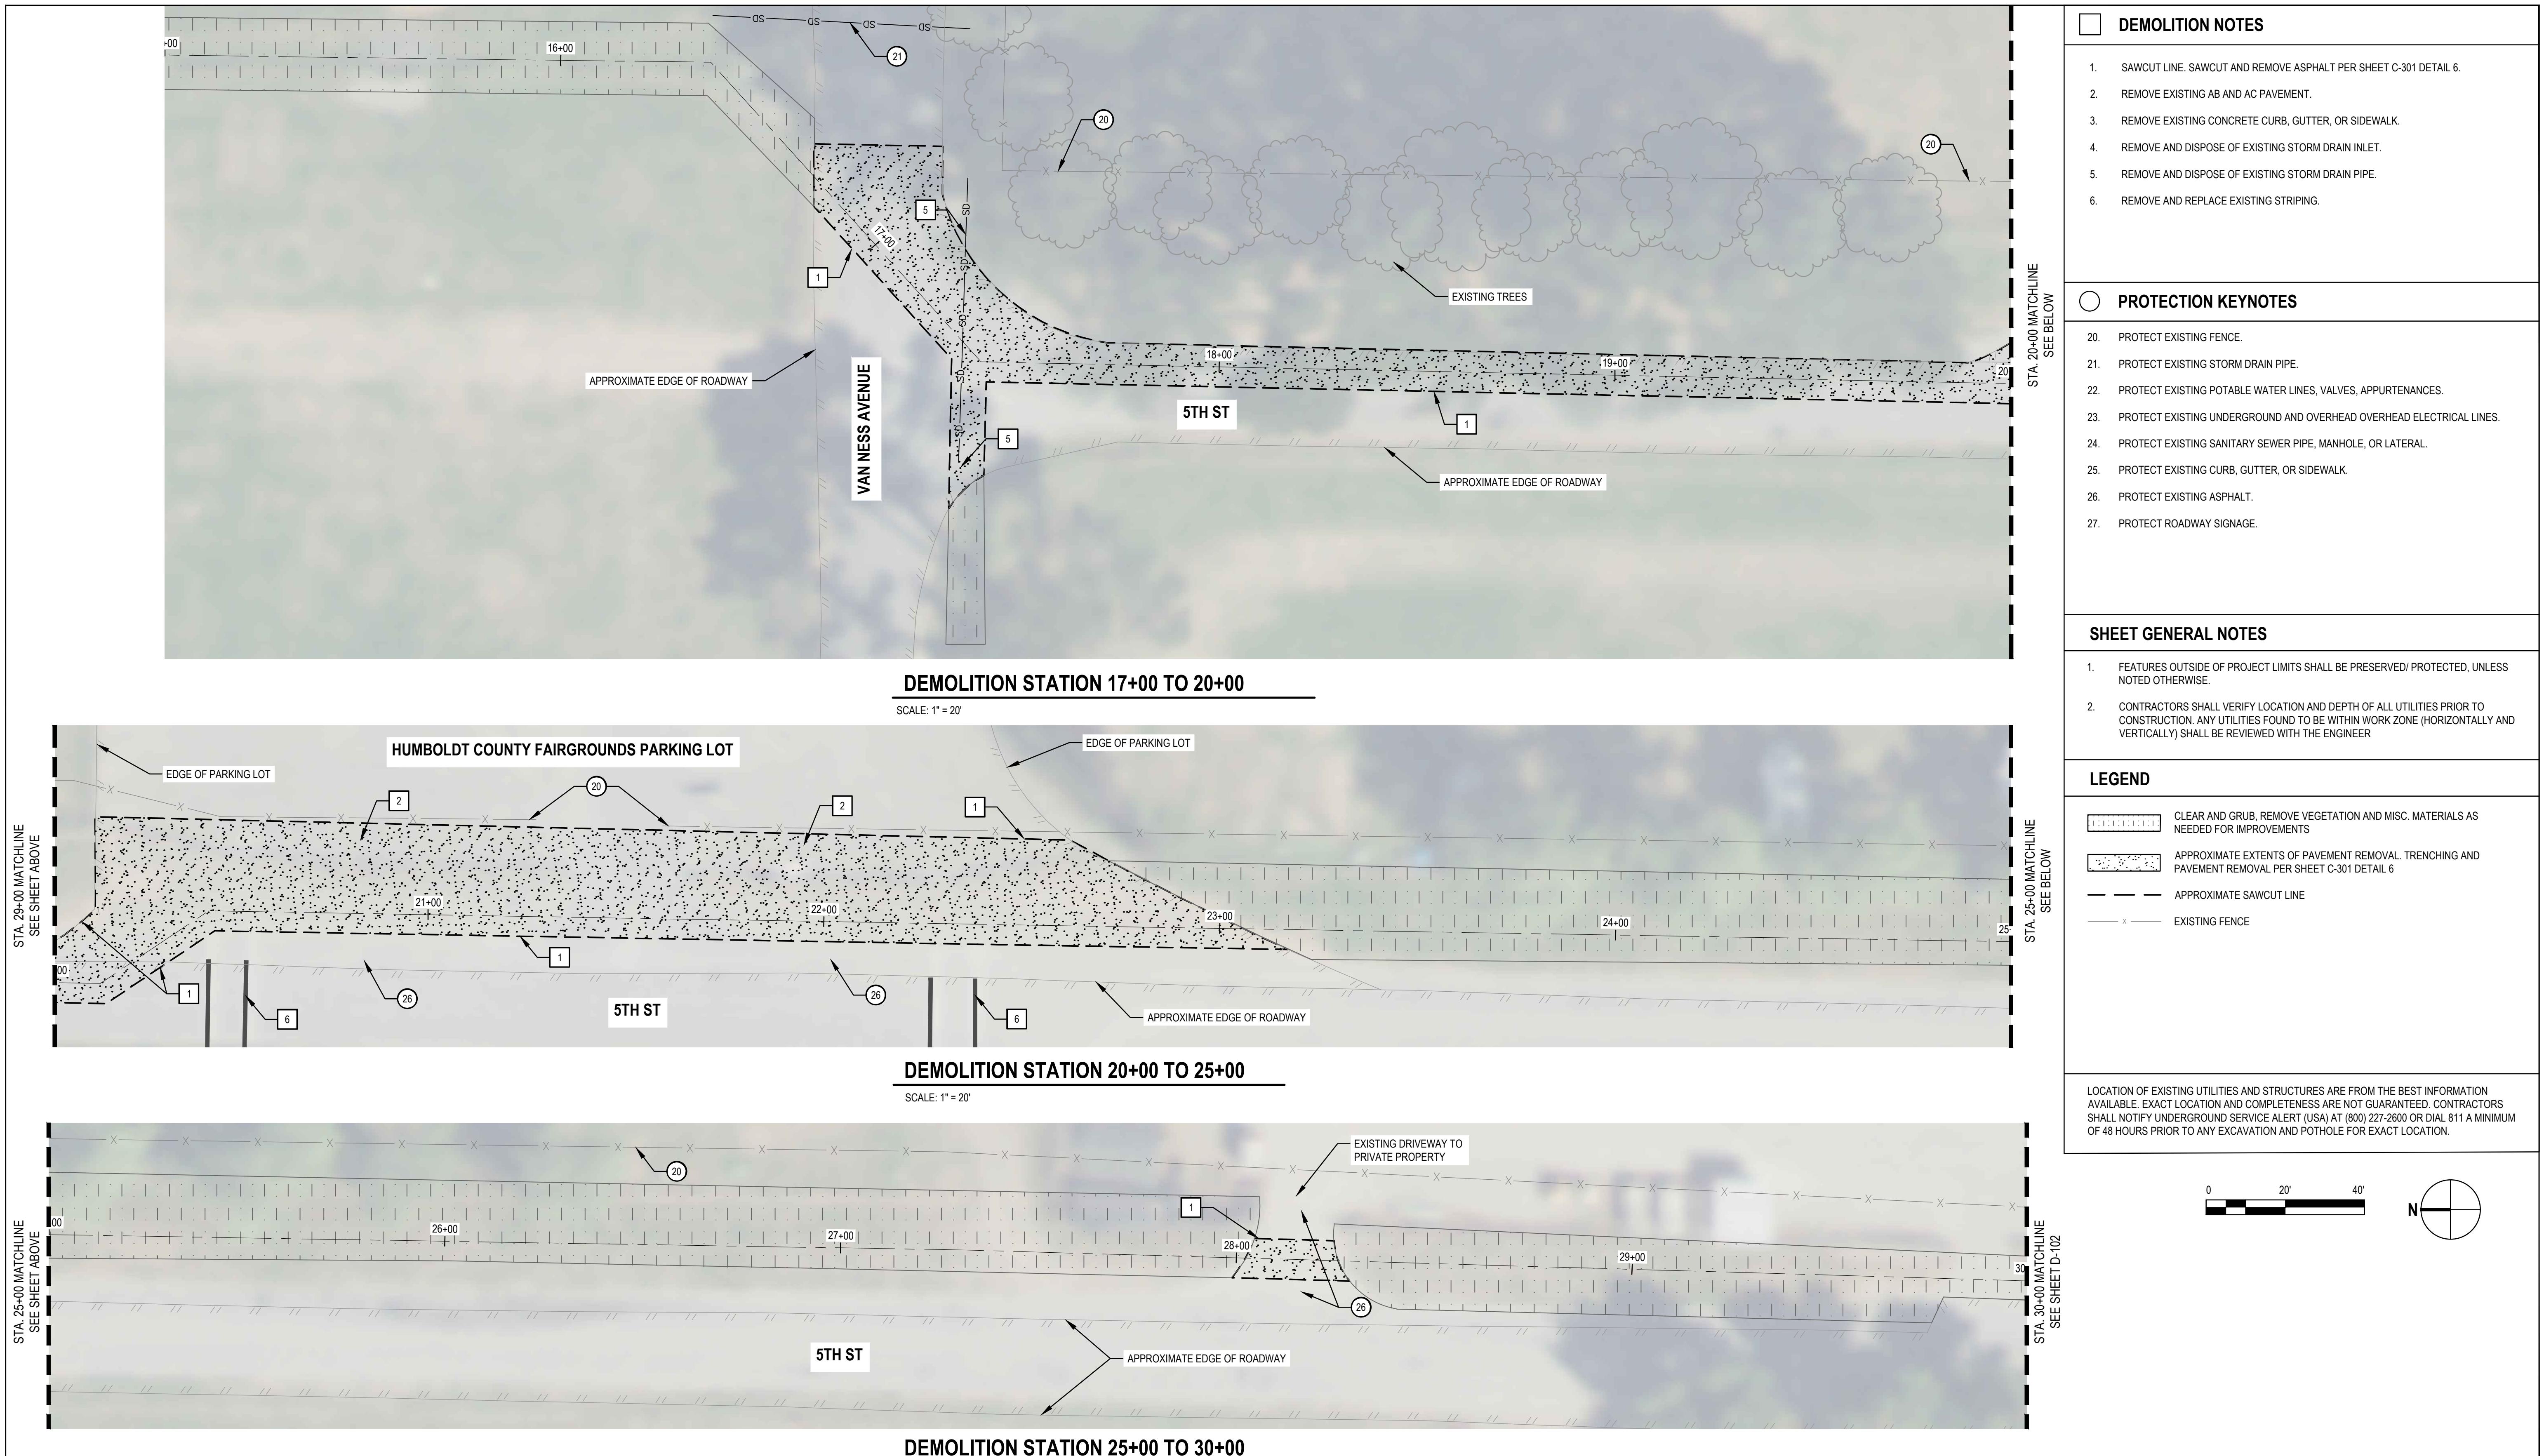Sheet No.  
**D-101**


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**PRELIMINARY**

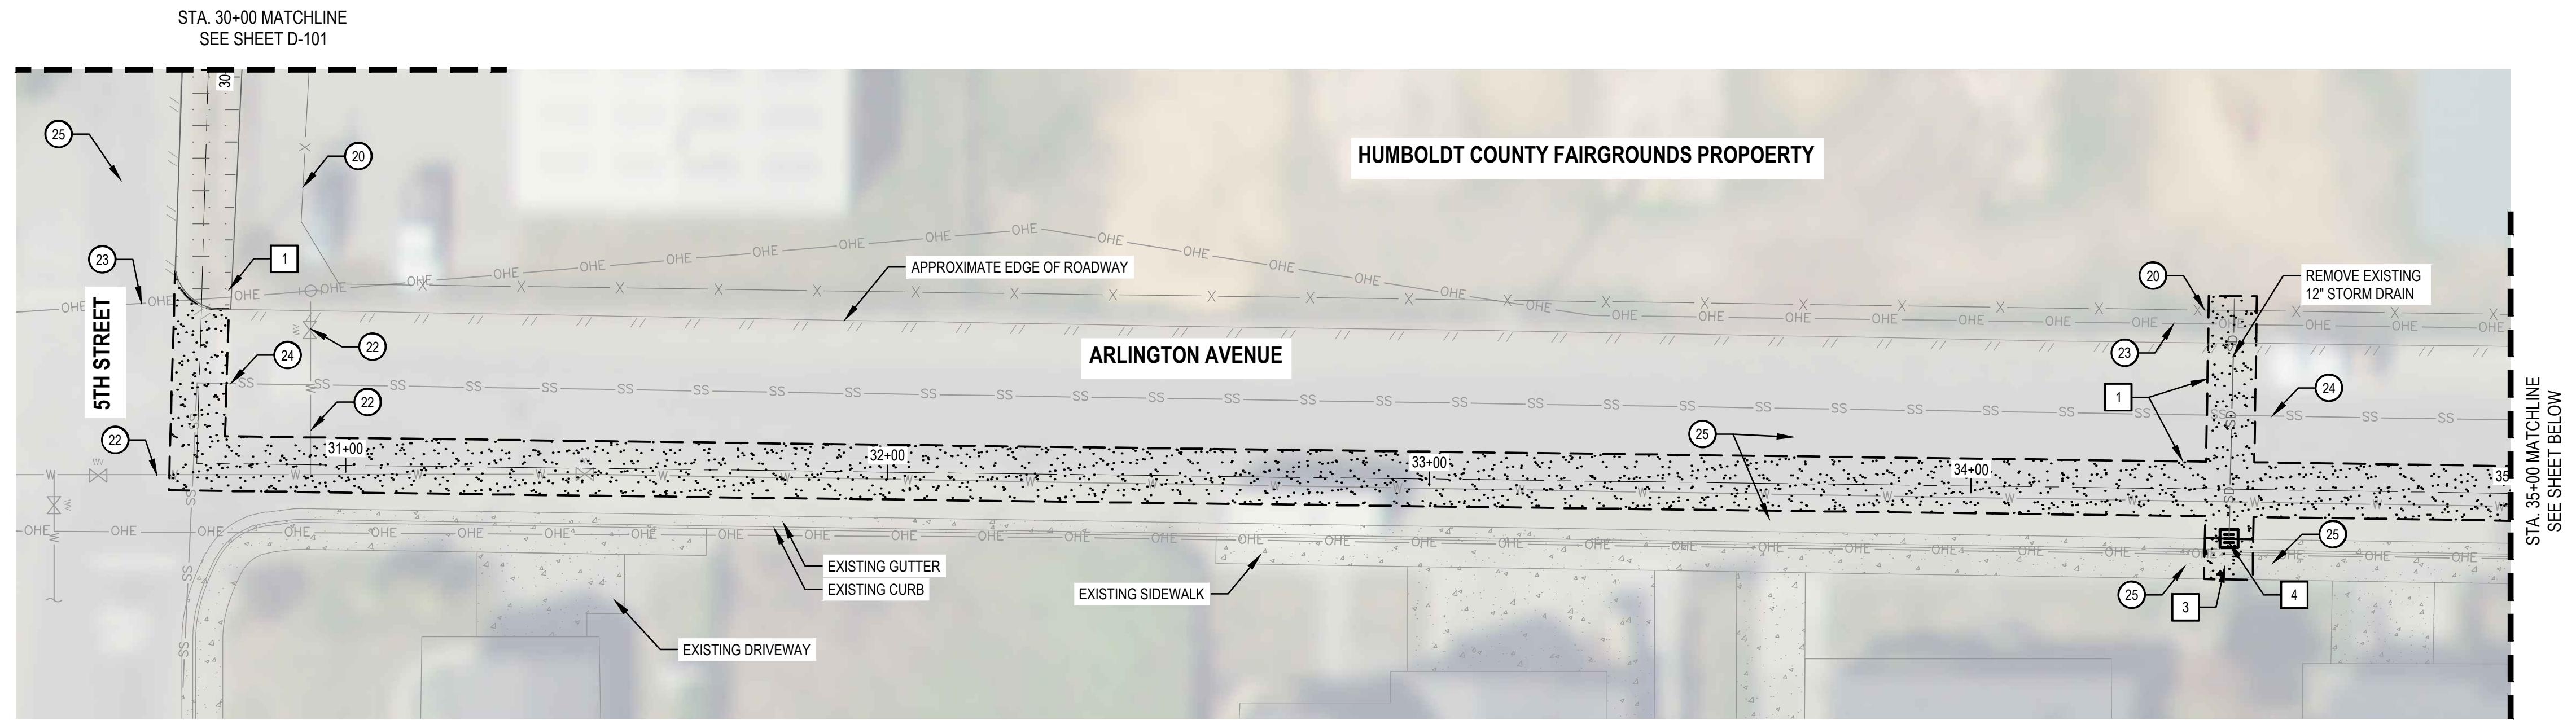

### DEMOLITION STATION 30+00 TO 35+00

SCALE: 1" = 20'

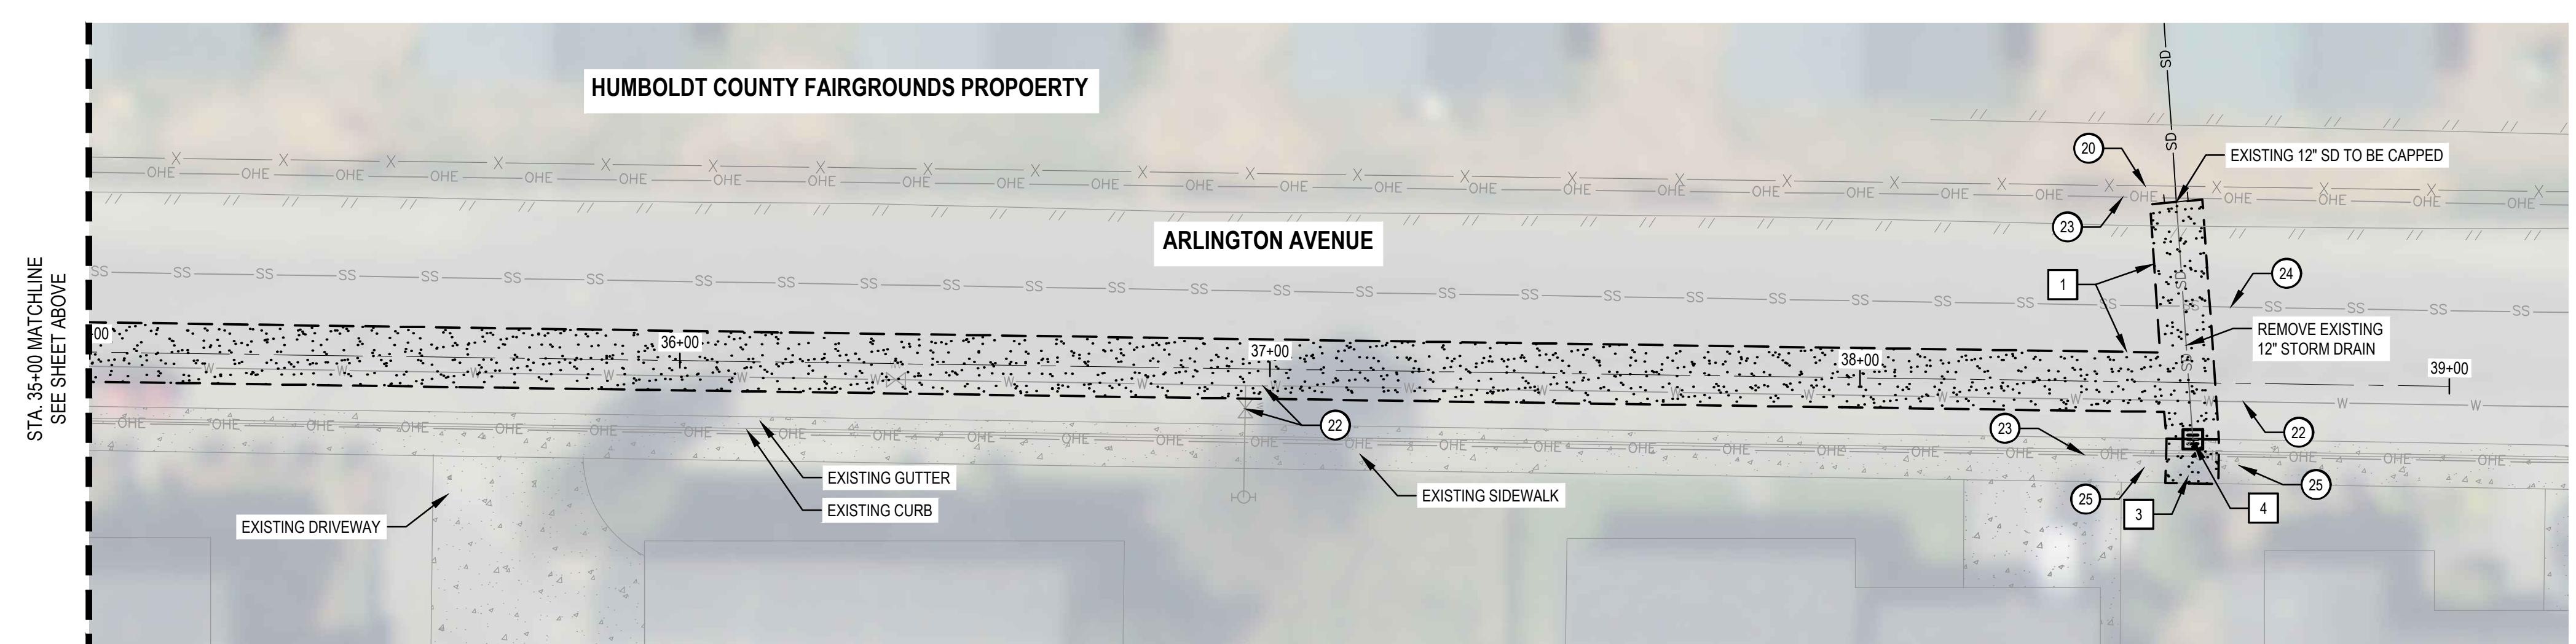

### DEMOLITION STATION 35+00 TO 39+00

SCALE: 1" = 20'

DEMOLITION NOTES	
1. SAWCUT LINE, SAWCUT AND REMOVE ASPHALT PER SHEET C-301 DETAIL 6.	
2. REMOVE EXISTING AB AND AC PAVEMENT.	
3. REMOVE EXISTING CONCRETE CURB, GUTTER, OR SIDEWALK.	
4. REMOVE AND DISPOSE OF EXISTING STORM DRAIN INLET.	
5. REMOVE AND DISPOSE OF EXISTING STORM DRAIN PIPE.	
6. REMOVE AND REPLACE EXISTING STRIPING.	
PROTECTION KEYNOTES	
20. PROTECT EXISTING FENCE.	
21. PROTECT EXISTING STORM DRAIN PIPE.	
22. PROTECT EXISTING POTABLE WATER AND OVERHEAD ELECTRICAL LINES.	
23. PROTECT EXISTING SANITARY SEWER PIPE, MANHOLE, OR LATERAL.	
24. PROTECT EXISTING CURB, GUTTER, OR SIDEWALK.	
25. PROTECT EXISTING ASPHALT.	
26. PROTECT ROADWAY SIGNAGE.	
SHEET GENERAL NOTES	
1. FEATURES OUTSIDE OF PROJECT LIMITS SHALL BE PRESERVED/PROTECTED, UNLESS NOTED OTHERWISE.	
2. CONTRACTORS SHALL VERIFY LOCATION AND DEPTH OF ALL UTILITIES PRIOR TO CONSTRUCTION. ANY UTILITIES FOUND TO BE WITHIN WORK ZONE (HORIZONTALLY AND VERTICALLY) SHALL BE REVIEWED WITH THE ENGINEER.	
LEGEND	
	CLEAR AND GRUB, REMOVE VEGETATION AND MISC. MATERIALS AS NEEDED FOR IMPROVEMENTS
	APPROXIMATE EXTENTS OF PAVEMENT REMOVAL, TRENCHING AND PAVEMENT REMOVAL PER SHEET C-301 DETAIL 6
	APPROXIMATE SAWCUT LINE
	EXISTING FENCE
LOCATION OF EXISTING UTILITIES AND STRUCTURES ARE FROM THE BEST INFORMATION AVAILABLE. EXACT LOCATION AND COMPLETENESS ARE NOT GUARANTEED. CONTRACTORS SHALL NOTIFY UNDERGROUND SERVICE ALERT (USA) AT (800) 227-2600 OR DIAL 811 A MINIMUM OF 48 HOURS PRIOR TO ANY EXCAVATION AND POTHOLE FOR EXACT LOCATION.	

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CITY OF FERNDALE

Project WATER QUALITY AND DRAINAGE  
IMPROVEMENTS PROJECT

Project No.

Date

Scale

AS SHOWN

Title EXISTING CONDITIONS AND  
DEMOLITION PLAN

Size  
ANSI D

Sheet No.  
D-102

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### GRADING NOTES

1. SURVEY OF EXISTING CONDITIONS CONDUCTED BY ONTIVEROS & ASSOCIATES ON NOVEMBER 22 AND 23, 2021.
2. CONTRACTOR IS RESPONSIBLE FOR CONSTRUCTION STAKING AND SHALL ARRANGE FOR STAKING BY A SURVEYOR LICENSED BY THE STATE OF CALIFORNIA. STAKING WILL BE REVIEWED BY CITY'S PROJECT MANAGER FOR CONFIRMATION TO DESIGN PRIOR TO CONSTRUCTION.
3. ALL GRADES BETWEEN SPOT ELEVATIONS SHALL HAVE UNIFORM SLOPE UNLESS OTHERWISE INDICATED. MAINTAIN POSITIVE DRAINAGE AWAY FROM ALL BUILDING WALLS AND DOORS.
4. CONTRACTOR SHALL BE RESPONSIBLE FOR THE SAFETY OF ALL CONSTRUCTION. ADEQUATE SHORING BRACING, TIES, AND SUPPORTS SHALL BE USED TO PROVIDE PROPER TEMPORARY INTEGRITY DURING ALL PHASES OF CONSTRUCTION.
5. ALL EXISTING LANDSCAPED AND UNPAVED AREAS WHICH ARE DISTURBED BY CONSTRUCTION OR EARTHWORK OPERATIONS SHALL BE HAND RAKED SMOOTH, LANDSCAPED, AND RETURNED TO ORIGINAL EXISTING CONDITIONS.
6. ALL DITCHES, SWALES, GUTTERS, ETC. SHOULD BE CONSIDERED ACTIVE STORM CONVEYANCES UNLESS OTHERWISE INDICATED. CONTRACTOR IS RESPONSIBLE FOR ADDRESSING STORM WATER DRAINAGE AND Dewatering OF WORK AREAS DURING CONSTRUCTION.
7. DURING WET WEATHER PERIODS, CONTRACTOR IS RESPONSIBLE FOR SEQUENCING CONSTRUCTION IN A MANNER TO MINIMIZE IMPACT ON OPEN EARTHWORK AND COMPACTION OPERATIONS.


### SHEET GENERAL NOTES



1. FEATURES OUTSIDE OF PROJECT LIMITS SHALL BE PRESERVED/ PROTECTED, UNLESS NOTED OTHERWISE.
2. ALL FINISHED GRADES THAT TIE INTO EXISTING, SHALL CONFORM TO EXISTING ELEVATIONS.
3. CONTRACTOR SHALL VERIFY BASIN LAYOUT WITH CITY OF FERNDALE, PRIOR TO CONSTRUCTION.

### APPROXIMATE EXCAVATION QUANTITIES

	CUT (CY)	FILL (CY)	TOTAL (CY)
BOSWALE	401	0	401
DETENTION BASIN	1212	0	1212
<b>TOTAL</b>	<b>1613</b>	<b>0</b>	<b>1613</b>

- All excavation quantities are in cubic yards with no shrinkage or expansion factor applied.
- No site clearing or grubbing depth was applied to these excavation volumes.

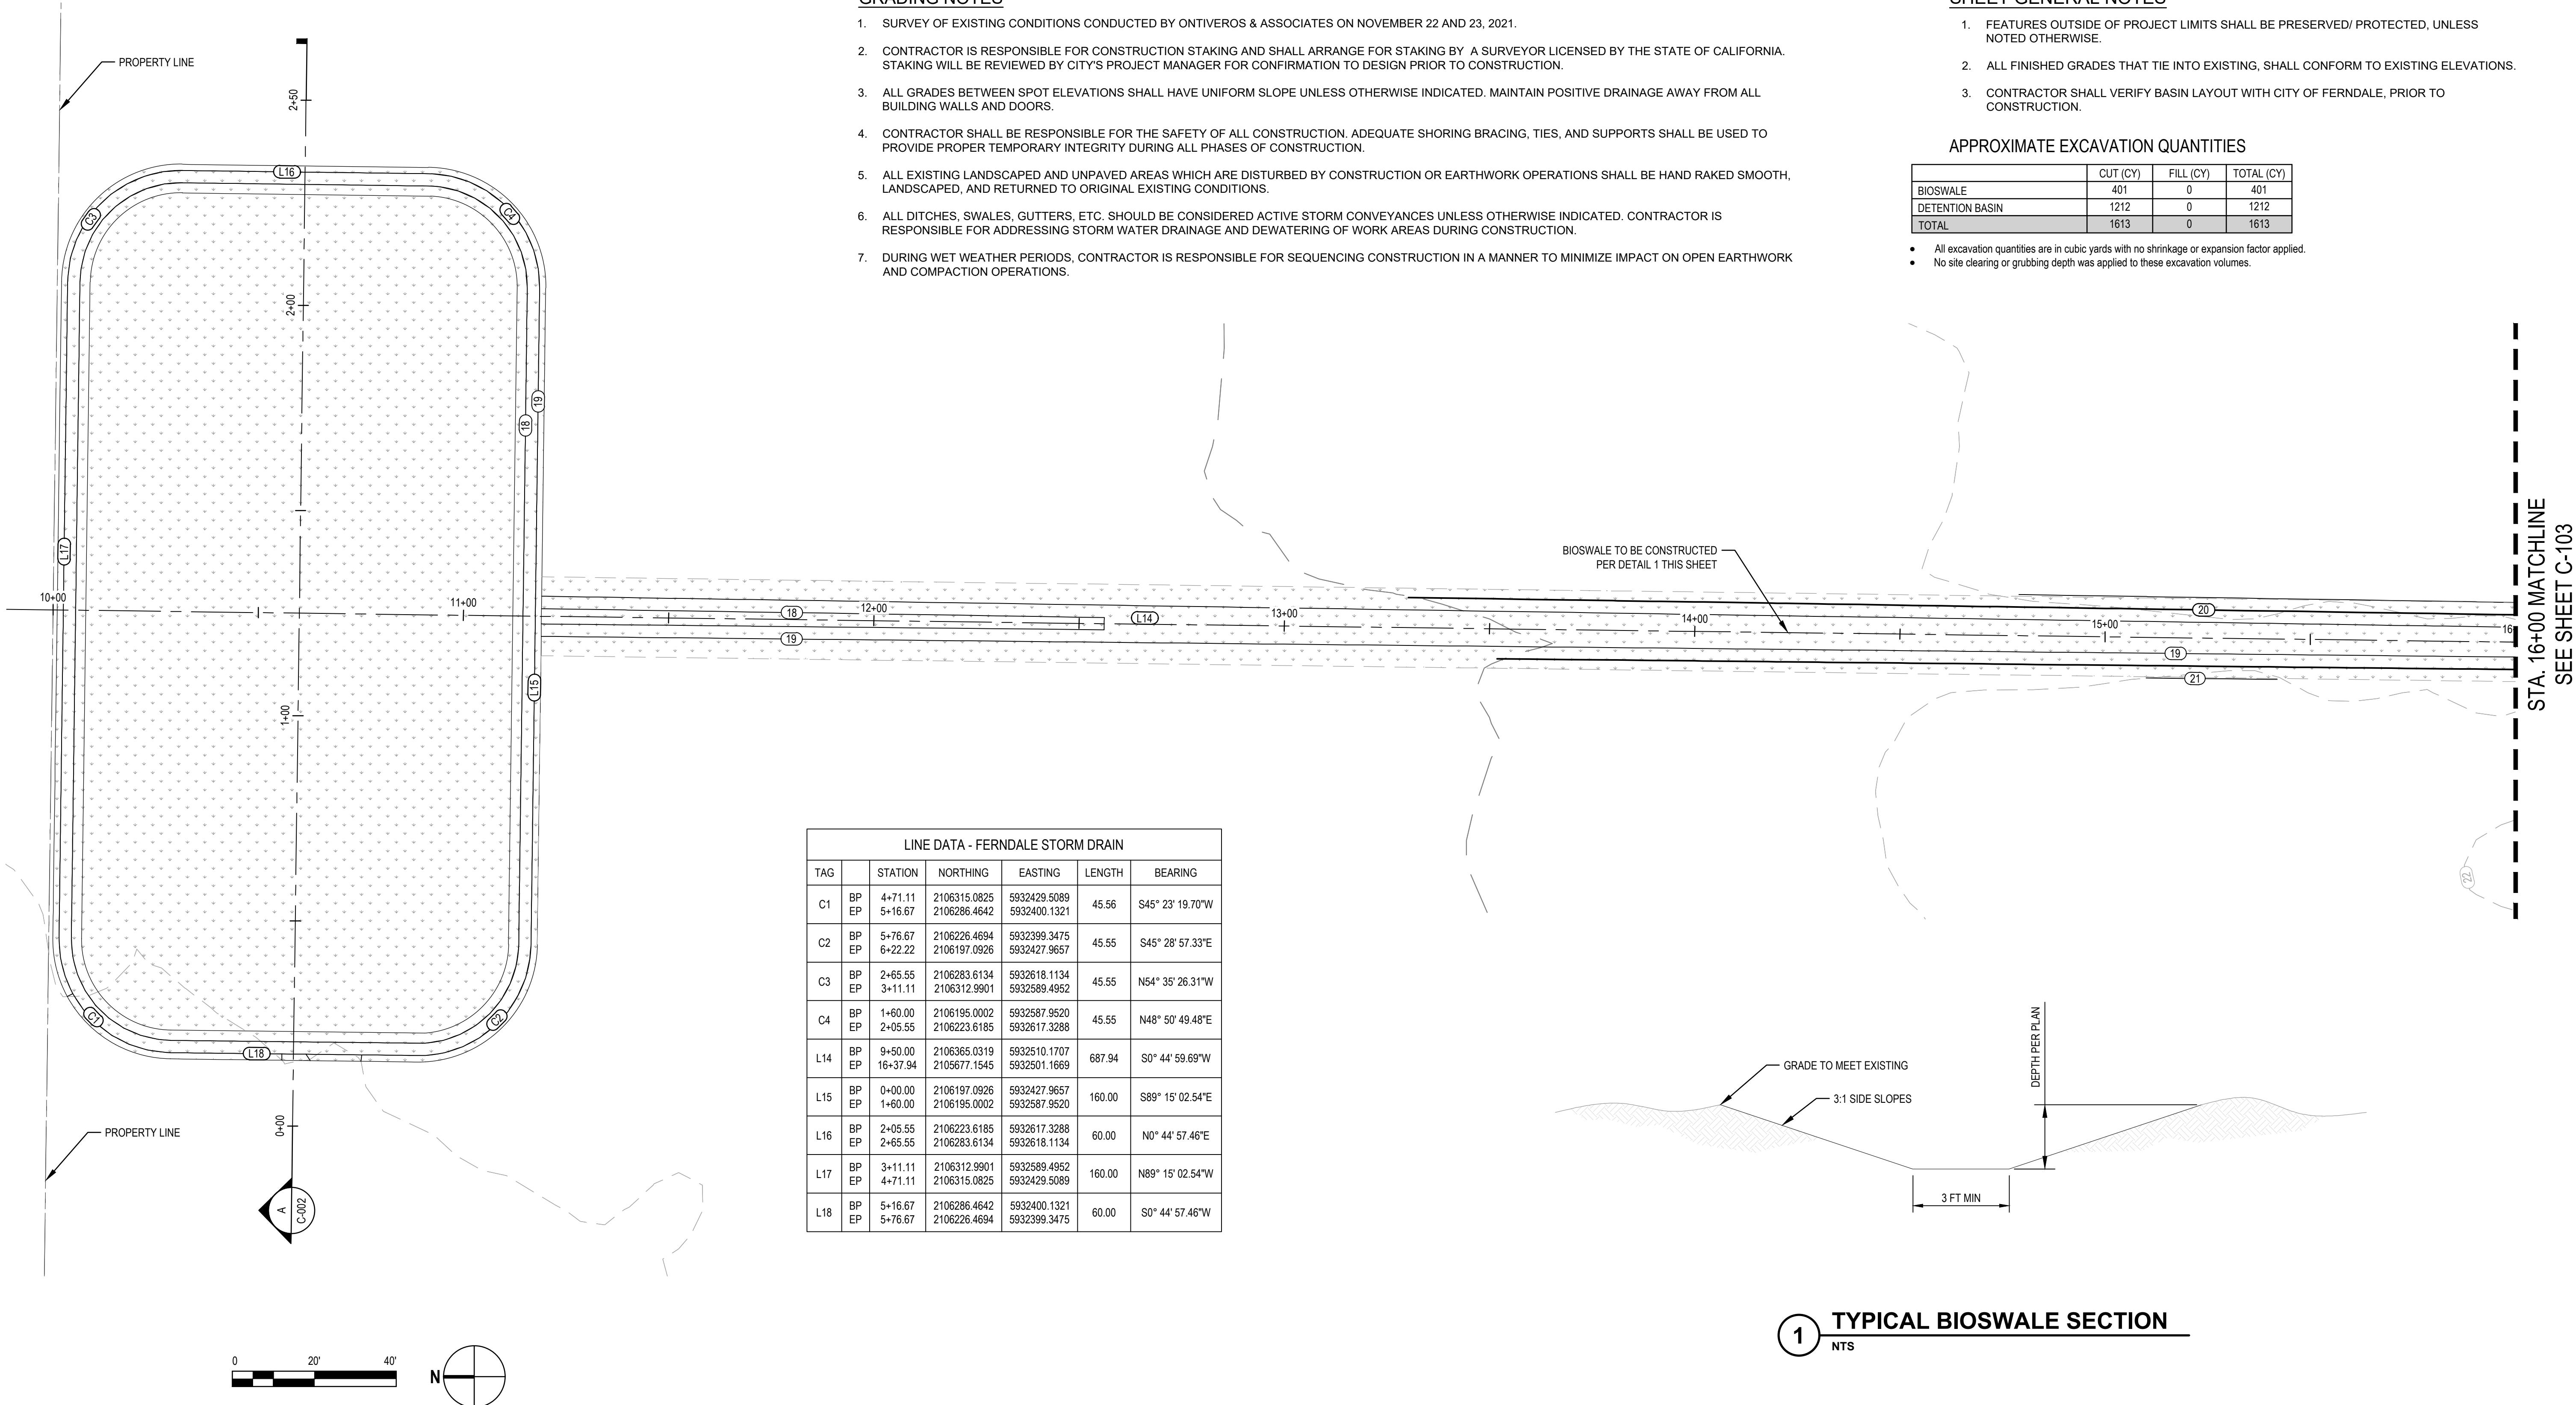

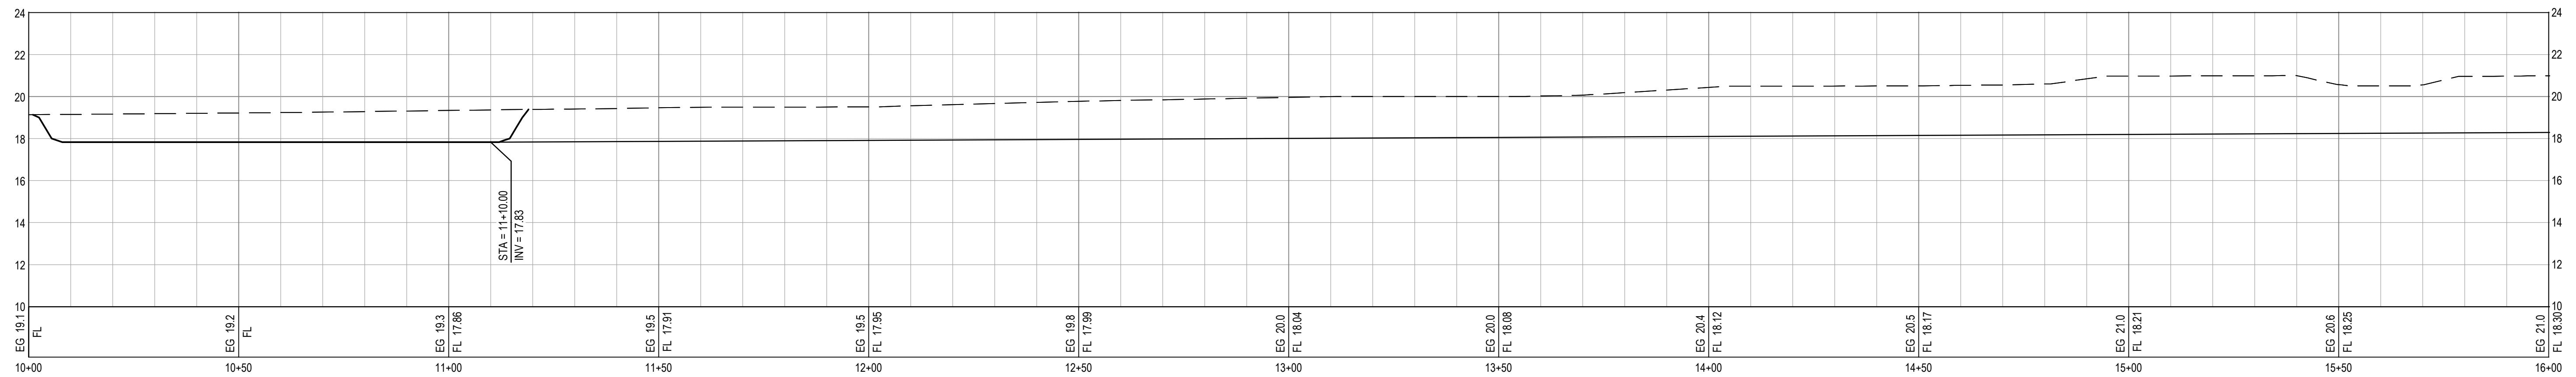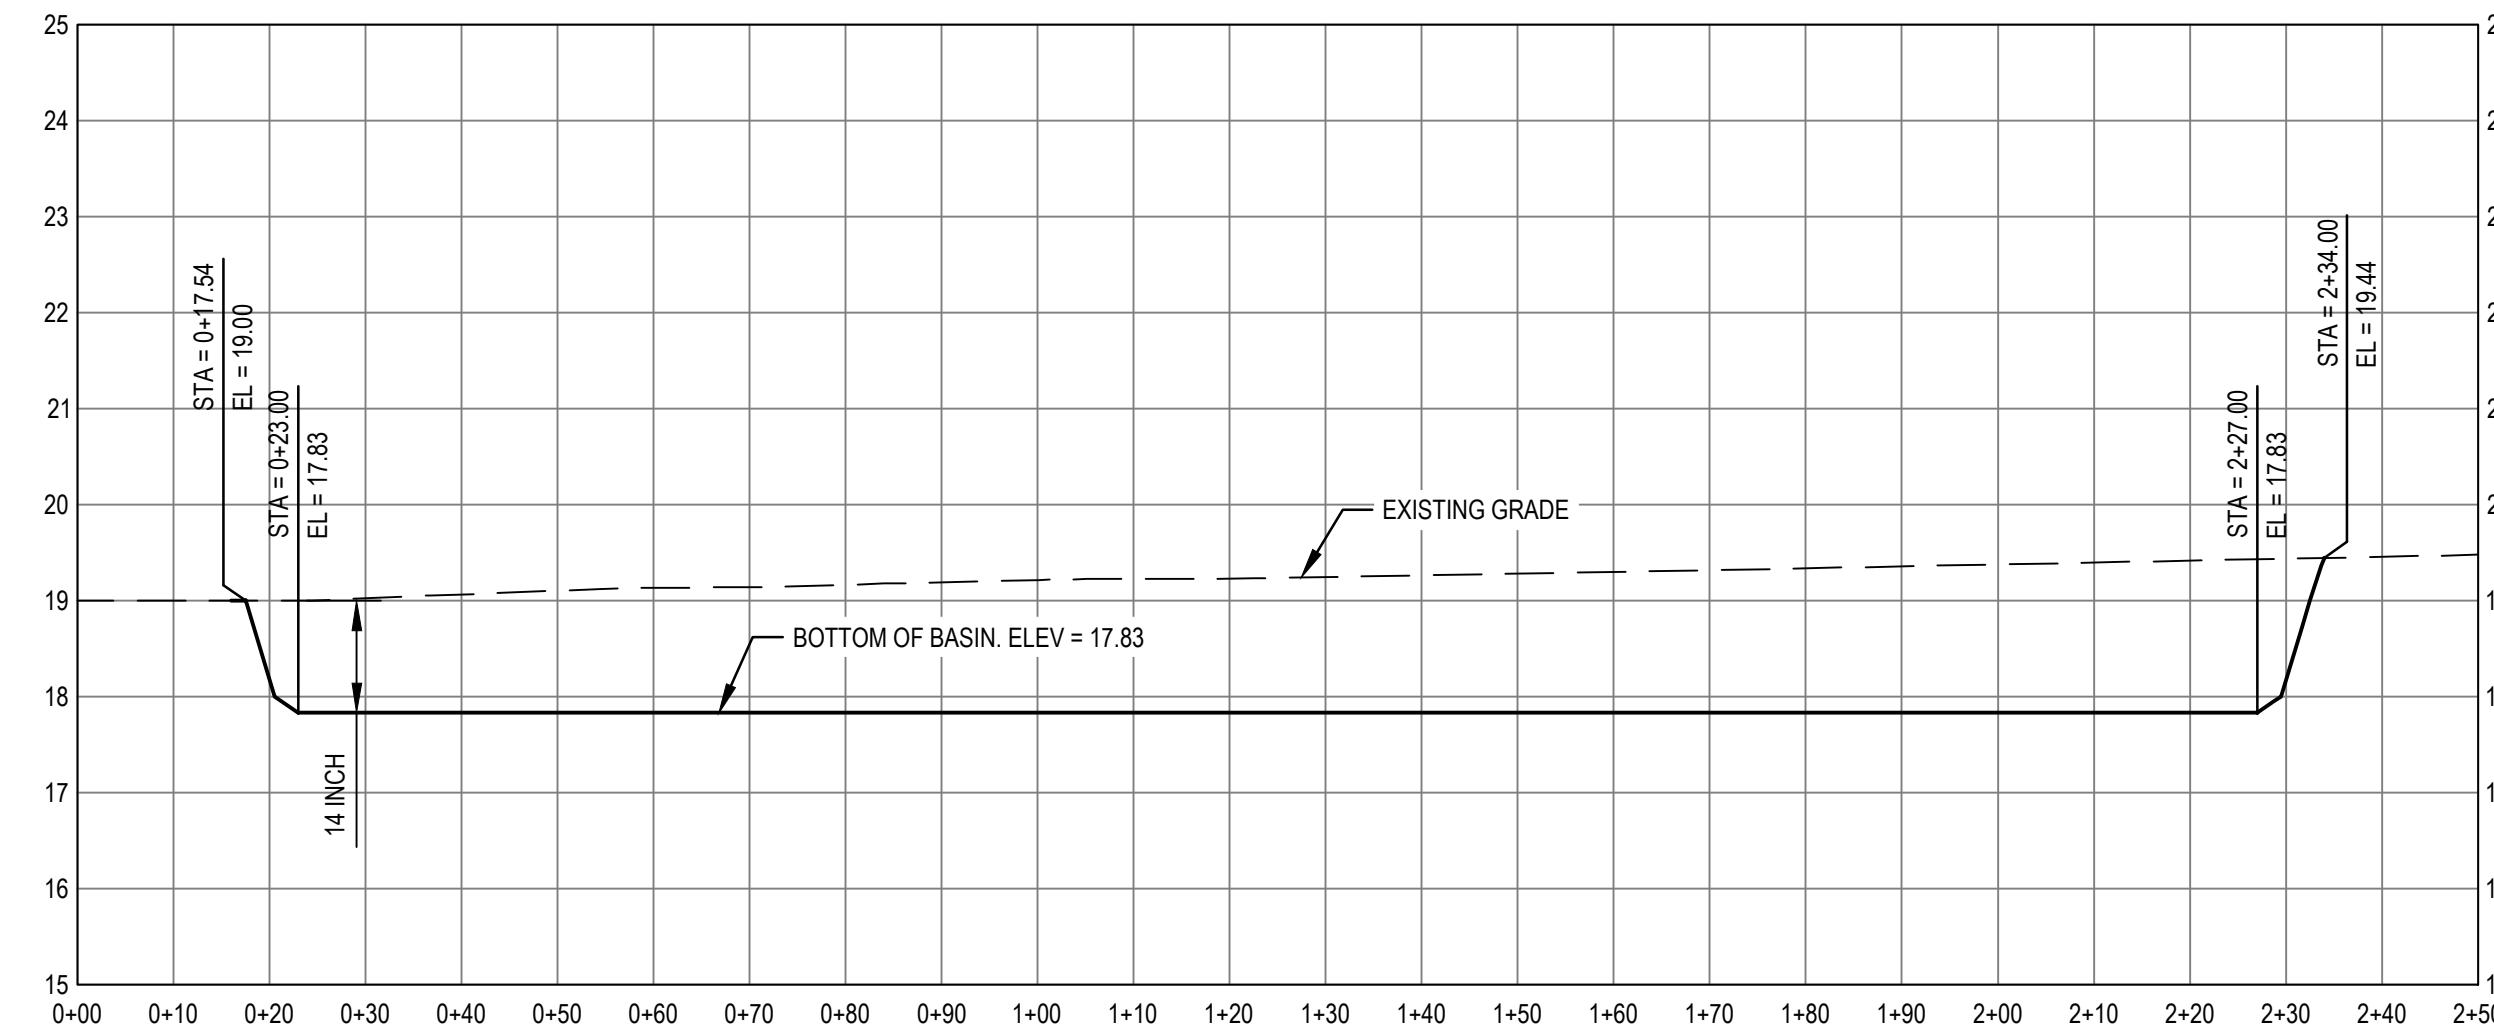

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CITY OF FERNDALE


Project WATER QUALITY AND DRAINAGE  
IMPROVEMENTS PROJECT


Project No. 12561178 Date 2024-09-12 Scale AS SHOWN

Title GRADING SECTIONS

Size  
ANSI D


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Sheet 7 of 13

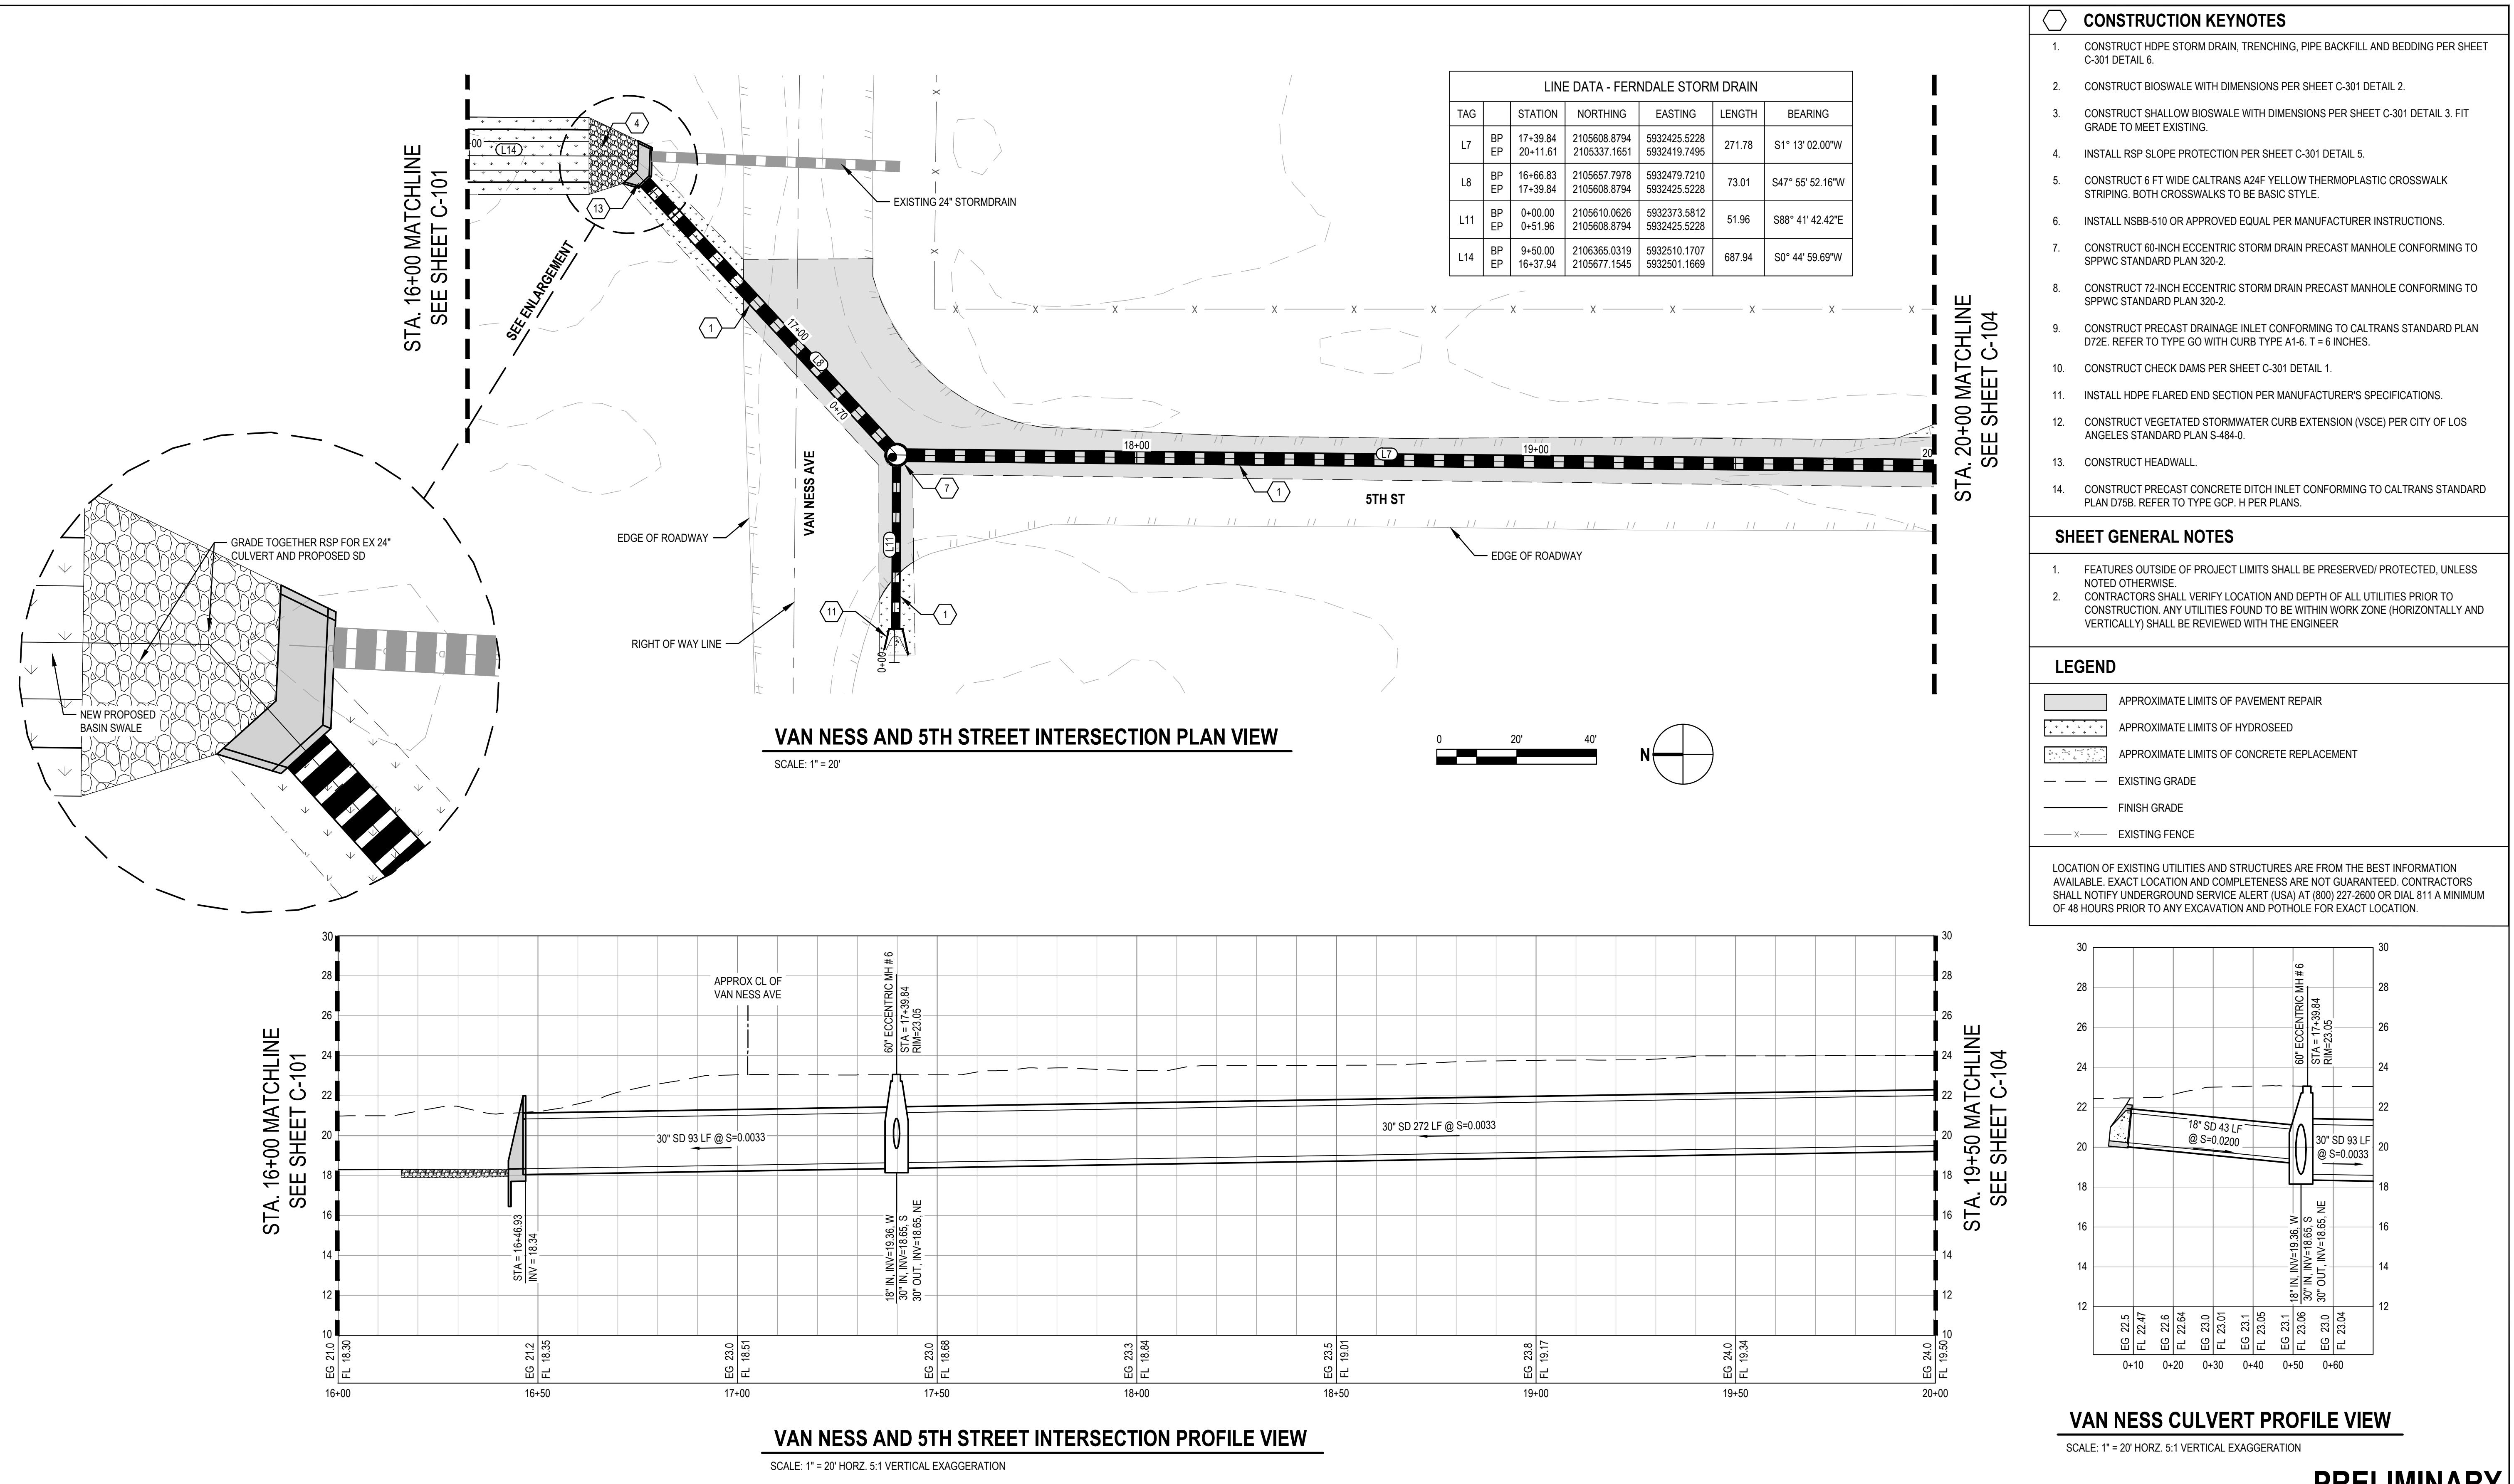


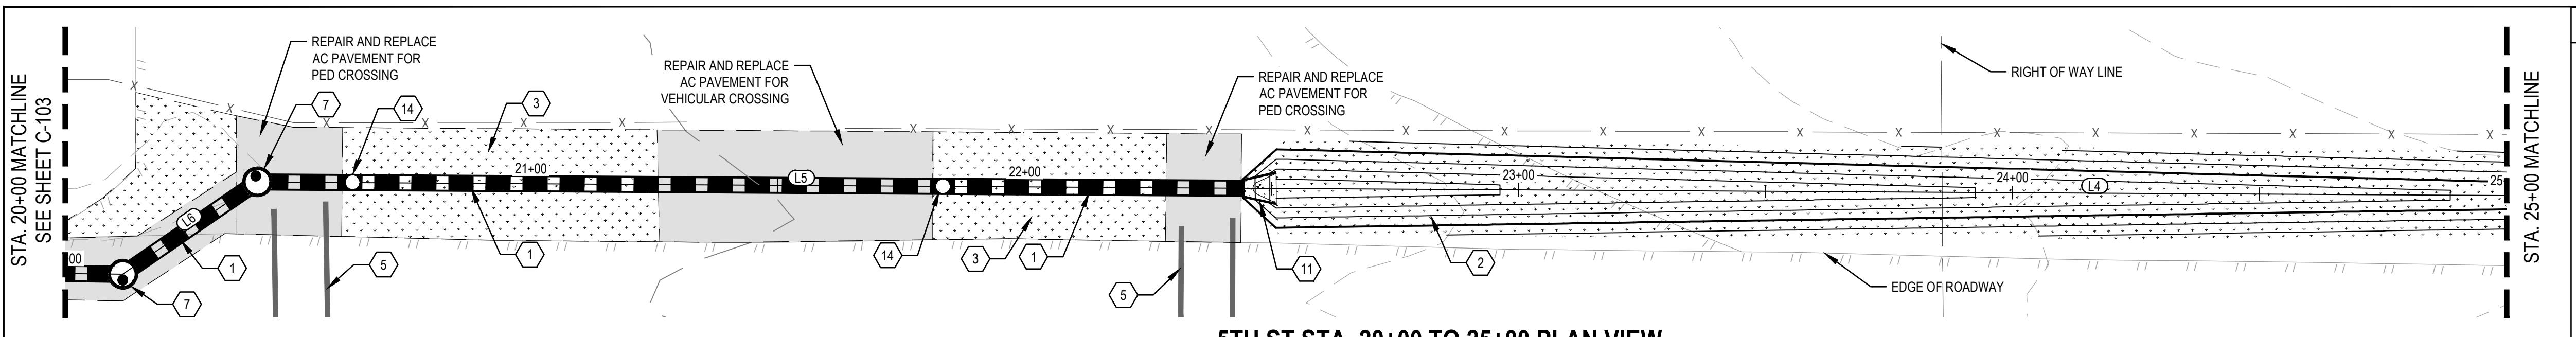

**CONSTRUCTION KEYNOTES**

1. CONSTRUCT HDPE STORM DRAIN, TRENCHING, PIPE BACKFILL AND BEDDING PER SHEET C-301 DETAIL 6.
2. CONSTRUCT BIOSWALE WITH DIMENSIONS PER SHEET C-301 DETAIL 2.
3. CONSTRUCT SHALLOW BIOSWALE WITH DIMENSIONS PER SHEET C-301 DETAIL 3. FIT GRADE TO MEET EXISTING.
4. INSTALL RSP SLOPE PROTECTION PER SHEET C-301 DETAIL 5.
5. CONSTRUCT 6 FT WIDE CALTRANS A24F YELLOW THERMOPLASTIC CROSSWALK STRIPING. BOTH CROSSWALKS TO BE BASIC STYLE.
6. INSTALL NSBB-510 OR APPROVED EQUAL PER MANUFACTURER INSTRUCTIONS.
7. CONSTRUCT 60-INCH ECCENTRIC STORM DRAIN PRECAST MANHOLE CONFORMING TO SPWVC STANDARD PLAN 320-2.
8. CONSTRUCT 72-INCH ECCENTRIC STORM DRAIN PRECAST MANHOLE CONFORMING TO SPWVC STANDARD PLAN 320-2.
9. CONSTRUCT PRECAST DRAINAGE INLET CONFORMING TO CALTRANS STANDARD PLAN D72E. REFER TO TYPE GO WITH CURB TYPE A1-6. T = 6 INCHES.
10. CONSTRUCT CHECK DAMS PER SHEET C-301 DETAIL 1.
11. INSTALL HDPE FLARED END SECTION PER MANUFACTURER'S SPECIFICATIONS.
12. CONSTRUCT VEGETATED STORMWATER CURB EXTENSION (VSCE) PER CITY OF LOS ANGELES STANDARD PLAN S-484-0.
13. CONSTRUCT HEADWALL.
14. CONSTRUCT PRECAST CONCRETE DITCH INLET CONFORMING TO CALTRANS STANDARD PLAN D75B. REFER TO TYPE GCP. H PER PLANS.

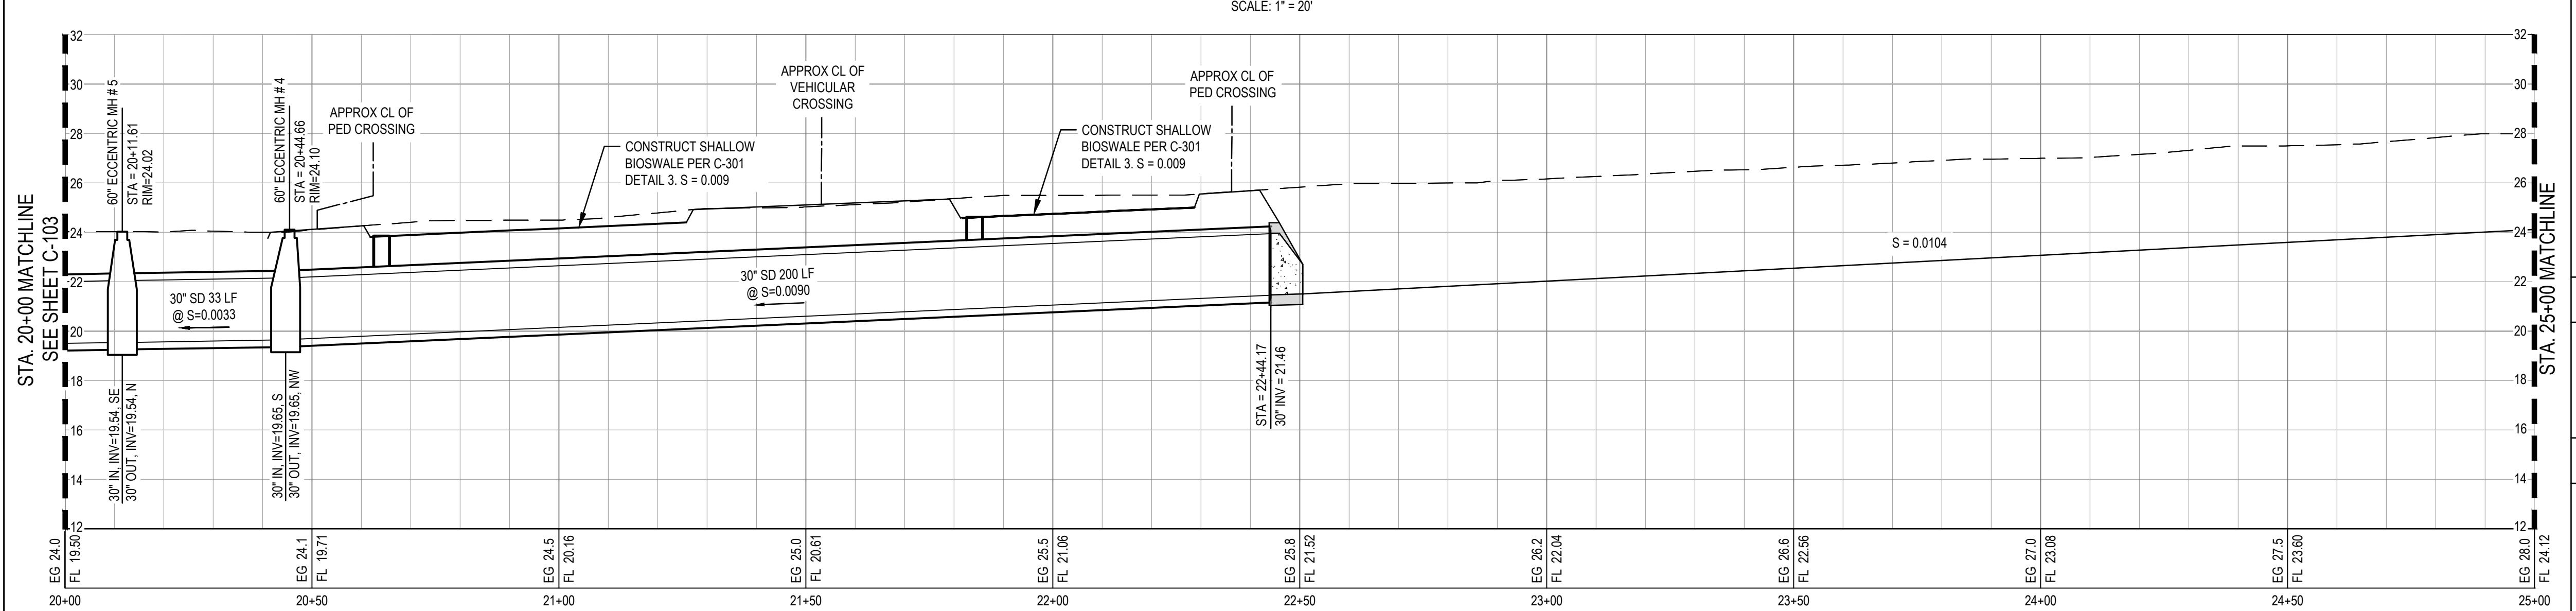

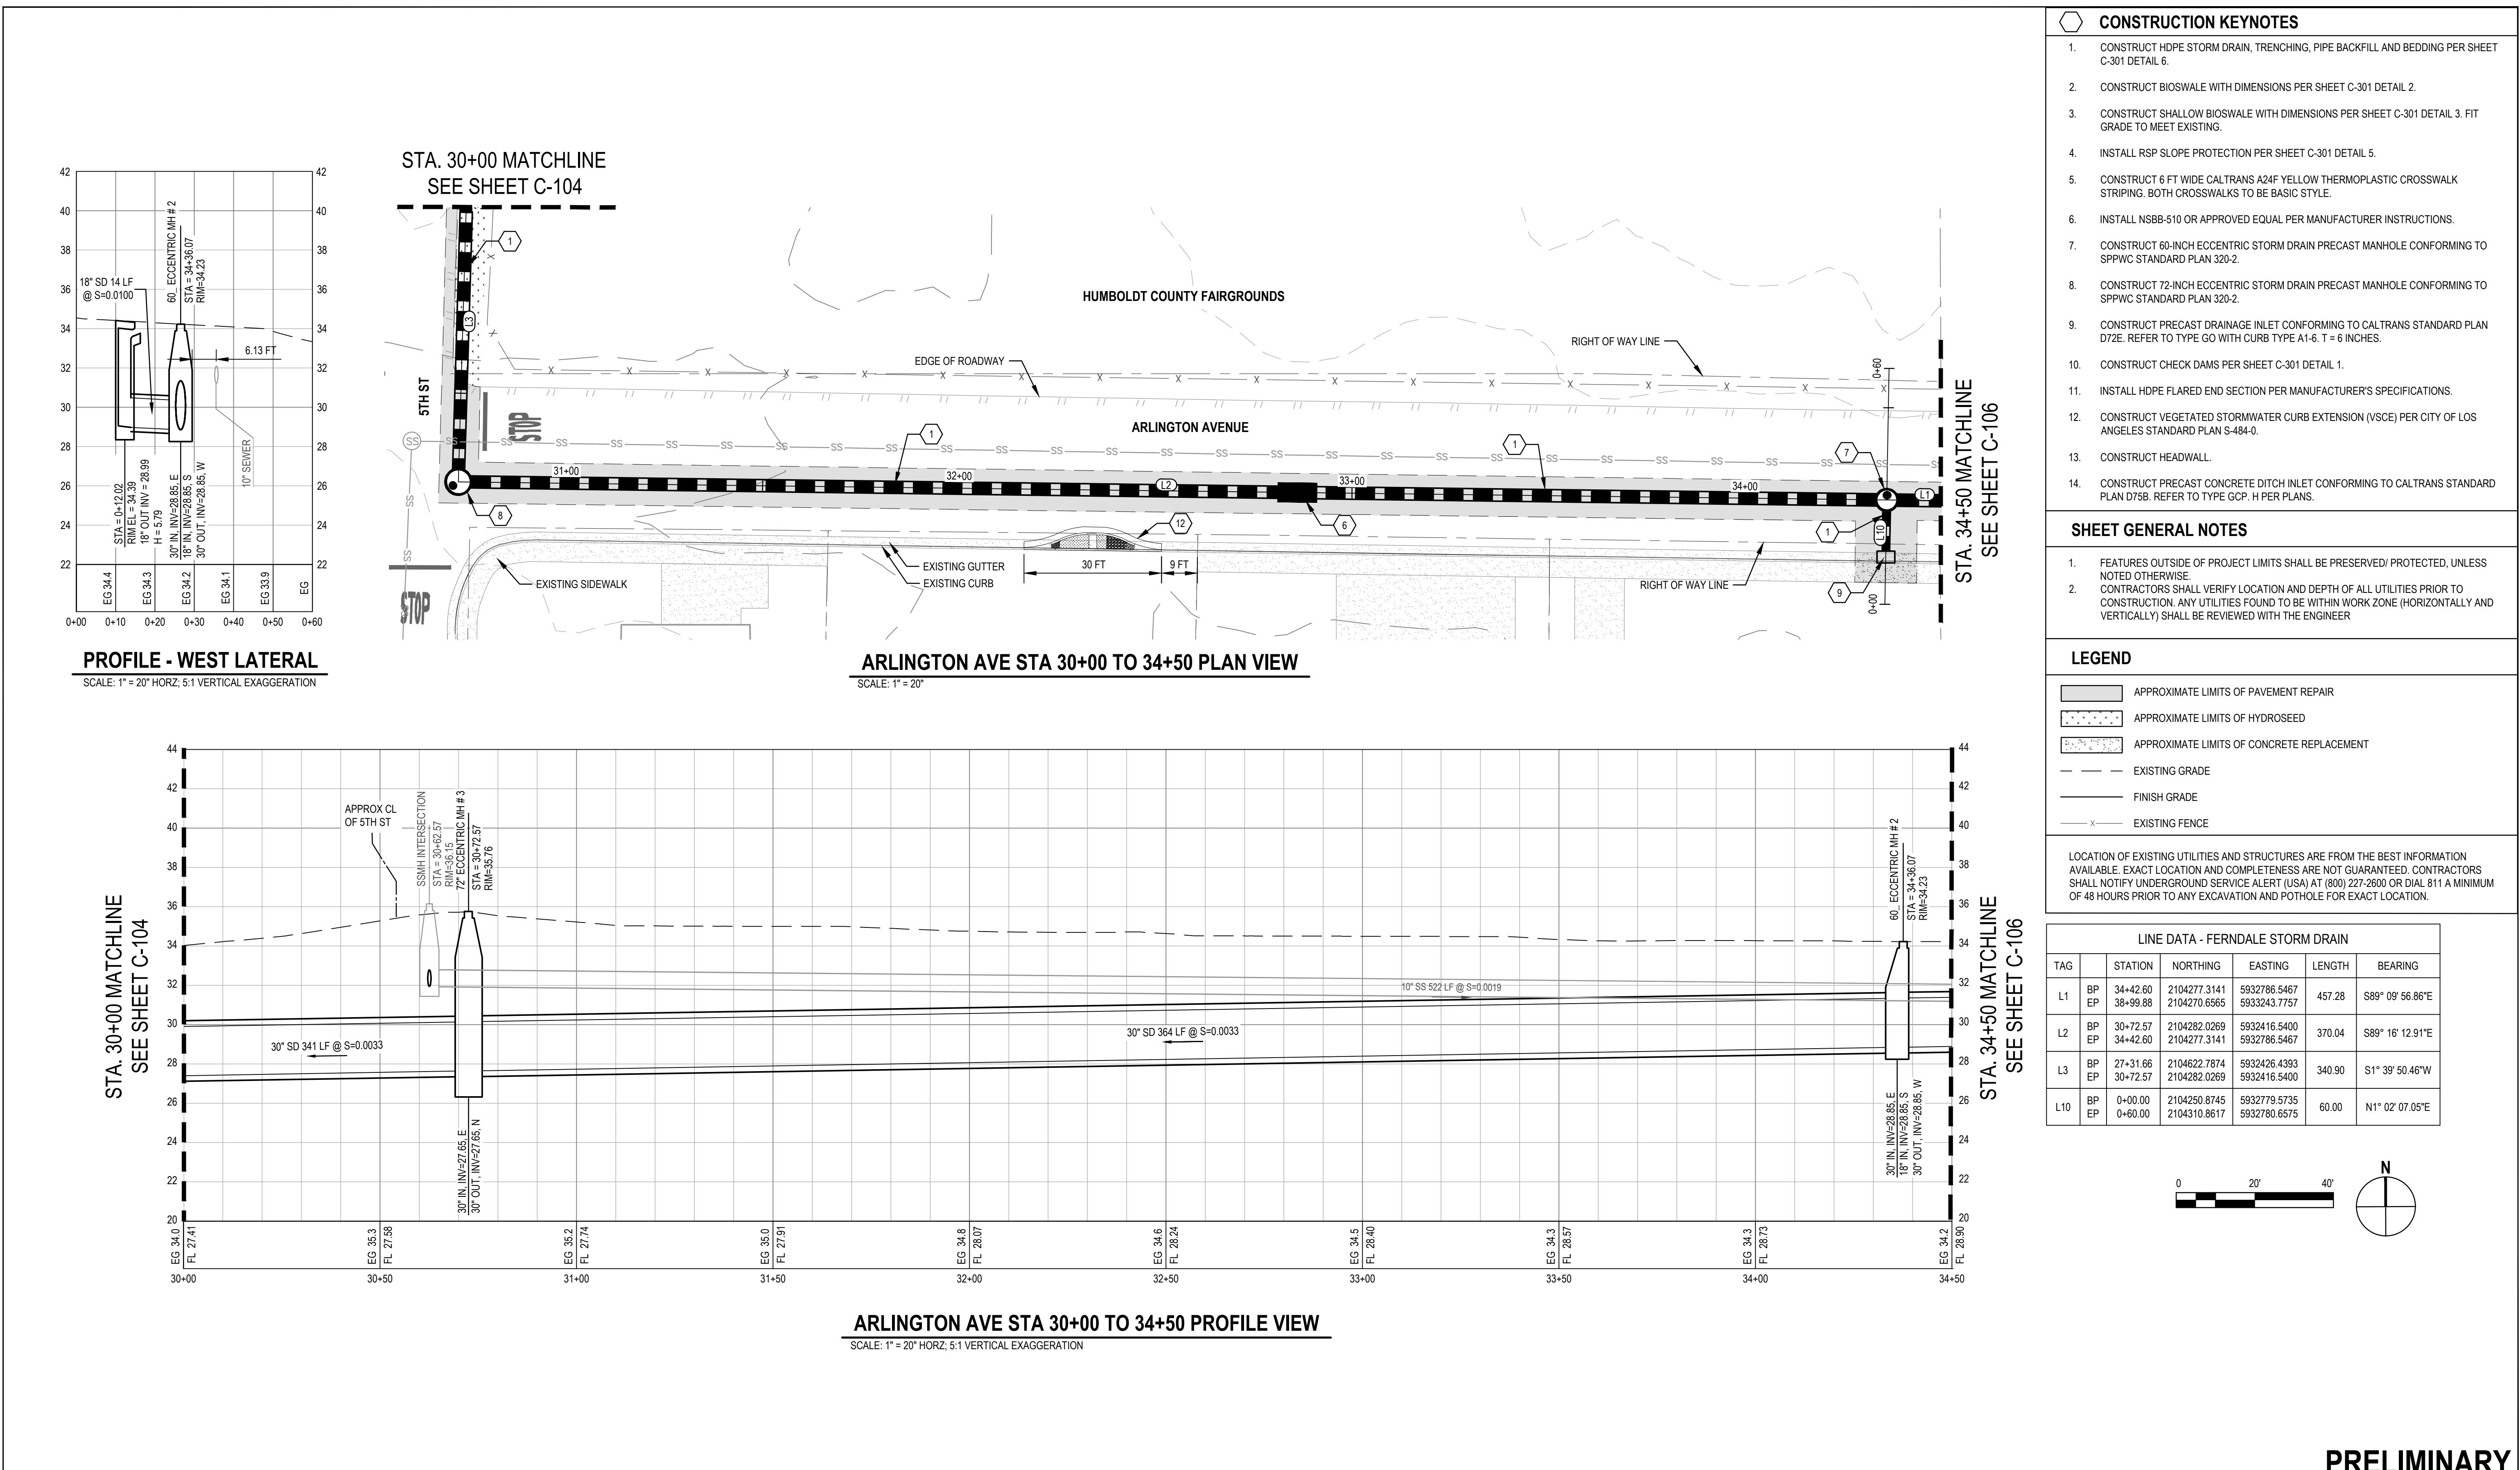

No.	Issue	Checked	Approved	Date
Author	Drafting Check	BRETT VIVIAN	Project Manager	BRETT VIVIAN



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CITY OF FERNDALE  
Project WATER QUALITY AND DRAINAGE  
IMPROVEMENTS PROJECT

Title 5TH ST AND ARLINGTON AVE  
PLAN AND PROFILE STA. 30+00 To  
34+50

Size  
ANSI D

Project No. 12561178 Date 2024-09-12 Scale AS SHOWN

Sheet No. C-105 10 of 13


**CONSTRUCTION KEYNOTES**

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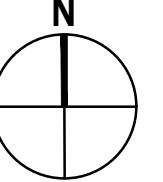
**SHEET GENERAL NOTES**

1. FEATURES OUTSIDE OF PROJECT LIMITS SHALL BE PRESERVED/PROTECTED, UNLESS NOTED OTHERWISE.
2. CONTRACTORS SHALL VERIFY LOCATION AND DEPTH OF ALL UTILITIES PRIOR TO CONSTRUCTION. ANY UTILITIES FOUND TO BE WITHIN WORK ZONE (HORIZONTALLY AND VERTICALLY) SHALL BE REVIEWED WITH THE ENGINEER

**LEGEND**

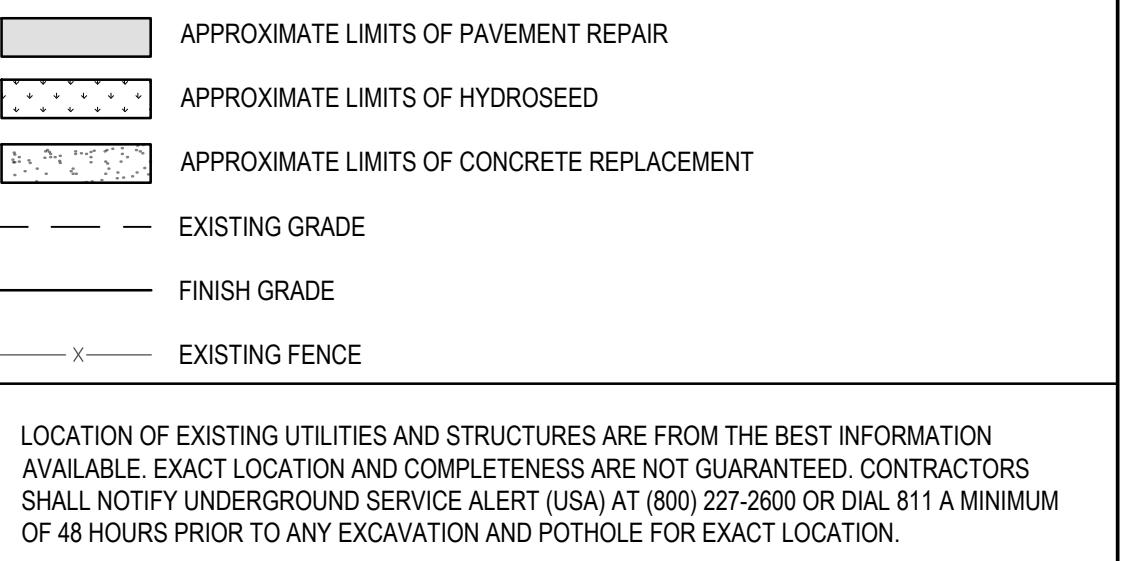

LINE DATA - FERNDALE STORM DRAIN						
TAG	STATION	NORTHING	EASTING	LENGTH	BEARING	
L1	BP EP	34+42.60 38+99.88	2104277.3141 2104270.6565	5932786.5467 5933243.7757	457.28	S89° 09' 56.86"E
L9	BP EP	0+13.42 0+26.87	2104258.0035 2104271.4545	5933188.9704 5933188.9697	13.45	N0° 00' 11.96"W



**PRELIMINARY**

No.	Issue	Checked	Approved	Date
Author	Drafting Check	BRETT VIVIAN	Project Manager	BRETT VIVIAN
Designer TAYLOR ALLEN	Design Check	BRETT VIVIAN	Project Director	JEREMY SVEHLA




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CITY OF FERNDALE

Project **WATER QUALITY AND DRAINAGE  
IMPROVEMENTS PROJECT**

Project No. 12561178

Date 2024-09-12

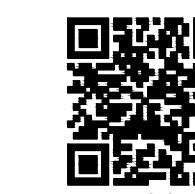
Scale AS SHOWN

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PROFILE STA. 34+50 TO 38+60**


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Sheet No. **C-106**


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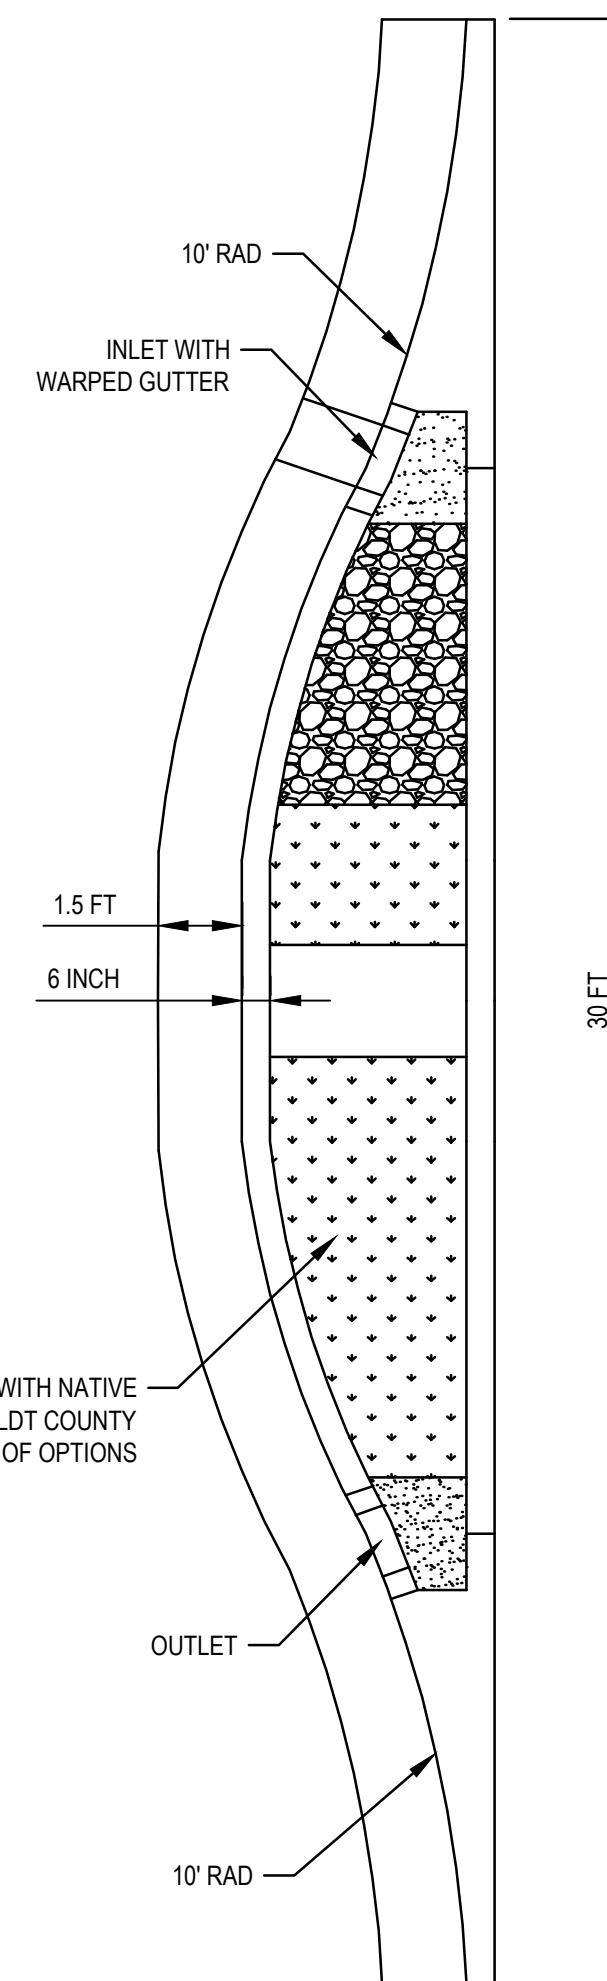
1 TYPICAL BIOSWALE WITH CHECK DAM PROFILE  
NTS

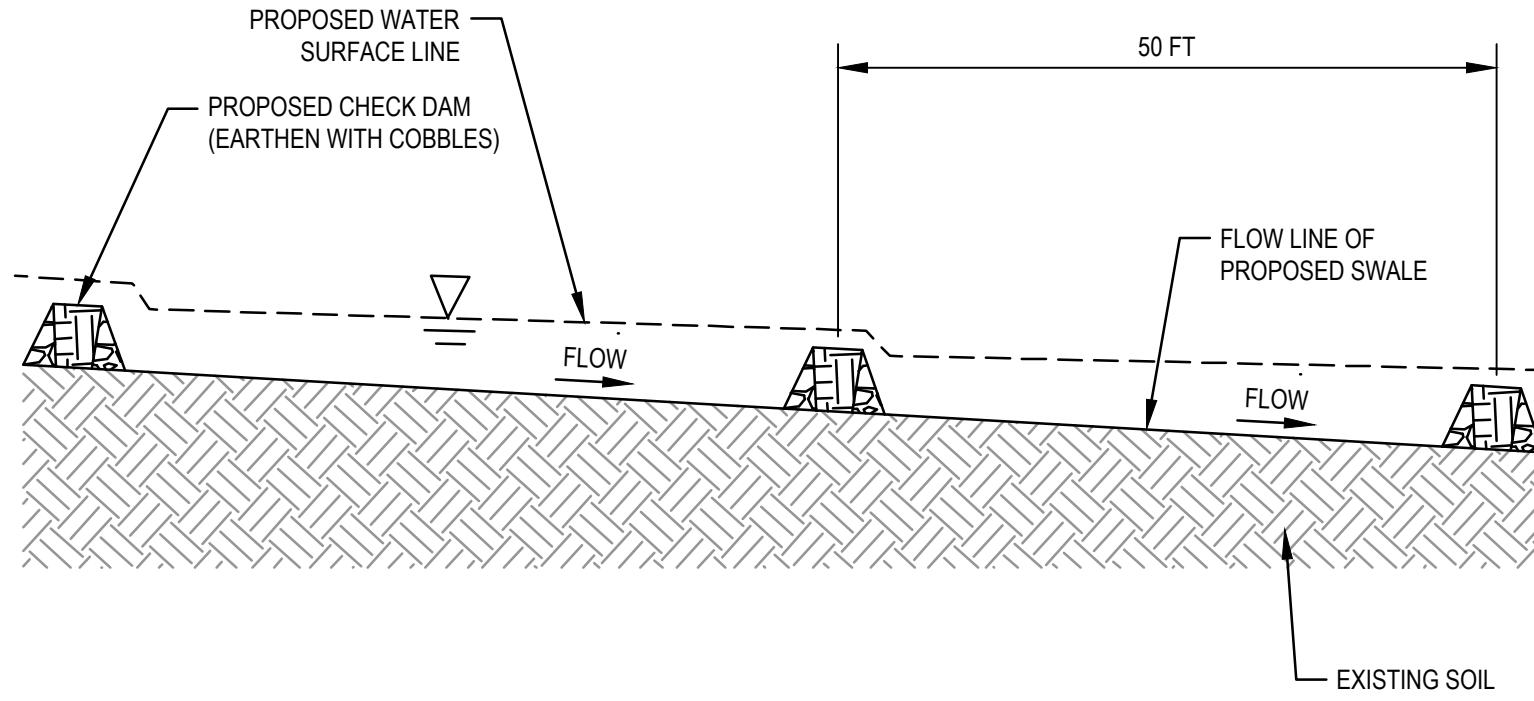


2 TYPICAL 5TH STREET BIOSWALE SECTION  
NTS

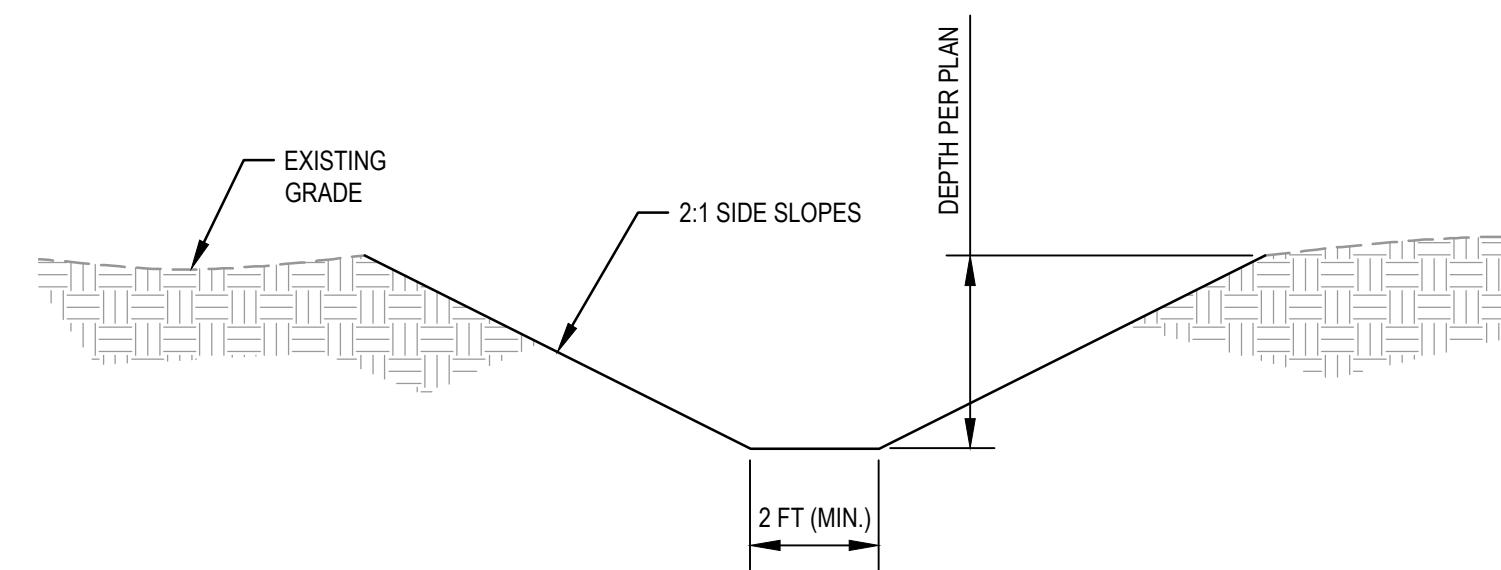


3 SHALLOW BIOSWALE SECTION  
NTS

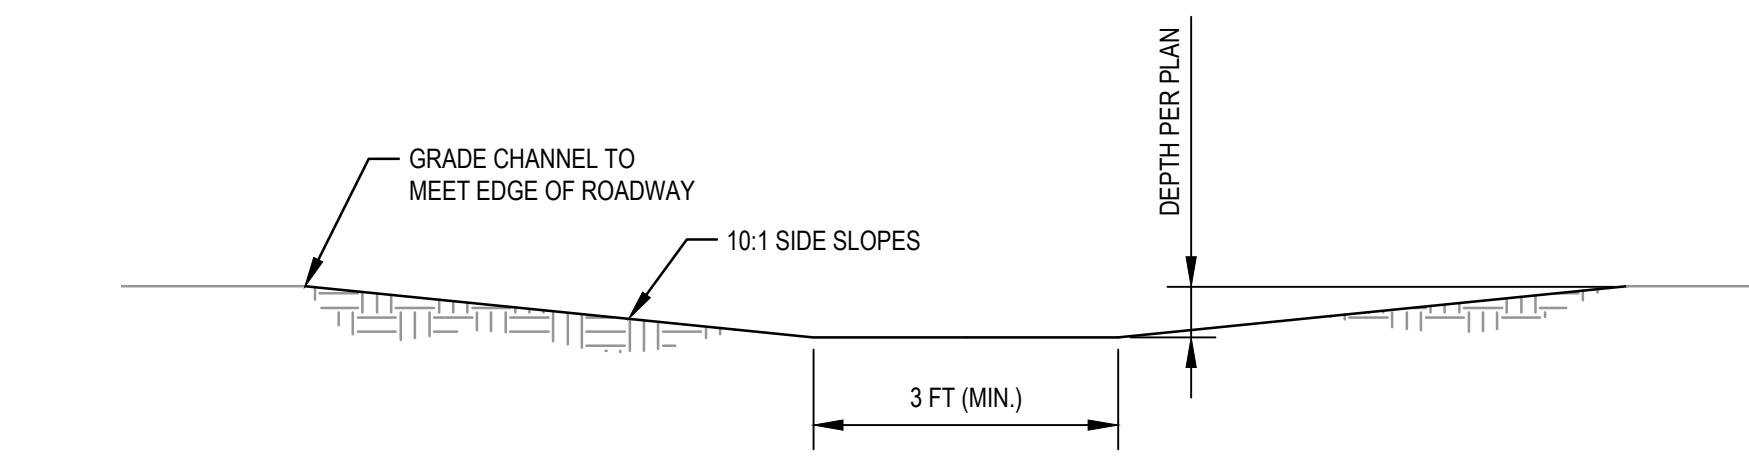

4 VEGETATED STORMWATER CURB EXTENTION  
NTS

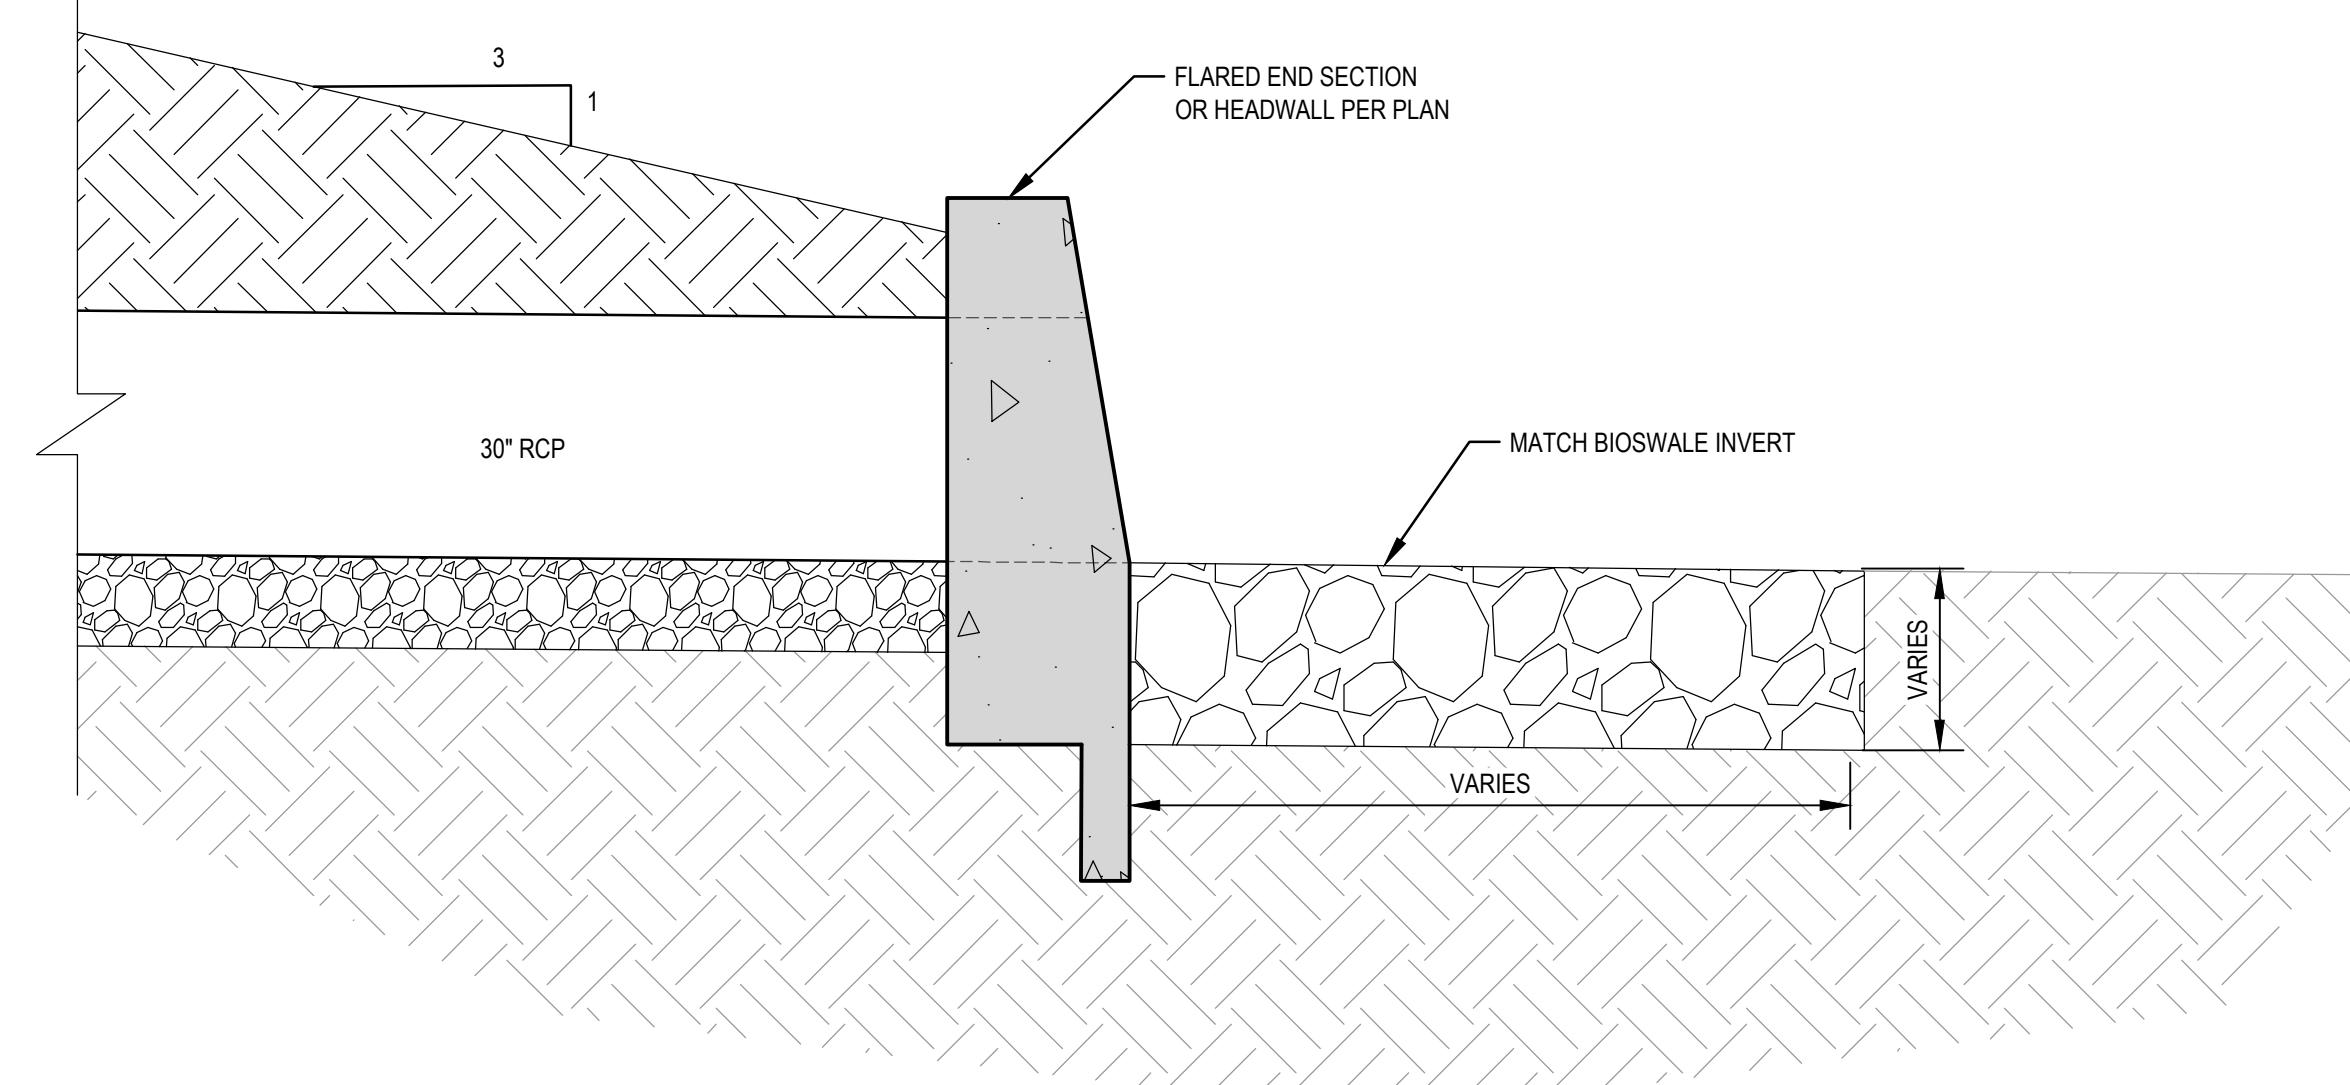

5 RIPRAP DETAIL  
NTS

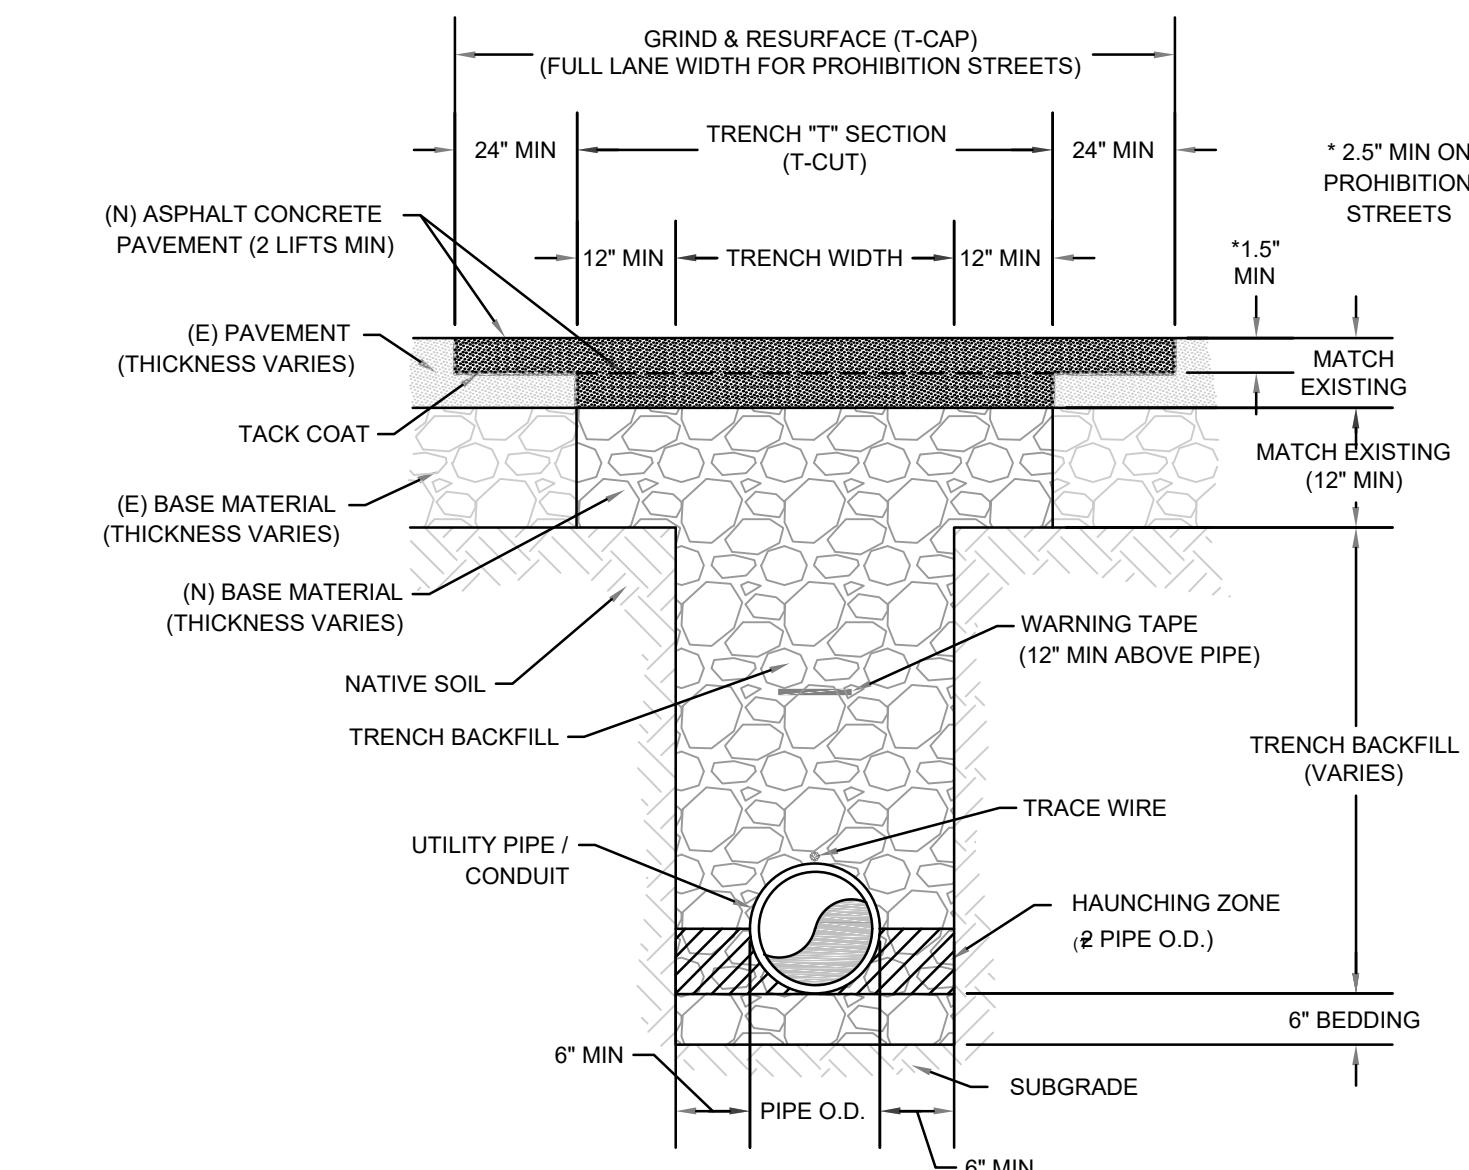


6 TYPICAL TRENCH  
NTS

No.	Issue	Checked	Approved	Date
Author	Drafting Check	BRETT VIVIAN	Project Manager	BRETT VIVIAN
Designer	TAYLOR ALLEN	Design Check	BRETT VIVIAN	Project Director



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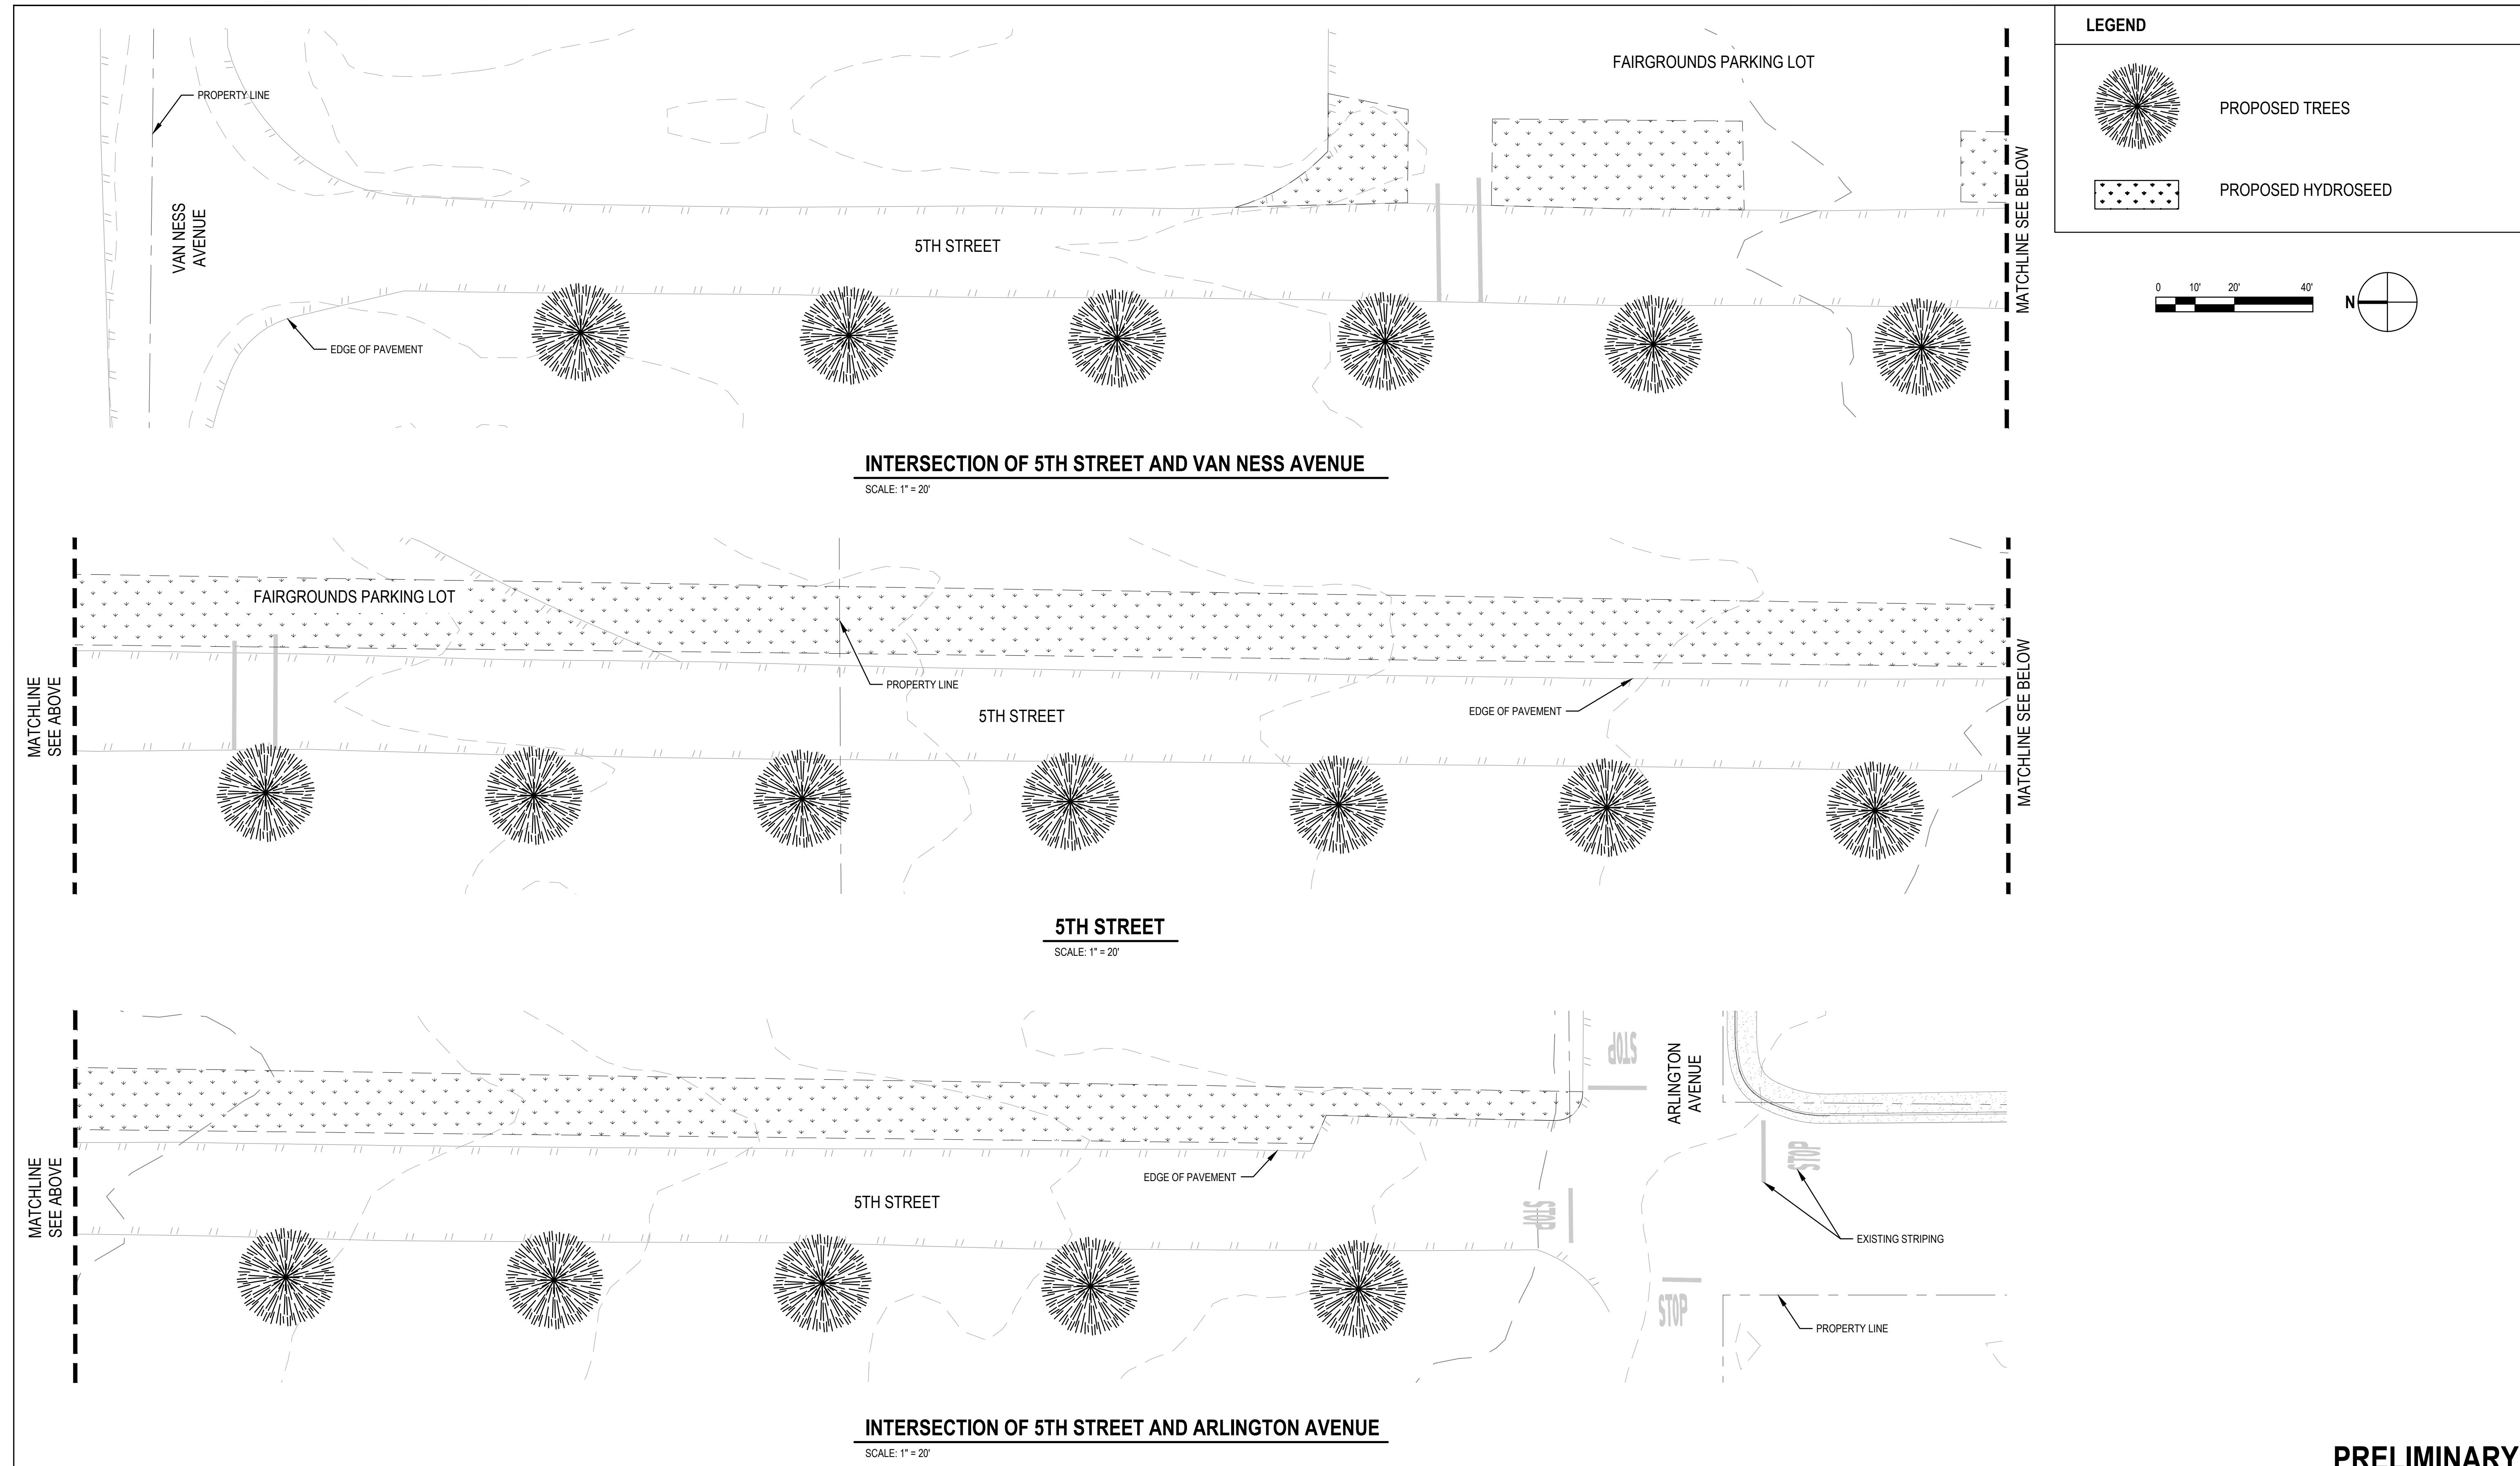


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Client CITY OF FERNDALE  
Project WATER QUALITY AND DRAINAGE  
IMPROVEMENTS PROJECT  
Project No. 12561178 Date 2024-09-12 Scale AS SHOWN

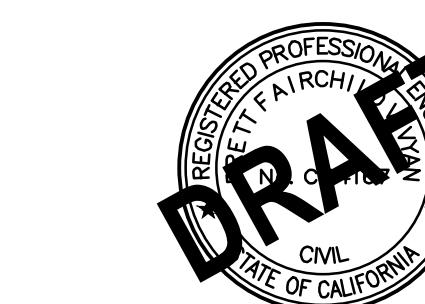Title TYPICAL SECTIONS AND DETAILS  
Size ANSI D  
Sheet No. C-301  
Sheet 12 of 13



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Author	Drafting Check	BRETT VIVIAN	Project Manager	BRETT VIVIAN
Designer	TAYLOR ALLEN	Design Check	BRETT VIVIAN	Project Director



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Client CITY OF FERNDALE

Project WATER QUALITY AND DRAINAGE  
IMPROVEMENTS PROJECT

Project No.  
12561178

Date  
2024-09-12

Scale  
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Title LANDSCAPE PLAN

Size  
ANSI D

PRELIMINARY

Sheet No.  
L-101  
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