#### **FUNDING SOURCE**

THIS PROJECT IS FUNDED BY THE US DEPARTMENT OF TRANSPORTATION, FEDERAL HIGHWAY ADMINISTRATION EMERGENCY RELIEF PROGRAM



	ORIGINAL DRAWING	RUAD NO:		
	ORIGINAL DRAWING	PROJECT NO		
	(A)	CONTRACT		
	IF NOT ONE INCH ON THIS SHEET, ADJUST	DRAWING FIL		
	SCALES ACCORDINGLY	PLOT DATE:		
- 1				

ROAD NAME: BLUE SLIDE ROAD

	DESIGN SI	F C. I II JIV		
ROAD NO:	ENGINEERING			
PROJECT NO.:	DESIGNED BY:	ENGR		
CONTRACT NO.	DRAWN BY:	ENGR		
DRAWING FILE	REVIEWED BY:	JAB		
PLOT DATE: 1/	/29/2020	REVISION DATE:	APPROVED BY:	AR\$

BLUE SLIDE RD PM 3.24 STORM DAMAGE REPAIRS

COVER SHEET,
SHEET INDEX AND DETAILS

OF


7

COUNTY OF HUMBOLDT DEPARTMENT OF PUBLIC WORKS

COUNTY OF HUMBOLDT DEPARTMENT OF PUBLIC WORKS

PROJECT PLANS FOR CONSTRUCTION OF STORM DAMAGE REPAIRS ON BLUE SLIDE ROAD (2G100) PM 3.24 PROJECT NO. ER-32L0(528) CONTRACT NO. 217446



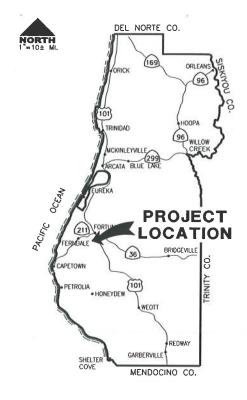

SCALE: 1"=10± MILE

## INDEX OF SHEETS

1 COVER SHEET

CONSTRUCTION AREA SIGNS, QUANTITIES, AND DETAILS

3 STOCKPILE LOCATIONS AND DETAILS

TYPICAL SECTIONS AND DETAILS

5 PLAN AND PROFILE

6-7 CROSS SECTIONS


## NOTES

REFERENCE TO CALTRANS STANDARD PLANS DATED JULY 2018. (SEE APPLICABLE STAN PLAN LIST IN SPECIAL PROVISIONS)

THE CONTRACTOR SHALL HAVE A CLASS "A" LICENSE FOR THIS PROJECT.

## **DESIGN DESIGNATION**

ADT (FEB '09)=320 V=(NOT POSTED)

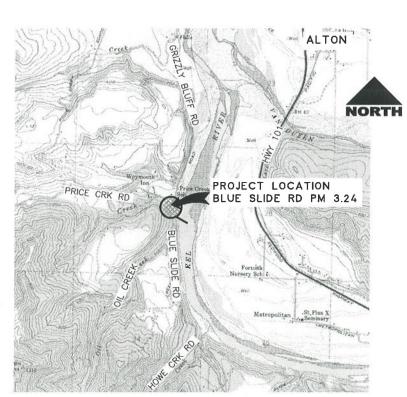

PROJECT VICINITY MAP

NOT TO SCALE

RECOMMENDED

JEFFREY ALBALL RCE 70630, EXP 6/30/2021

1-29-2026 DATE



**APPROVED** 

TONY/R. SEGHETTI/ RCE 63714, EKP. 9/30/2020 PROFESSIONAL REGISTRATION OF CALLED

GINAL LOW BID PRICE | CONSTRUCTED BY | RESIDENT ENGINEER | PROJECT COMPLETED | / CONSTRUCTION COST \$



BLUE SLIDE RD PM 3.24 STORM DAMAGE REPAIRS

SURVEY CONTROL AND DETAILS

COUNTY OF HUMBOLDT DEPARTMENT OF PUBLIC WORKS SHEET 2 OF CONSTRUCTION AREA SIGNS, QUANTITIES, 7



#### SURVEY CONTROL COORDINATES


POINT #	NORTHING	EASTING	ELEV	FULL DESCRIPTION
1	2083155.54	5960347.01	72.09'	set80dspike
2	2082960.65	5960300.91	78.86	set80dspike
3	2082644.51	5960126.31	99.74	set80dspike
9	2082924.37	5960272.03	79.97'	set80dspike+shnrorangeflag
10	2082803.47	5960183.30	86.79'	set80dspike+shnrorangeflag
11	2082924.89	5960421,30	66.42'	set80dspike+shnrorangeflag

BASIS OF BEARINGS BETWEEN CP 8 & CP 7 WITH G.P.S. AND OPUS SOLUTIONS. HELD CP 8 TO CP 7, N 10' 46' 34" E WITH AN ELEV 253.44 ON CP8 (NAVD88 (COMPUTED USING GEOID12)) CA STATE PLANE COORDINATES TO OBTAIN GEODETIC (TRUE) NORTH ROTATE BEARINGS COUNTER-CLOCKWISE 1' 24' 54" ON CP8 AND MULTIPLY ALL DISTANCES BY 1.00009768 TO OBTAIN GROUND DISTANCES. T. 2N., R. 1 W., SECTION 27 H.B.& M.

RIGHT OF WAY NOTE: ROAD REGISTER 1, # 136, PAGE 222. GRIZZLY BLUFF AND CAMP GRANT ROAD 1876. WIDTH OF ROAD 50 FEET. SEE BOOK 2 MAPS PAGE 54 OIL CREEK SHOWN ON MAP.

#### PROJECT LAYOUT

DESCRIPTION	NORTHING	EASTING
B.O.P 3+00 CONFORM	2082879.28	5960239.26
BEGIN WALL-TOE AT FACE	2082899.43	5960272.99
END WALL-TOE AT FACE	2082956.97	5960301.01
E.O.P 4+30 CONFORM	2082996.16	5960296.19

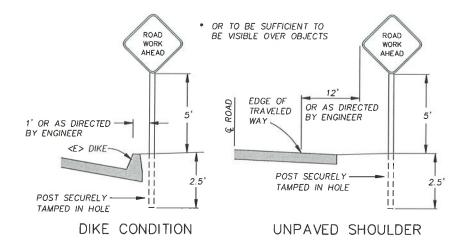

# **RURAL CONSTRUCTION AREA SIGN**

- NOT TO SCALE -

## QUANTITIES


NO. CODE			ITEM DESCRIPTION	UNIT	QUANTITY	
1	120090		Construction Area Signs	EA	8	
2	120100		Traffic Control System	LS	1	
3	129000		Temporary Railing (Type K)	EA	11	
4	130100		Job Site Management	LS	1	
5	130200		Prepare Water Pollution Contol Program	LS	1	
6	130680		Temporary Silt Fence	LF	100	
7	170103		Clearing and Grubbing (LS)	LS	1	
8	190101		Roadway Excavation	CY	64	
9	192037	F	Structure Excavation	CY	670	
10	193002		Structure Backfill (Wire Wall)	CY	335	
11	198050		Embank <i>m</i> ent	CY	280	
12	210350		Fiber Rolls	LF	100	
13	210212		Dry Seed	SQFT	800	
14	260303		Class 3 Aggregate Base	CY	100	
15	390132		Hot Mix Asphalt (Type A)	TON	70	
16	394073		Hot Mix Asphalt Dike (Type A)	LF	130	
17	477020	F	Mechanically Stabilized Embankment (Wire Wall)	SQFT	1,024	
18	680902		6" Perforated Plastic Pipe Underdrain	LF	70	
19	680903		6" Non-Perforated Plastic Pipe Underdrain	LF	30	
20	682022	F	Class 1 Permeable Material (Blanket)	CY	125	
21	832002		Metal Beam Guard Railing (Steel Posts)	LF	38	
22	839585		Alternative Flared Terminal System	EA	2	
23	999990		Mobilization	LS	1	

## NOTES

- 1) SIGNS SHALL BE PLACED AS SHOWN ON PLAN OR AS DIRECTED BY THE ENGINEER.
- 2) FINAL PLACEMENT OF SIGNS SHALL BE APPROVED BY RESIDENT ENGINEER.
- ADDITIONAL PORTABLE SIGNS SHALL BE USED AS REQUIRED FOR OTHER ROADSIDE WORK.
- 4) SEE STANDARD PLAN T13 FOR TRAFFIC CONTROL SYSTEM.
- IN ADDITION TO CONSTRUCTION AREA SIGNS AND WHEN DIRECTED BY THE RESIDENT ENGINEER, THE CONTRACTOR SHALL UTILIZE FLAGMEN AS NECESSARY TO DIRECT TRAFFIC.
- DISTANCE TO W20-1 AND G20-2 MAY BE EXTENDED TO ENCOMPASS SITES WITHIN ONE MILE OF EACH OTHER.

## CONSTRUCTION AREA SIGN SUMMARY

SIGN TYPE	QTY	DESCRIPTION	SIZE	REMARKS	POST SIZE	NUMBER
W20-1	2	ROAD WORK AHEAD	36" × 36"	VISIBLE AT ALL TIMES	4" x 4"	1
W3-1 W16-2	2	STOP AHEAD 500 FT	36 × 36 24" × 18"	VISIBLE AT ALL TIMES	4 x 4	1
R1 R-SPECIAL	2	STOP PROCEED WHEN CLEAR	30" × 30" 24" × 18"	VISIBLE AT ALL TIMES	4 × 4	1
G20-2	2	END ROAD WORK	36" x 18"	VISIBLE AT ALL TIMES	4 x 4	1

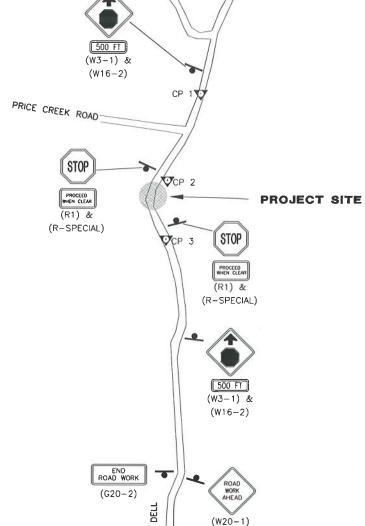

NORTH

ROAD WORK AHEAD


(W20-1)

END ROAD WORK (G20-2)

# TRAFFIC CONTROL PLAN

1"=200'±

RIO 2

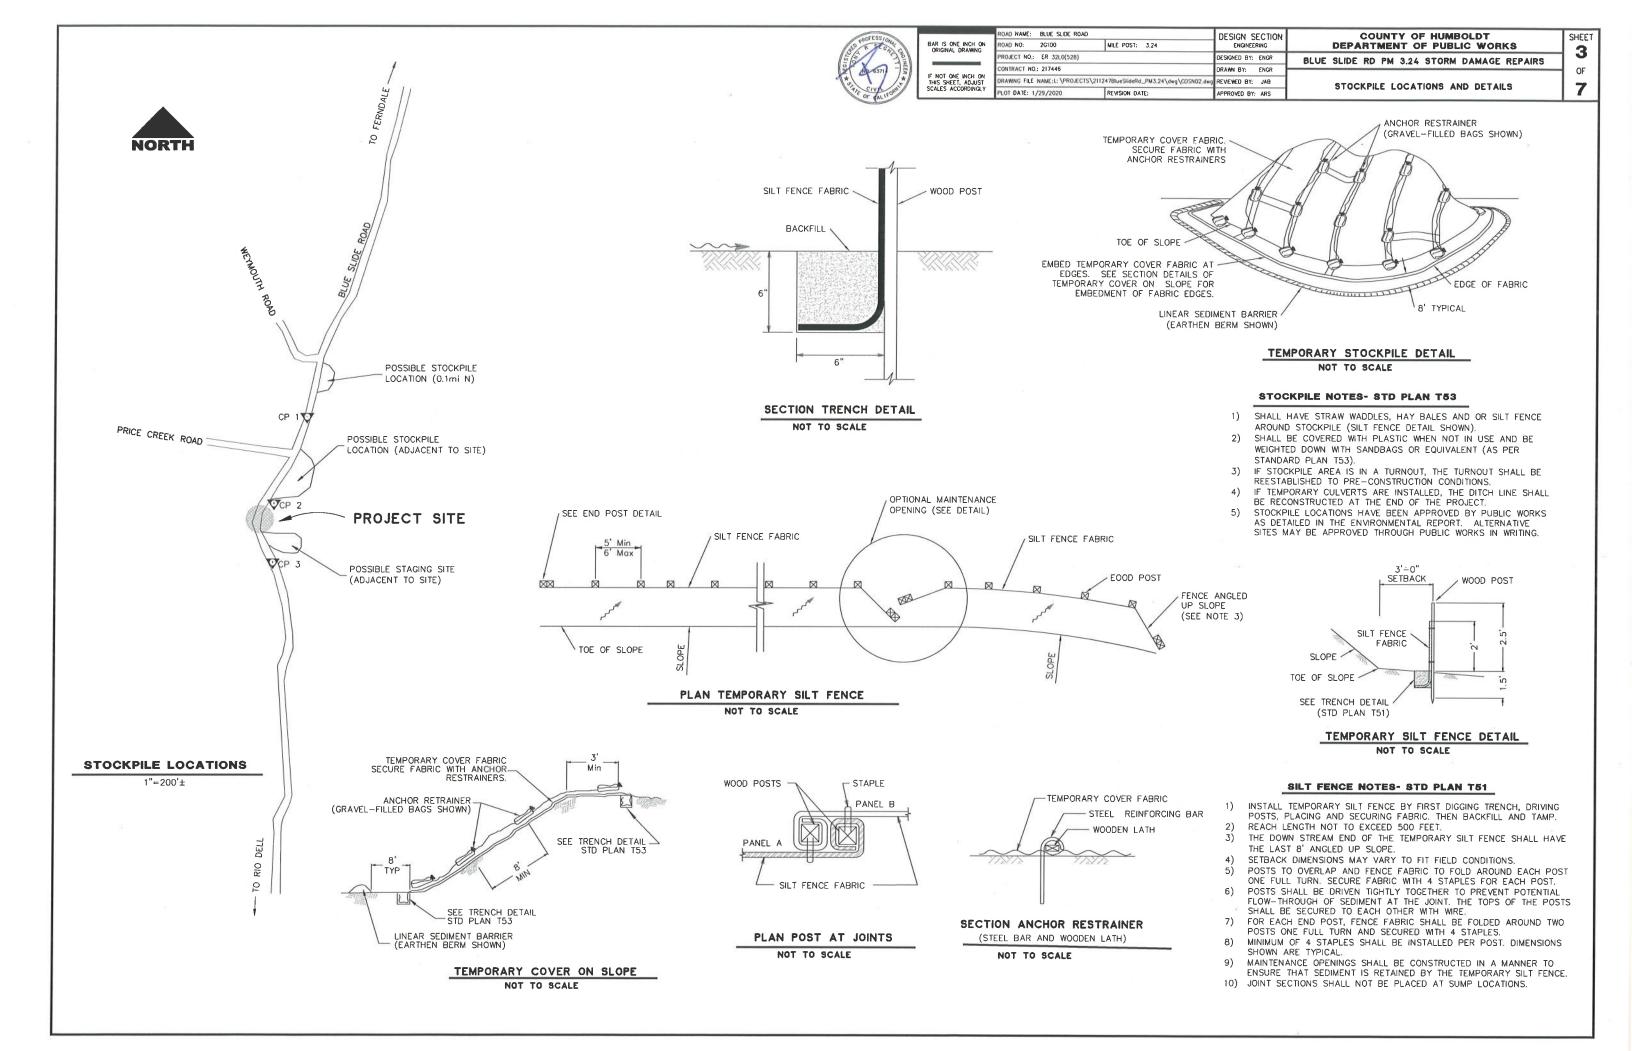



	R				
BAR IS ONE INCH ON					
ORIGINAL DRAWING					
	Ç				
IF NOT ONE INCH ON					


UNU NAME:	BLUE STIDE KON	DESIGN SECTION				
OAD NO:	2G100	ENGINEERING				
ROJECT NO.:	ER 32L0(528)	DESIGNED BY: ENGR				
ONTRACT NO	: 217446	DRAWN BY: ENGR				
RAWING FILE	NAME: L: \PROJECTS	REVIEWED BY: JAB				
LOT DATE: 1,	/29/2020	REVISION DATE:	APPROVED BY: ARS			


COUNTY OF HUMBOLDT DEPARTMENT OF PUBLIC WORKS

4 BLUE SLIDE RD PM 3.24 STORM DAMAGE REPAIRS OF 7

SHEET


TYPICAL SECTIONS AND DETAILS

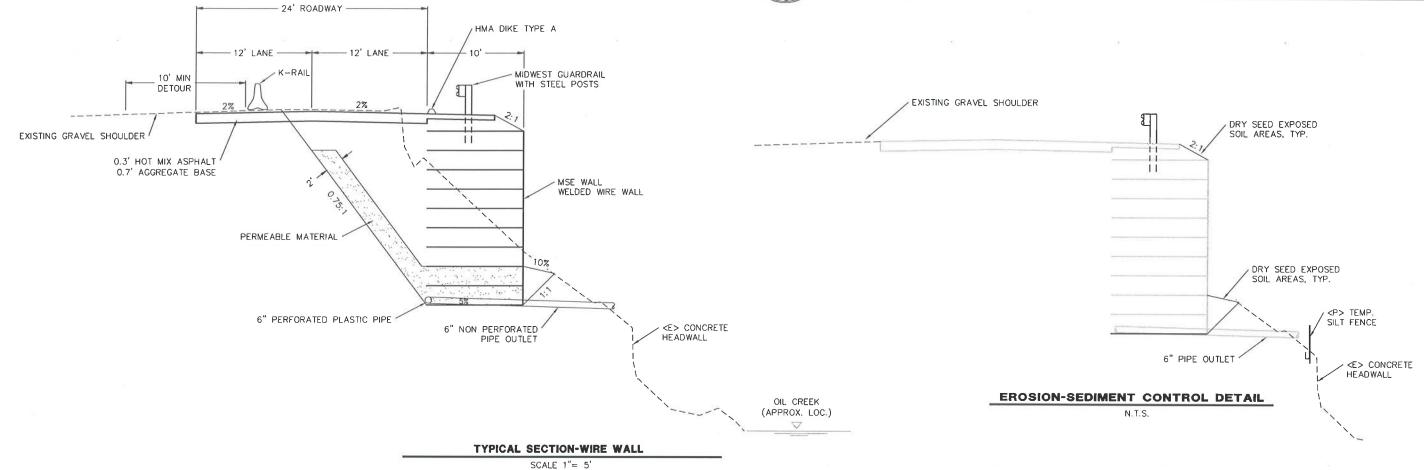

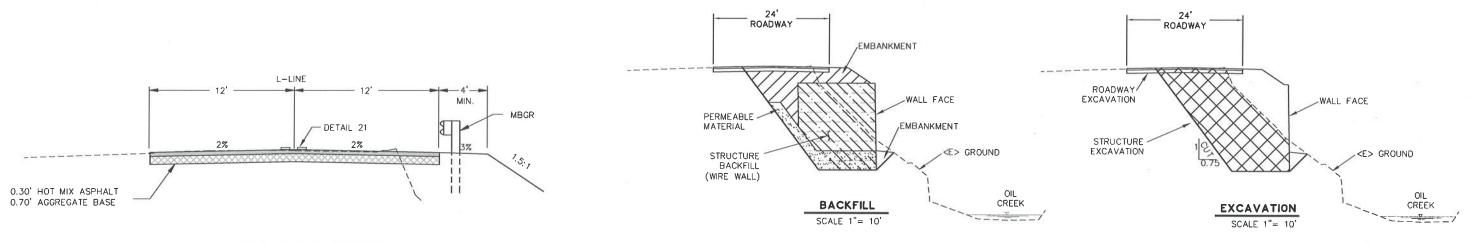

TYPICAL ROAD SECTION SCALE 1"=5"

WELDED WIRE WALL EXCAVATION & BACKFILL LIMITS

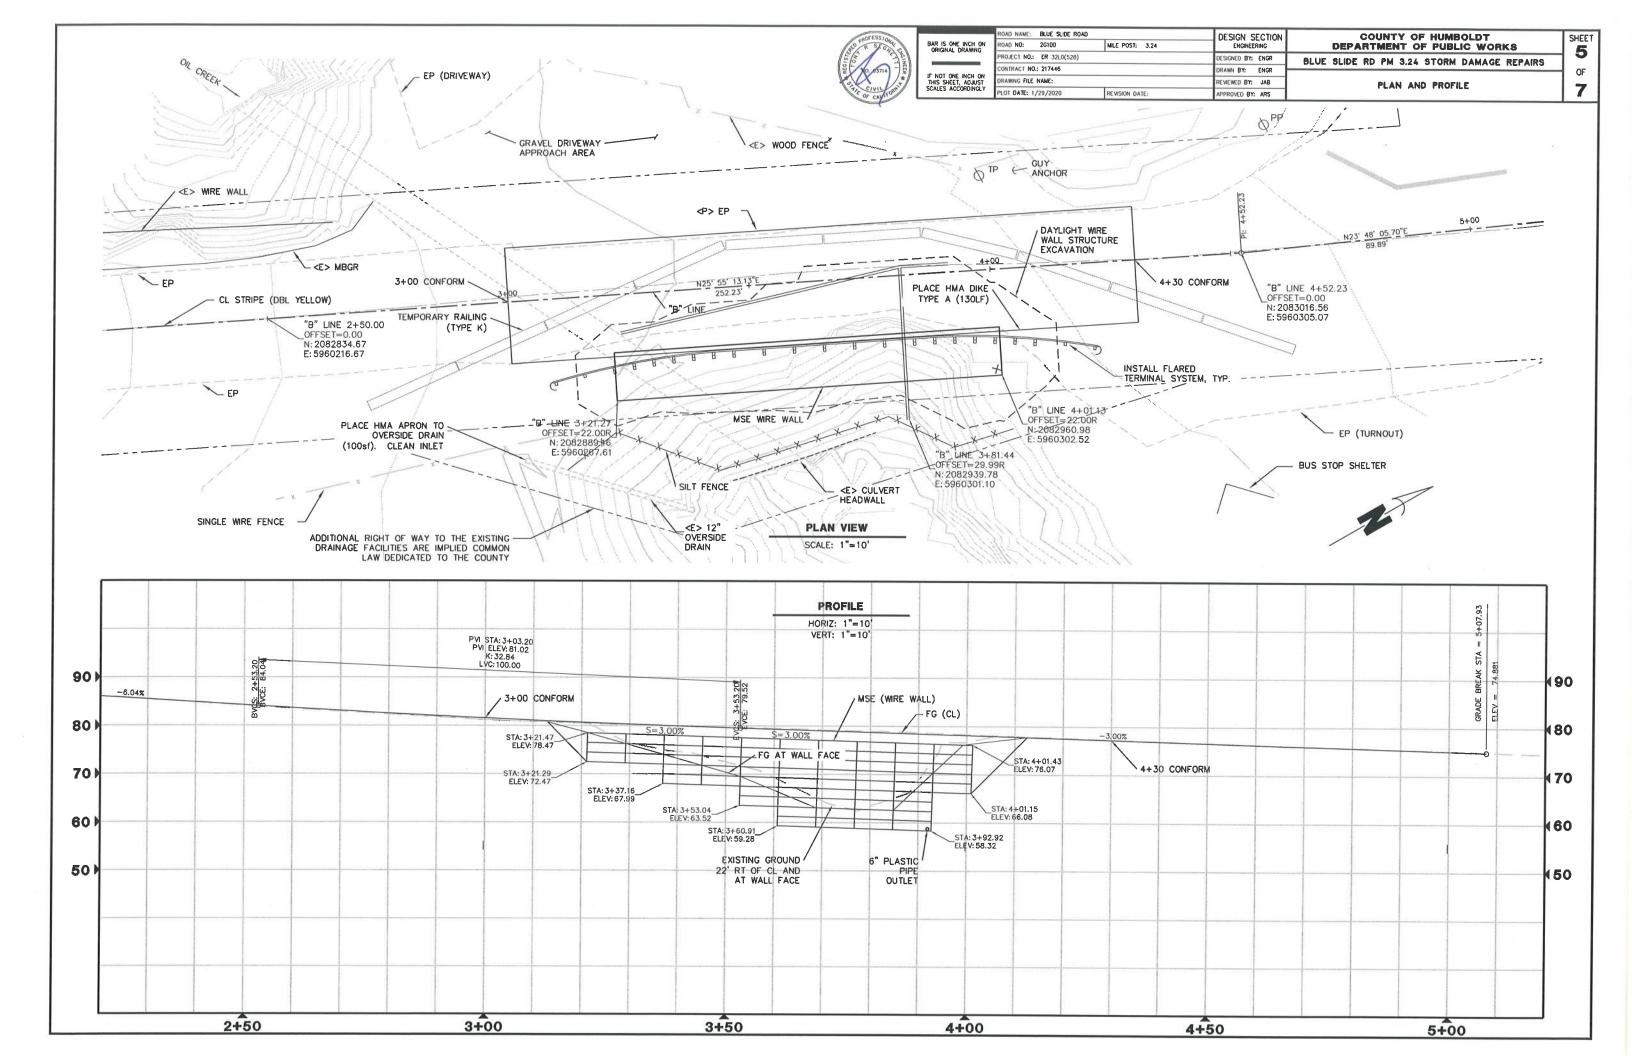



BAR IS ONE INCH ON PRICE OF THE PRICE OF THE

BLUE SLIDE RD PM 3.24 STORM DAMAGE REPAIRS

CROSS SECTIONS


COUNTY OF HUMBOLDT DEPARTMENT OF PUBLIC WORKS


6 or 7


SHEET


## **CROSS SECTIONS**


HORIZ: 1"= 10' VERT: 1"= 10'

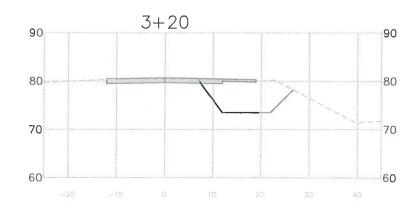


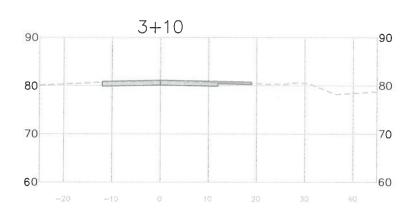


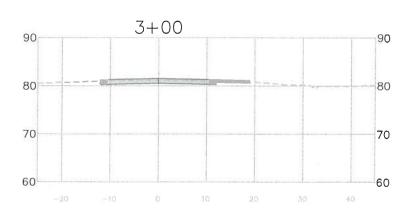

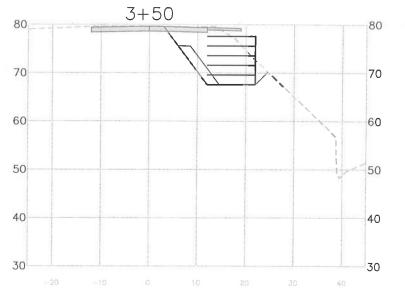

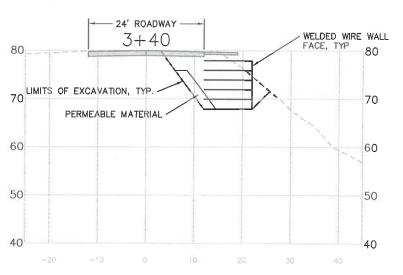

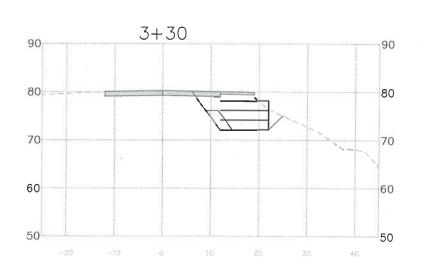

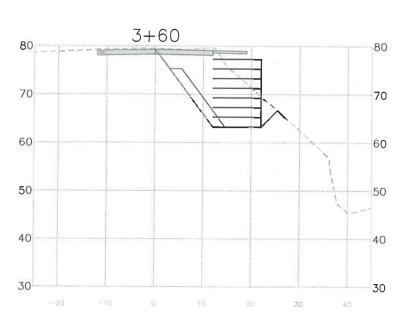




AD NAME: BLUE SLIDE ROAD		DESIGN SECTION		COUNTY OF HUMBOLDT						SHEET	
AD NO: 2G100	MILE POST: 3.24	ENGINEER		DEPARTMENT OF PUBLIC WORKS						SHEET	
OJECT NO.: ER 32L0(528)	DESIGNED BY:	ENGR	BLUE	SLIDE I	RD PM	3.24	4 STORM DAMAGE REPAIRS			ı	
NTRACT NO.: 217446	DRAWN BY:	ENGR			10 1 10		TOTAL DAMAGE INC. AIRC	-	OF	ı	
AWING FILE NAME: L: PROJECTS\2112	REVIEWED BY:	JAB	CROSS SECTIONS						_		
OT DATE: 1/29/2020	ADDROVED BY	ADC	- CNOSS SECTIONS					- 1	7	ı	


OF 7



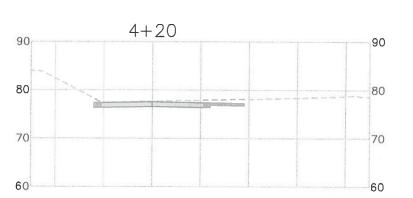



HORIZ: 1"= 10' VERT: 1"= 10'

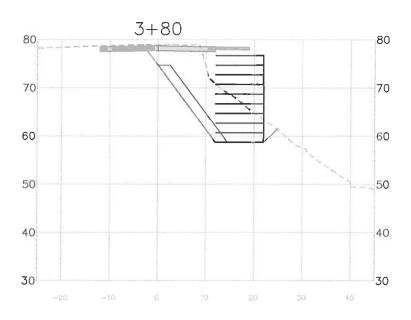

3+90

70

60

50

