

NOT TO SCALE

AGGREGATE BASE

AMERICANS WITH

DISABILITIES ACT

BACK OF CURB

BACK OF WALK

CURB AND GUTTER

CENTERLINE OR CLASS

BARBED WIRE

OR CHAINLINK

CONCRETE

CLEANOUT

DRAWING

DRIVEWAY

ELEVATION

FXISTING

FLOWLINE

ELBOW (PIPE)

FINISHED FLOOR FINISHED GRADE

FORCE MAIN (SS)

EXISTING GRADE

EDGE OF PÁVEMENT

CURB RAMP DRAIN INLET

CLEAR

BACK FLOW PREVENTOR

BEGIN

BEG

BFP

BOC

BOW BW CONC

C&G

CLR

CG CO CR DI

DWG

ELL

EXIST

EL/ELEV

	ROAD NAME: CONSERVATION CAMP RD		HUMCO	COUNTY OF HUMBOLDT	SHEET	i
BAR IS ONE INCH ON ORIGINAL DRAWING	ROAD NO:	MILE POST:		DEPARTMENT OF PUBLIC WORKS	4	i
	PROJECT NO.: 438005		DESIGNED BY: ENGR	REDWAY TRANSFER STATION	ı	i
			DRAWN BY: PBS		OF	i
SCALES ACCORDINGLY	DRAWING FILE NAME: FRIES_DIEDEAILS AND	CROSS SECTIONS	REVIEWED BY: JAB	TITLE SHEET	58	i
	PLOT DATE: 08/19/25		APPROVED BY: TRS		၁၀	i

# COUNTY OF HUMBOLDT DEPARTMENT OF PUBLIC WORKS

PROJECT PLANS FOR CONSTRUCTION OF REDWAY TRANSFER STATION IMPROVEMENTS

PROJECT No. 438005

TO BE SUPPLEMENTED BY STATE OF CALIFORNIA DEPARTMENT OF TRANSPORTATION
STANDARD PLANS, STANDARD SPECIFICATIONS, LATEST REVISED 2023 STANDARD SPECIFICATIONS
AND LATEST 2022 CALIFORNIA BUILDING CODE; BUILDING, ELECTRICAL, PLUMBING, MECHANICAL, FIRE, ENERGY,
AND CALIFORNIA GREEN BUILDING CODE



### NOTES

- THE CONTRACTOR SHALL HAVE A CLASS "B" LICENSE FOR CONSTRUCTION ON THIS PROJECT.
- 2. STANDARD PLANS LIST APPLICABLE TO THIS CONTRACT IS INCLUDED IN THE SPECIAL PROVISIONS.

### GEOTECH REPORT

PREPARED BY: CRAWFORD & ASSOCIATES, INC. REPORT DATED: JUNE. 28 2023

### SURVEY INFORMATION

PREPARED BY: HUMBOLDT COUNTY PUBLIC WORKS FIELD SURVEY COMPLETED: FEBRUARY 2025 PROJECT #438005

### INDEX OF SHEETS

1	TITLE SHEET	45	UTILITY PLAN
2	TRAFFIC CONTROL PLAN	46	WATER POLLUTION AND EROSION CONTROL PLAN
3	DEMOLITION PLAN	47-52	ELECTRICAL PLANS (E0.1-E4)
4	SITE PLAN	53-58	TITLE 24 - ENERGY COMPLIANCE
5-10	GRADING PLAN		

STANDARD ABBREVIATIONS

FOW FT

GB GFL GR GV

IRR LF LIP LP

MAX MH

MIN

MOD NTS OG OH PB PCC

**PVMT** 

FACE OF CURB

FACE OF WALK

FOOT (FEET)

GRADE BREAK

INLET GRATE

GATE VALVE

HIGH POINT

IRRIGATION

LOW POINT

MAXIMUM

MANHOLF

MINIMUM

MODIFIED

OVERHEAD

CONCRETE

PAVEMENT

NOT TO SCALE

PLAIN CEMEN

PROPERTY LINE

POWER POLE

ORIGINAL GROUND

LINEAR FEET

LIP OF GUTTER

GUTTER FLOWLINE

HUMBOLDT COUNTY

HOT MIX ASPHALT

11 "C" LINE - ROAD SECTION
12-15 "T" LINE - TRANSFER SECTION

16 "J" LINE AND JOINT TRENCH SECTION
17-19 STRIPING AND SIGN PLANS

20-21 ADA PARKING DETAILS

22-23 MANUFACTURE WEIGH SCALE FOUNDATION PLAN

24-27 TYPICAL CONSTRUCTION DETAILS

28-35 PROPOSED WEIGH STATION BUILDING PLANS

6-41 WEIGH STATION BUILDING STRUCTURAL PLANS (SO-S4)

42-43 EXISTING TRANSFER BUILDING REPAIRS AND INTERIOR DEMOLISH

44 PROPOSED RECYCLING BUILDING

Avoid cutting underground utility lines. It's costly.

before you

RADIAL POINT

RIGHT RIGHT OF WAY

SAWCUT LINE STORM DRAIN

SANITARY SEWER

TOP BACK OF WALK TOP OF CURB

TOP FACE OF CURB

TRAFFIC SIGNAL

UNDERGROUND

WATER METER

WATER VALVE

VARIES

VOLUME

SHFFT

STANDARD

SIDEWALK

STORM DRAIN MANHOLE

SQUARE FOOT, OR FEET

SANITARY SEWER CLEANOUT

TELECOMMUNICATION – TELEPHONE

VEE GUTTER/VALLEY GUTTER

SANITARY SEWER MANHOLE

R/W

SD SDMH SF


STD SW TBC

VG VOL

WM

WV

811 OR 800-642-2444 UNDERGROUND SERVICE (USA)

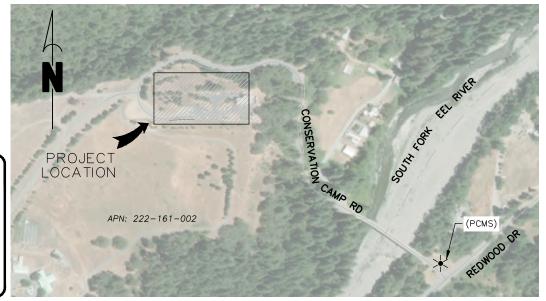




TONY SEGHETITI

JASON HICKEY RSE S5783, EXP. 05/29/2026 8/19/25 DATE



ORIGINAL LOW BID PRICE | CONSTRUCTED BY | RESIDENT ENGINEER | PROJECT COMPLETED / / CONSTRUCTION COST

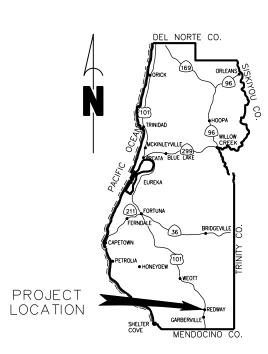

LOCATION MA


PREPARED BY: CRAWFORD &


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RCE 63714, EXP. 9/30/2026







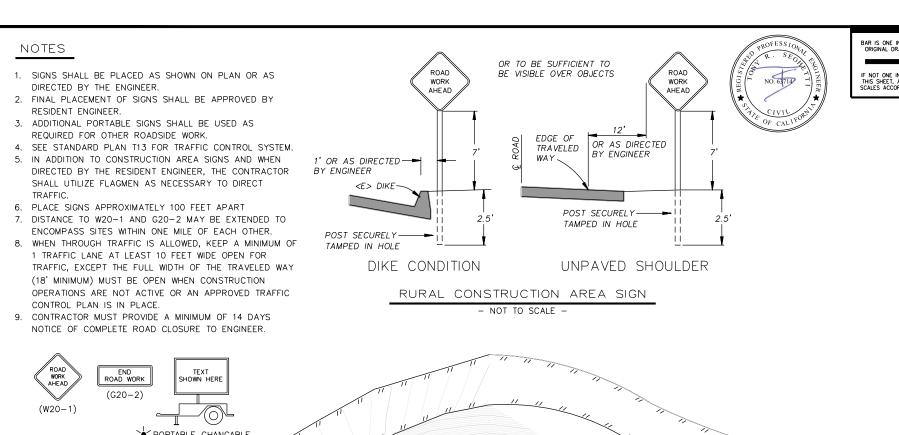
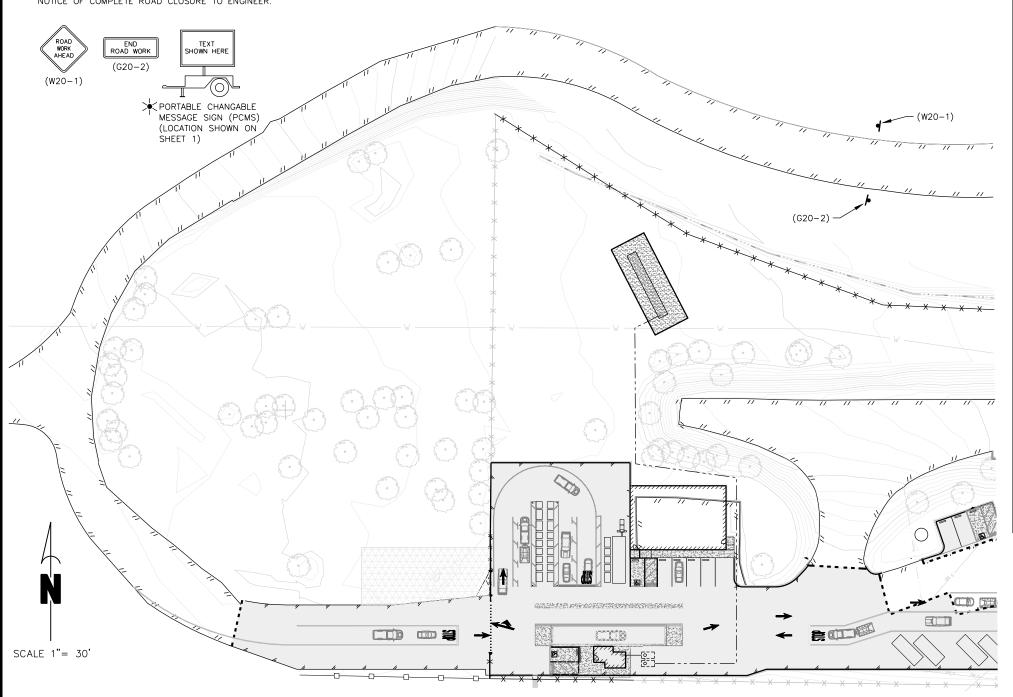
### QUANTITY SUMMARY

MILE POST:

OAD NO:

ROJECT NO.: 438005

LOT DATE: 08/19/25

DRAWING FILE NAME: RTS SITE PLAN

HUMCO

DESIGNED BY: ENGR

DRAWN BY: PBS

REVIEWED BY: JAB

APPROVED BY: TRS

ITEM No. ITEM CODE		ITEM DESCRIPTION	UNIT	QUANTITY	
	120100	TRAFFIC CONTROL SYSTEM	LS	1	
2	130100	JOB SITE MANAGEMENT	LS	1	
3	130201	WATER POLLUTION CONTROL PROGRAM	LS	1	
4	130620	TEMPORARY DRAINAGE INLET PROTECTION	EA	3	
5	130640	TEMPORARY FIBER ROLL	LF	50	
6	130680	TEMPORARY SILT FENCE	LF	320	
7	130900	TEMPORARY CONCRETE WASHOUT	LS	1	
8	153250	REMOVE GUARD SHELTER, SCALE, AND SCALE FOUNDATION	LS	1	
9	170103	CLEARING AND GRUBBING	LS	1	
10	190101	ROADWAY EXCAVATION	CY	1,227	
11	210212	DRY SEED	SQFT	3,150	
12	210420	STRAW	SQFT	3,150	
13	260203	CLASS 2 AGGREGATE BASE	CY	1,517	
14	390132	HOT MIX ASPHALT (TYPE A)	TON	608	
15	394073	PLACE HOT MIX ASPHALT DIKE (TYPE A)	LF	688	
16	398100	REMOVE ASPHALT CONCRETE DIKE	LF	742	
17	568064	4" SCH 80 STEEL PROTECTIVE BOLLARD	EA	20	
18	723095	ROCK SLOPE PROTECTION (20 LB, CLASS I, METHOD B) (CY)	CY	1	
19	731512	MINOR CONCRETE (PARKING, SIDEWALK, LANDING)	CY	36	
20	731513	731513 MINOR CONCRETE (VALLEY GUTTER)		5	
21	770100	WATERLINE SYSTEM	LS	1	
22	770200	WASTE WATER SYSTEM	LS	1	
23	780500	PARKING BUMPER (PRECAST CONCRETE)	EA	9	
24	800001	FENCE (TYPE BW, METAL POST)	LF	215	
25	800363	CHAIN LINK FENCE (TYPE CL-6 W/BW, EXTENSION ARM)	LF	684	
26	802675	36' SECURITY METAL SLIDING GATE	EA	1	
27	803030	REMOVE FENCE (TYPE CL W/BW)	LF	438	
28	803035	REMOVE FENCE (TYPE BW WOOD POST AND METAL T-POST)	LF	755	
29	820001	INSTALL SIGNS (STANDARD AND CUSTOM)	LS	1	
30	840501	THERMOPLASTIC TRAFFIC STRIPE	LF	1836	
31	840515	THERMOPLASTIC PAVEMENT MARKING	SF	260	
32	840651	PAINTED ADA PAVEMENT MARKINGS (ADA PARKING)	SF	93	
33	840665	PAINT ADA PARKING LINES (1-COAT) (ADA PARKING)(RED CAUTION LINE)	SF	161	
34	870100	ELECTRICAL AND LIGHTING SYSTEM	LS	1	
35	990100	FURNISH AND INSTALL 2400 SF METAL BUILDING (RECYCLING)	LS	1	
36	990200	FURNISH AND INSTALL 218 SF STICK FRAME BUILDING (WEIGH STATION)	LS	1	
37	990300	WEIGH SCALE (RICE LAKE - SURVIVOR OTR)	LS	1	
38	990400	REMOVE SCALE FACILITIES AND DEMOLITION, REPAIR, REPLACE DOORS EXISTING BUILDING (TRANSFER)	LS	1	
39	991000	FURNISH AND INSTALL PLUMBING FOR BUILDINGS	LS	1	
40	999990	MOBILIZATION	LS	1	

COUNTY OF HUMBOLDT

DEPARTMENT OF PUBLIC WORKS

REDWAY TRANSFER STATION

TRAFFIC CONTROL PLAN

SHEET


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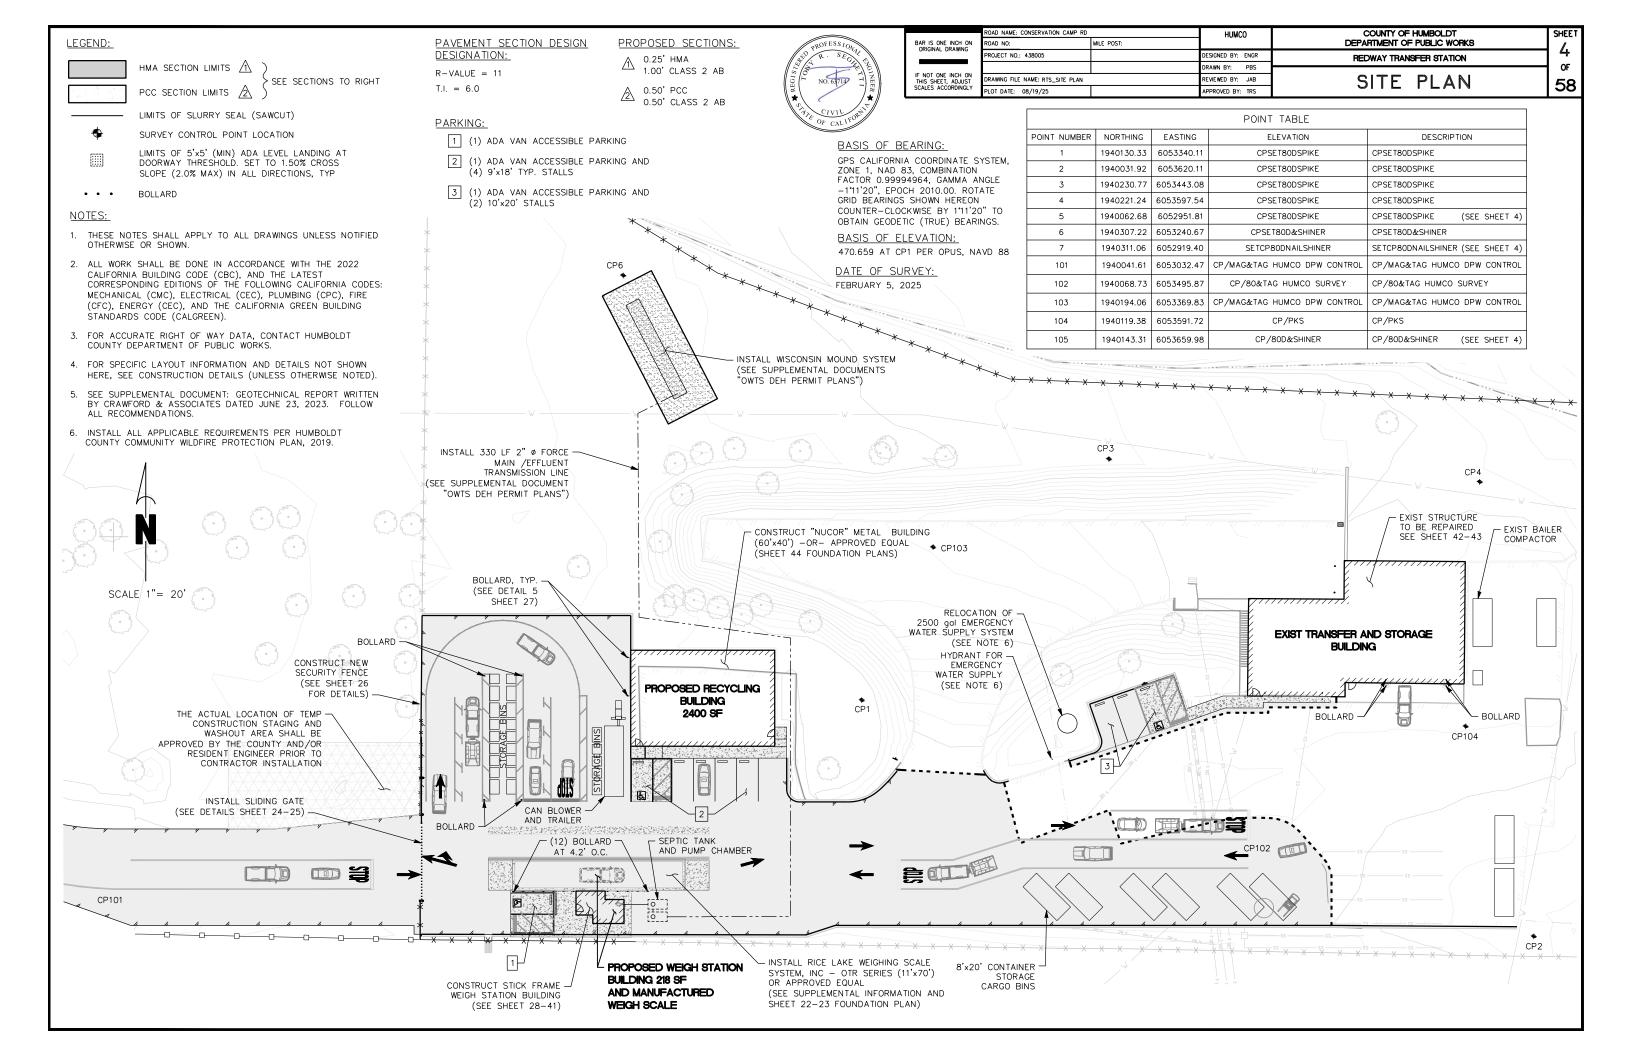
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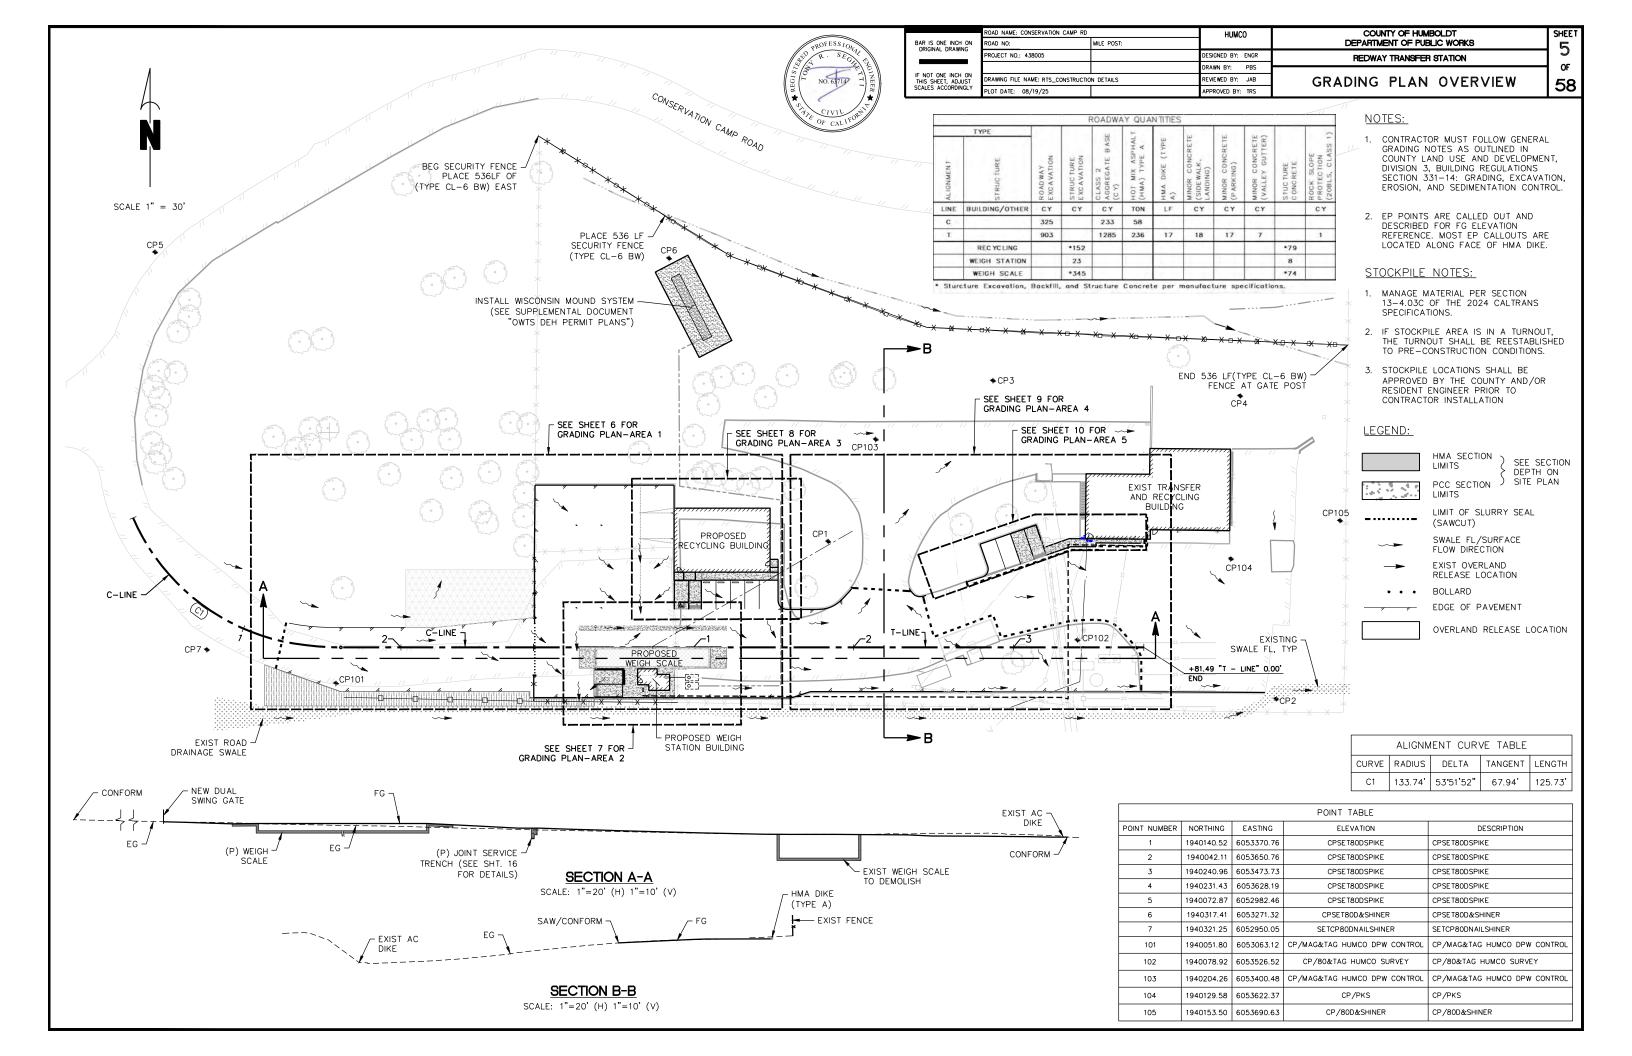
LITEM NO. CODE DESCRIPTION


- SPECIFICATION SECTION NUMBER WITHIN STATE
OF CALIFORNIA DEPARTMENT OF TRANSPORTATION
(CALTRANS) 2024 STANDARD SPECIFICATION


THE STATE OF CALIFORNIA DEPARTMENT OF TRANSPORTATION 2024 STANDARD SPECIFICATIONS AND 2024 STANDARD PLANS CAN BE FOUND AT HTTPS://DOT.CA.GOV/PROGRAMS/DESIGN/OCTOBER-2024-CCS-STANDARD-PLANS-AND-STANDARD-SPECIFICATIONS.







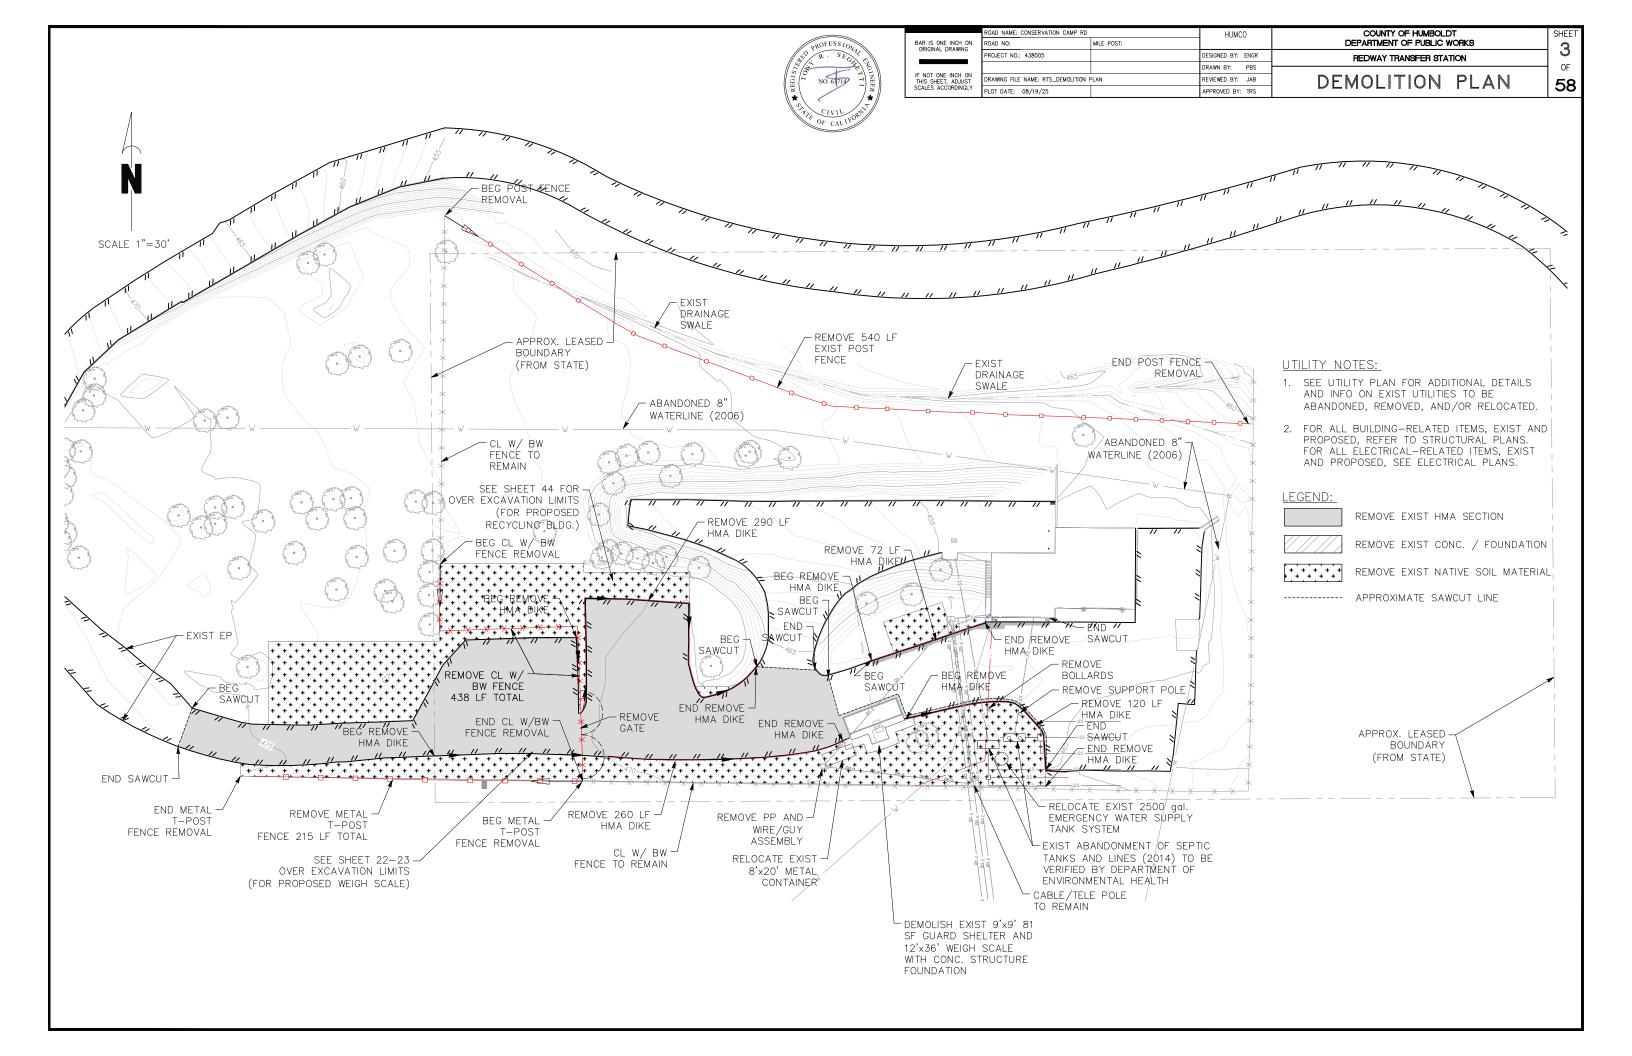


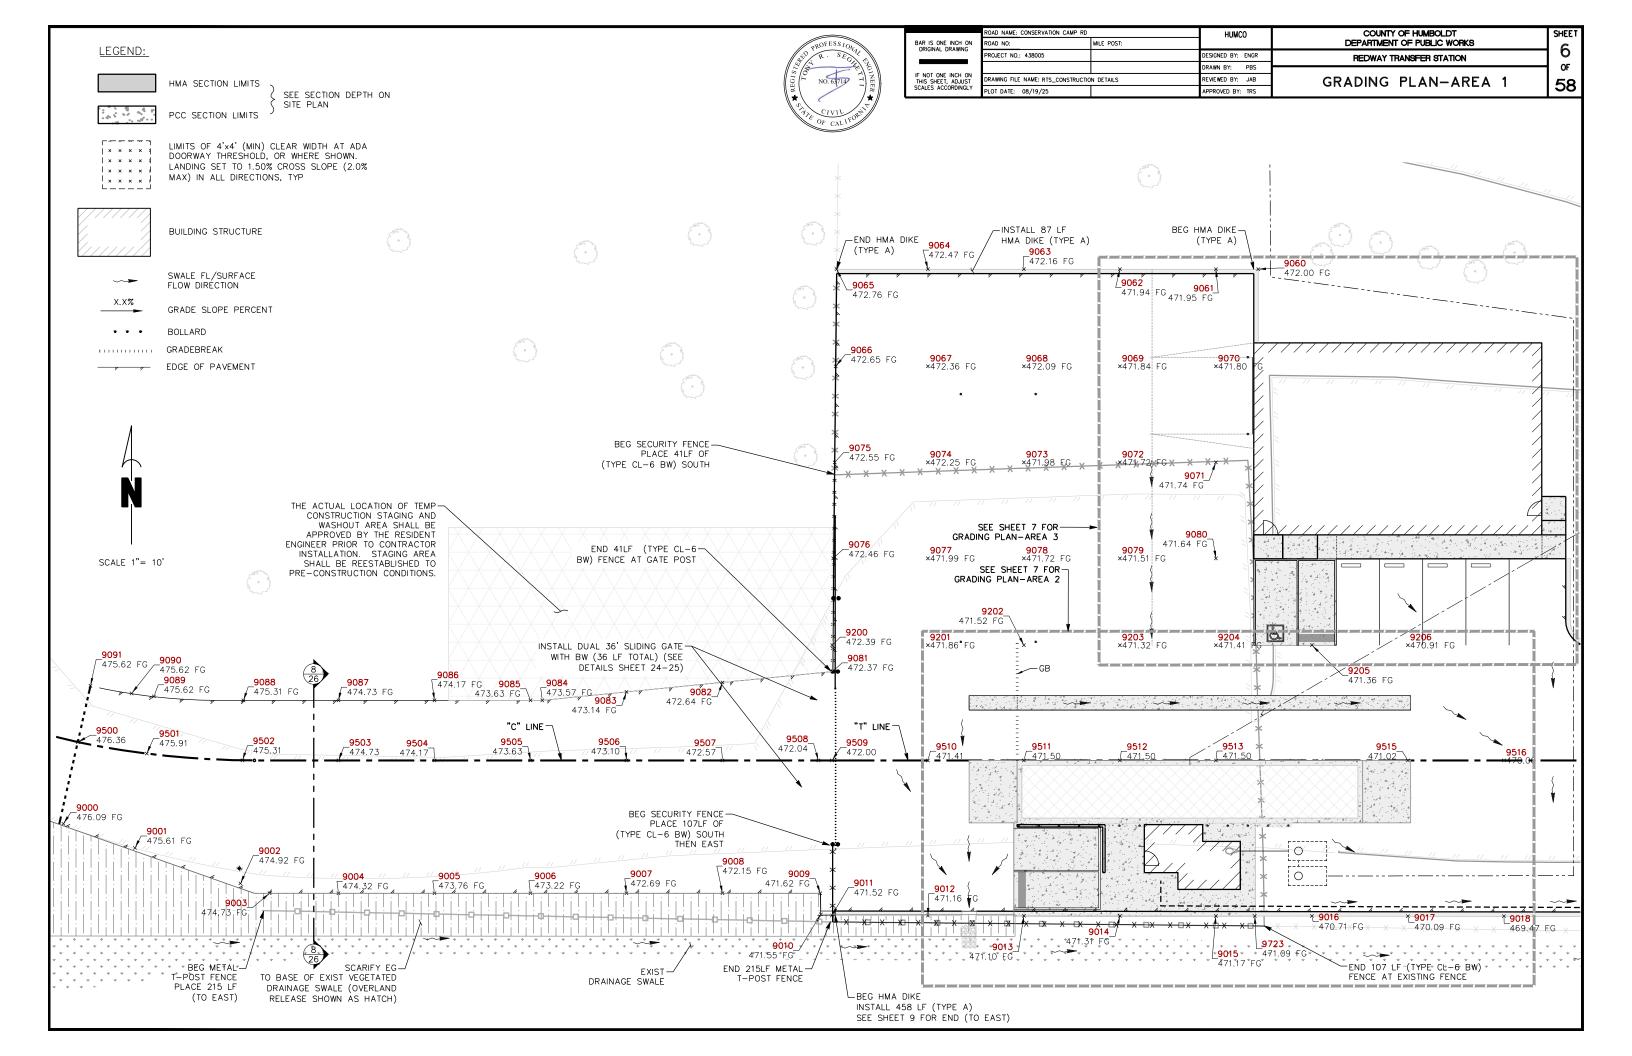


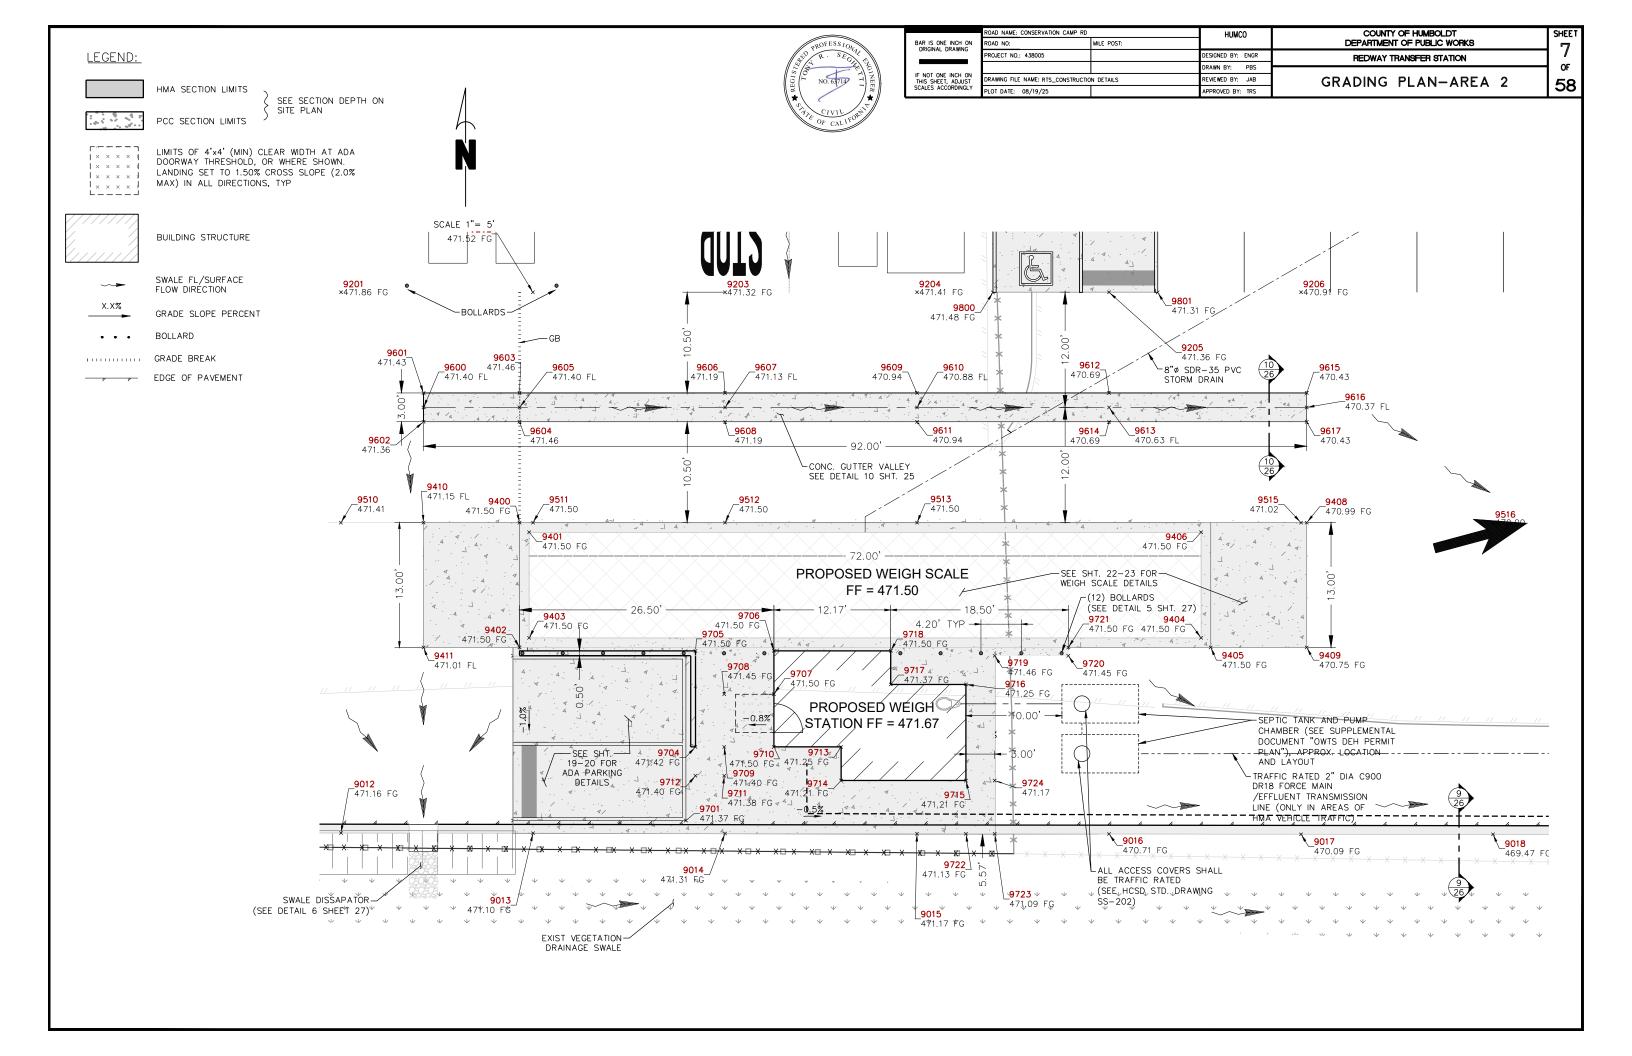


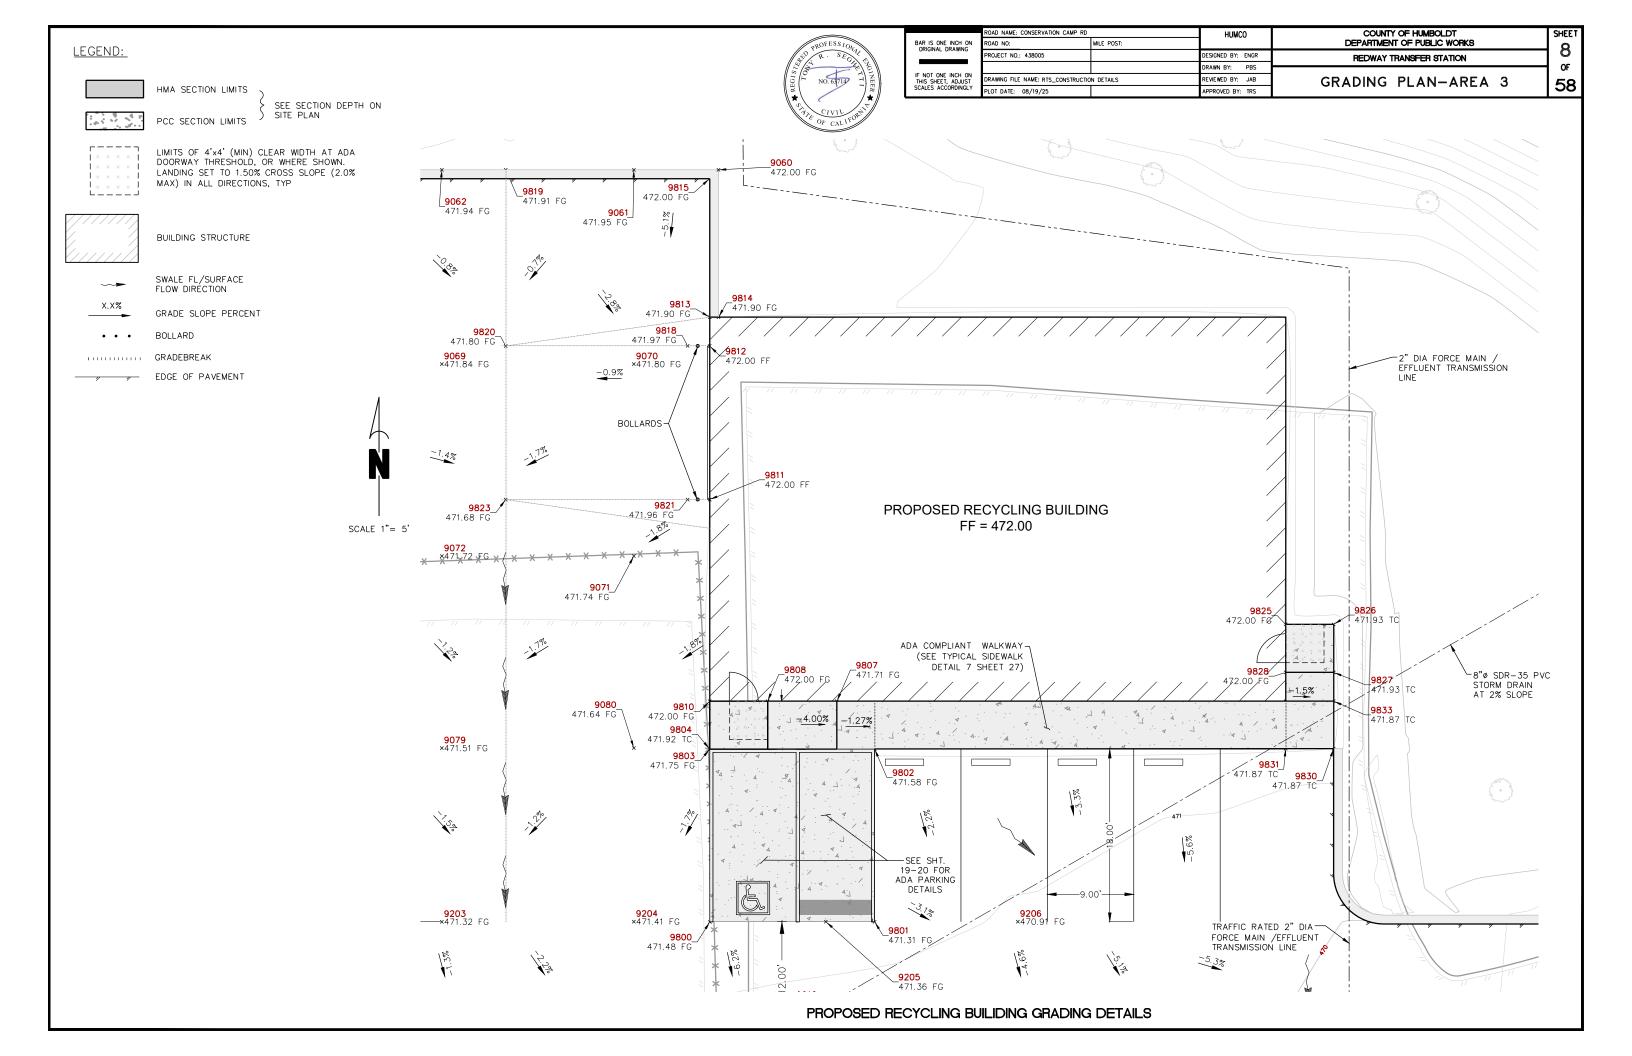


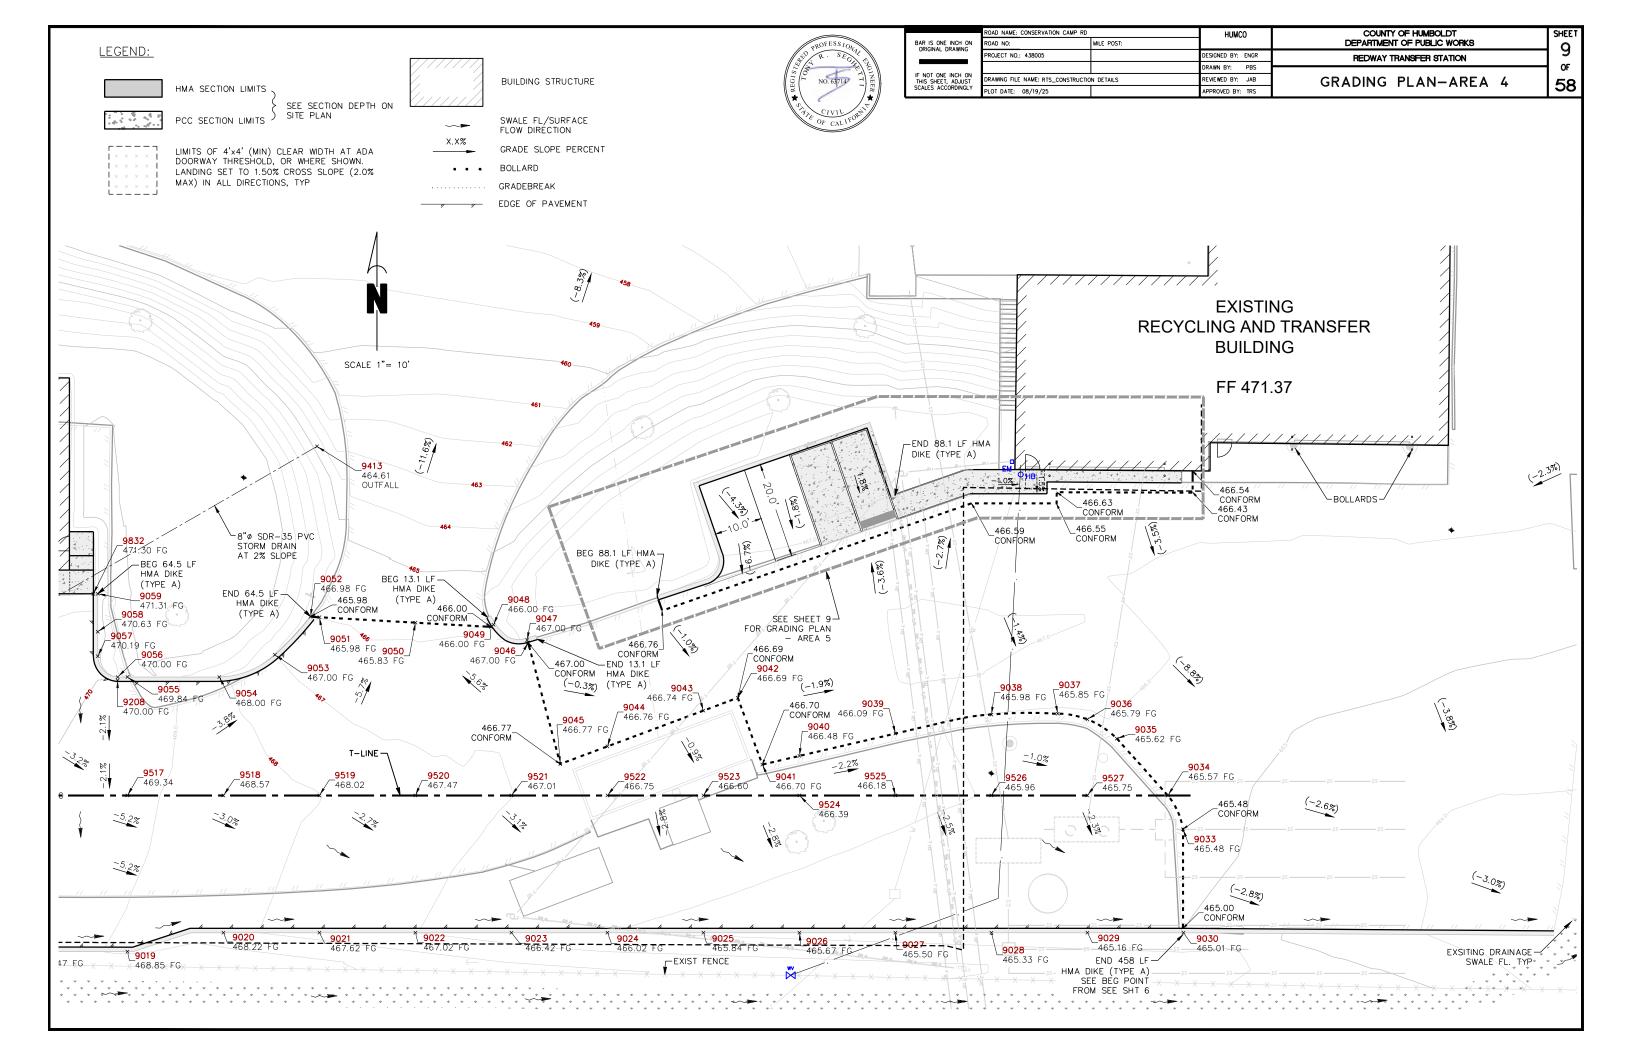


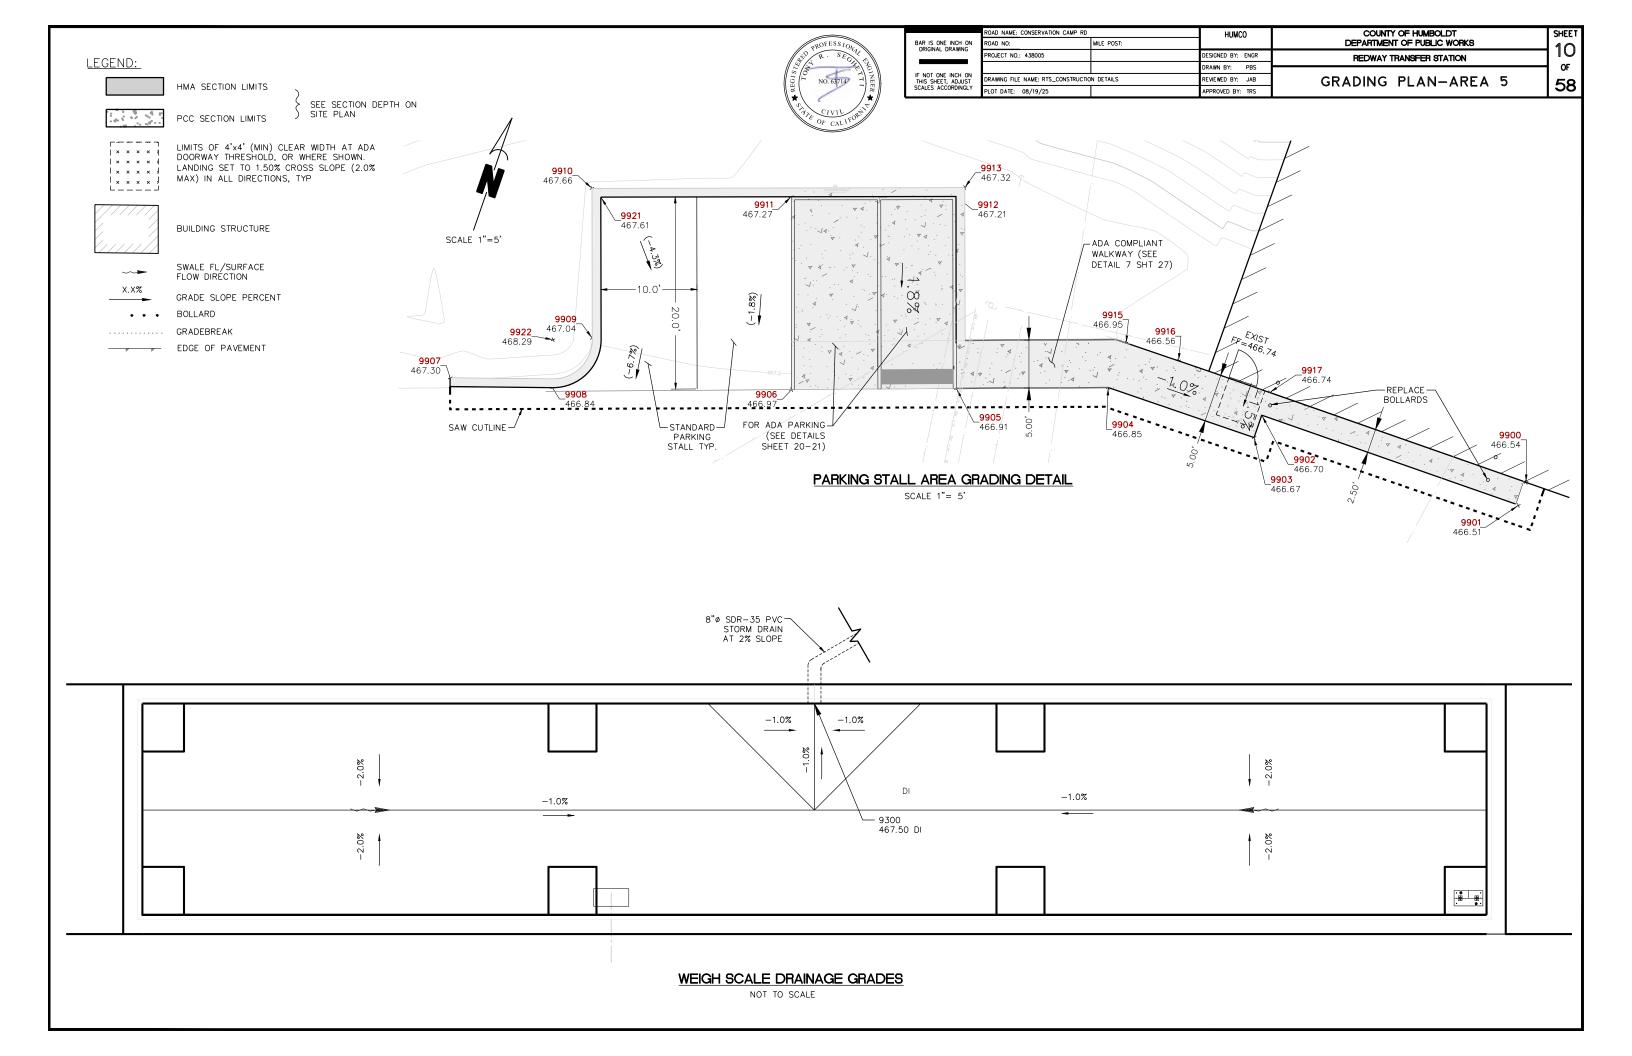


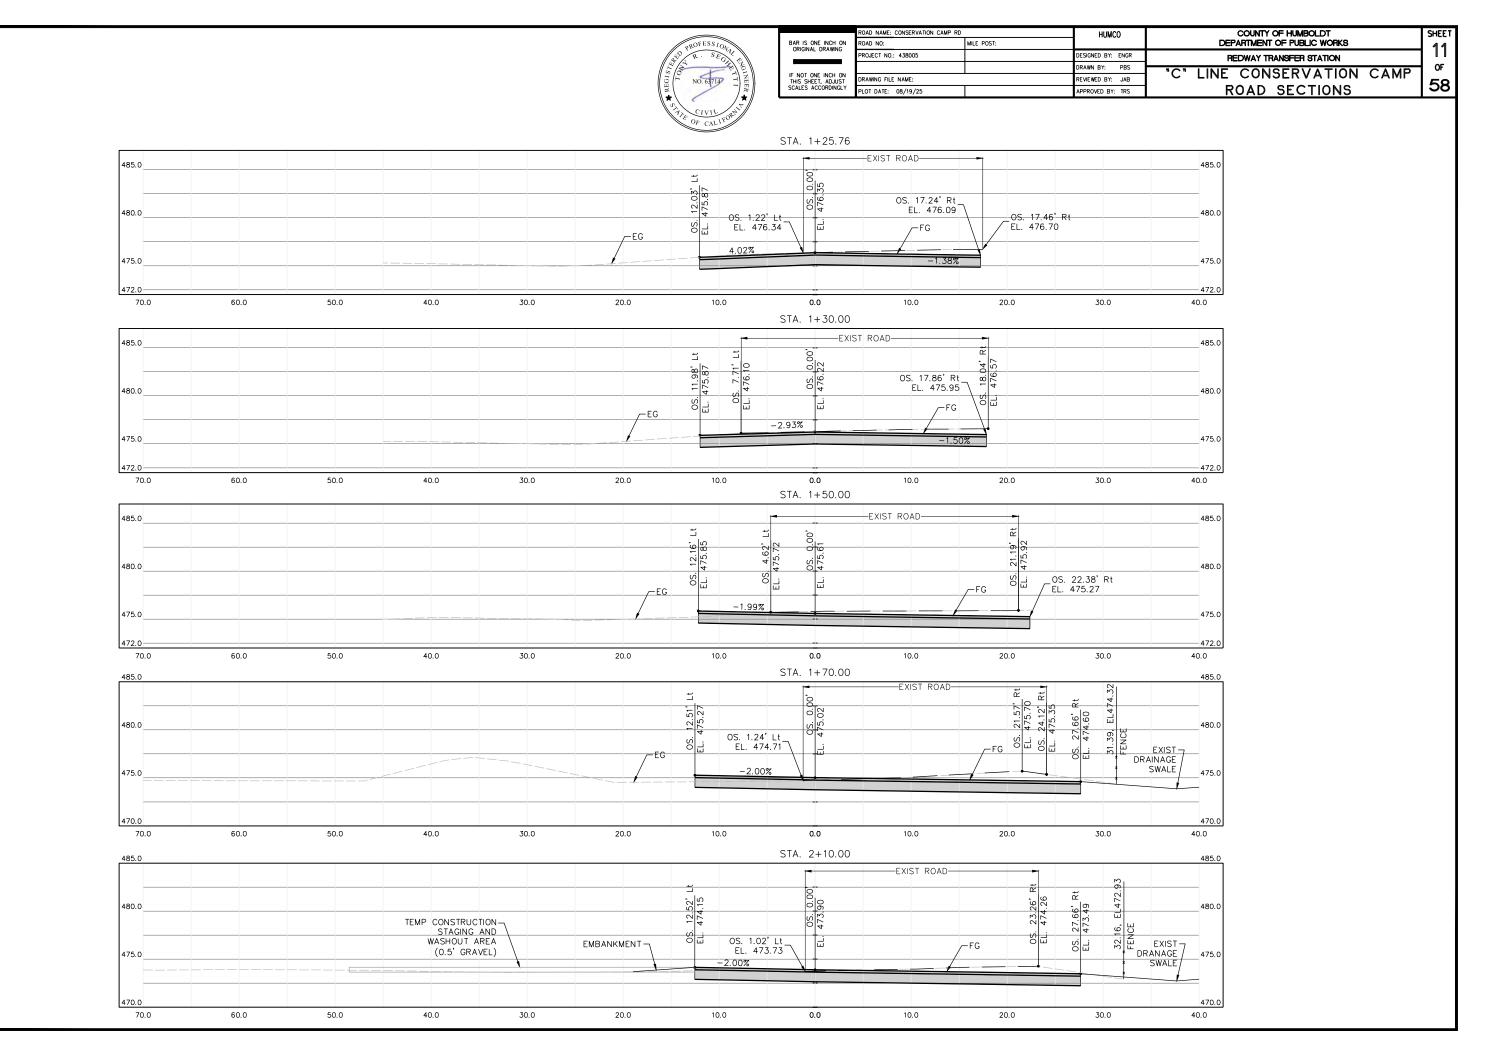

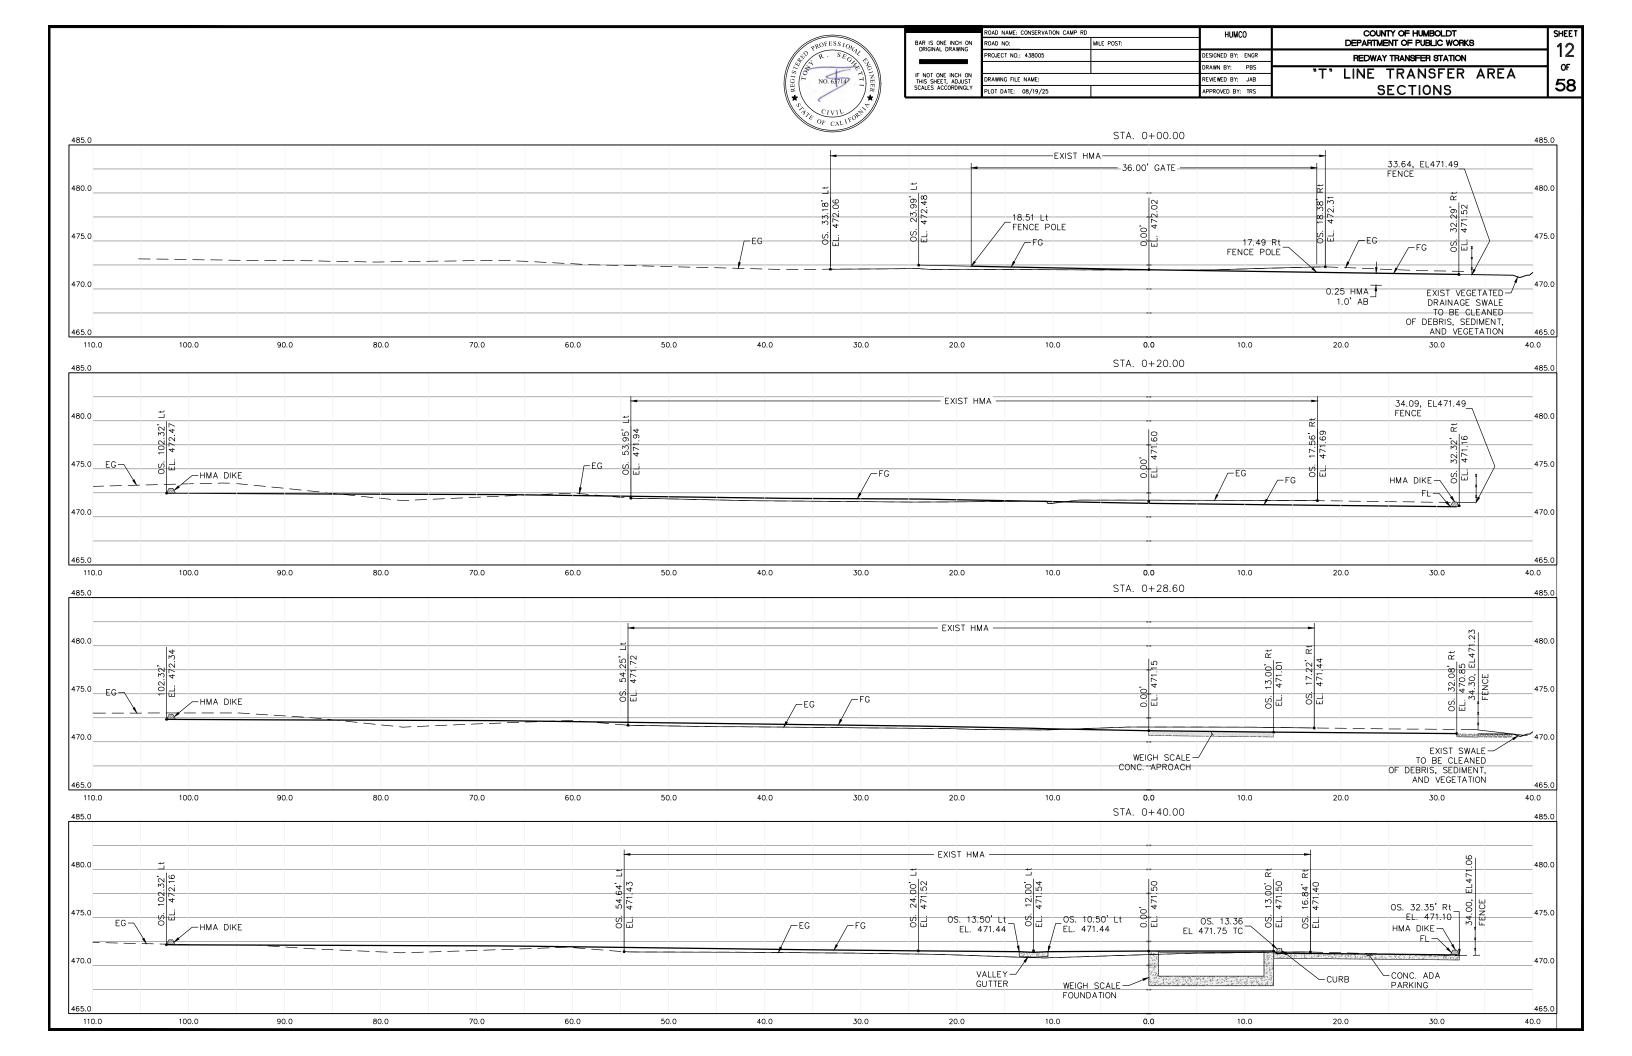

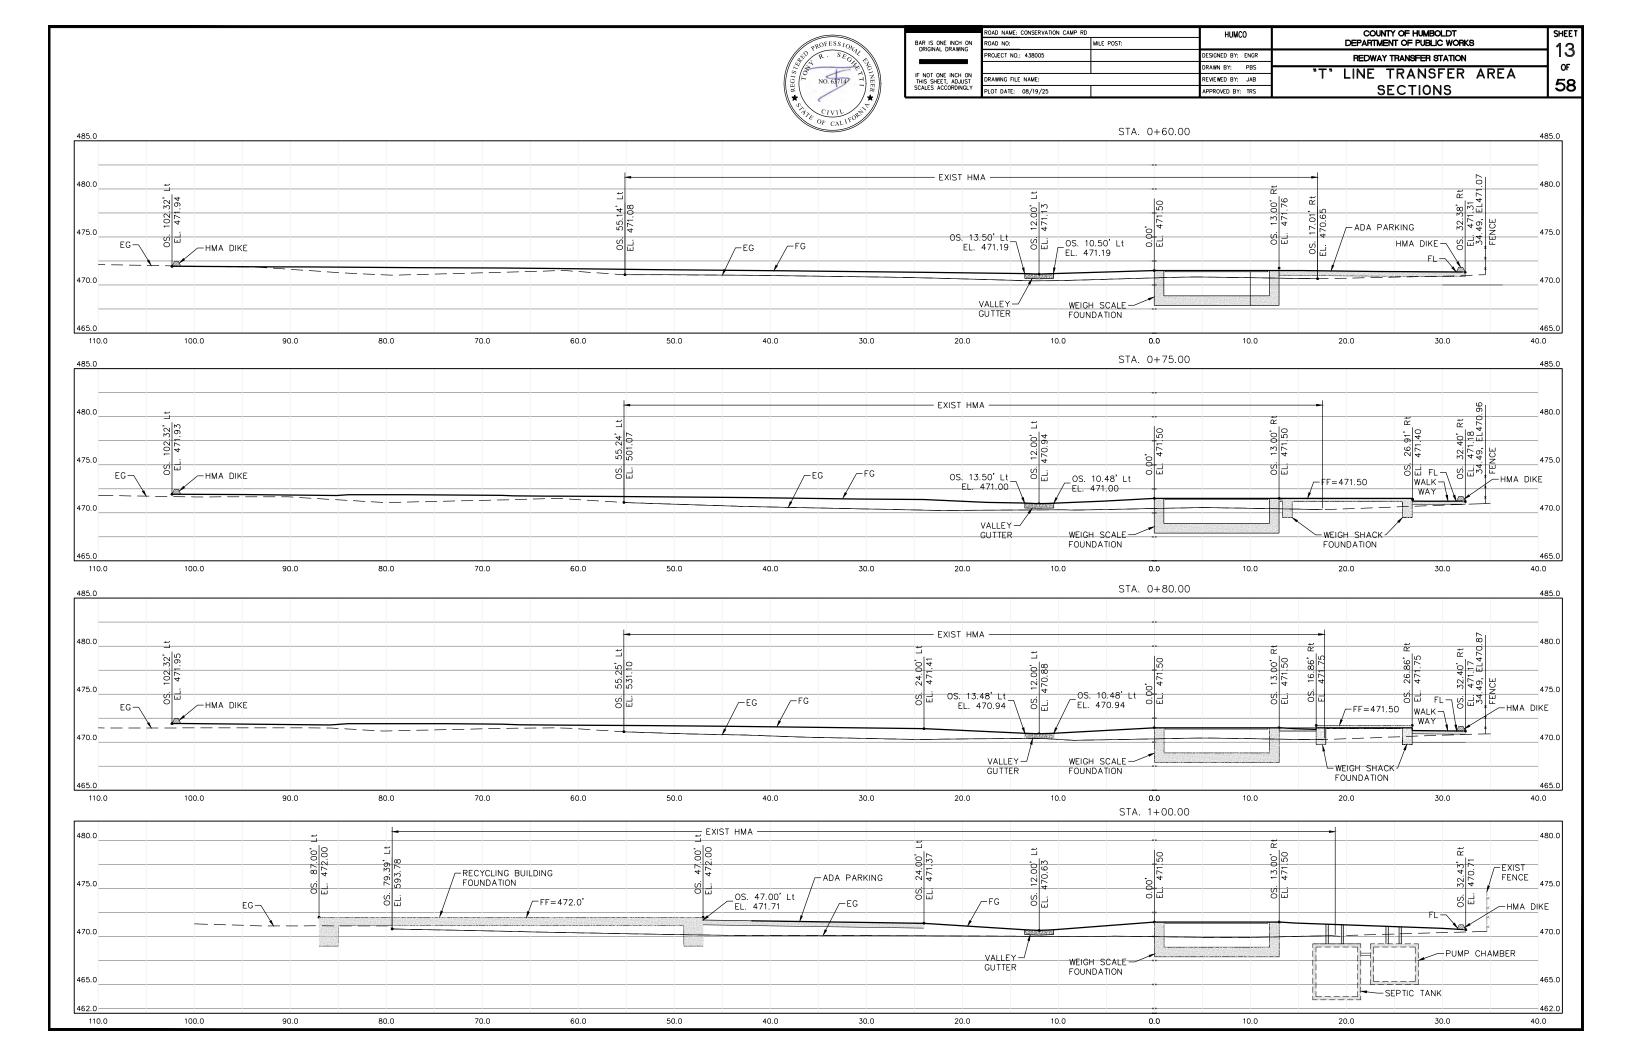

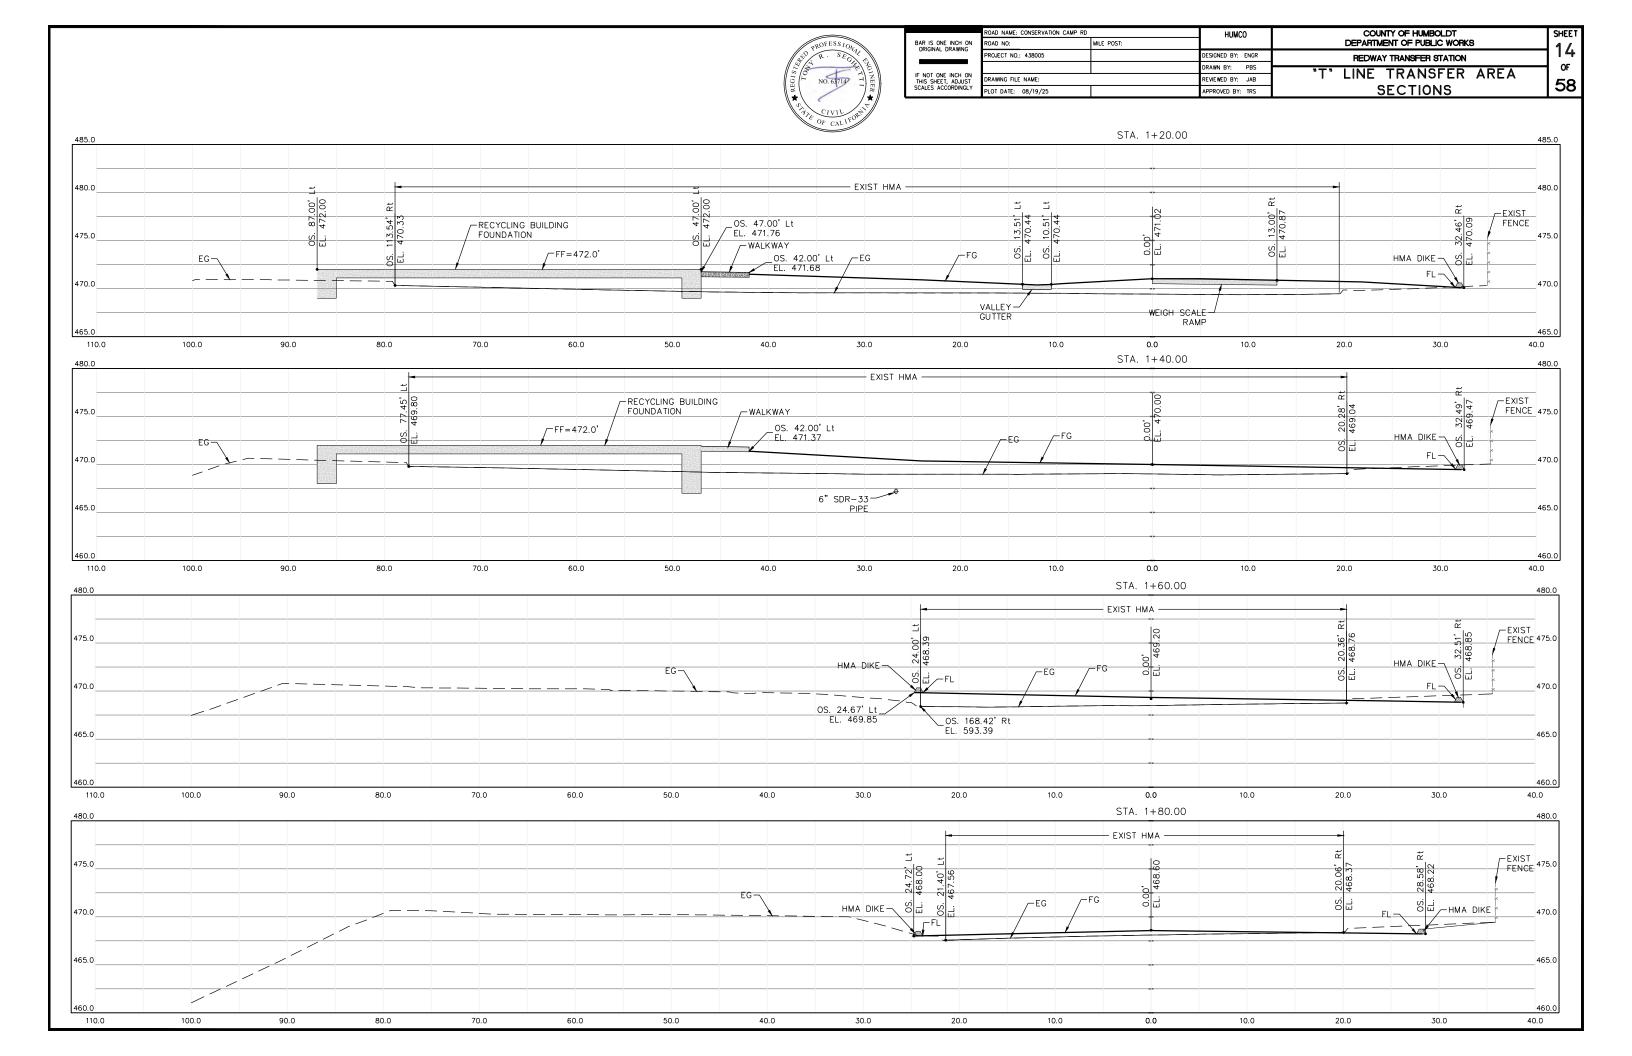


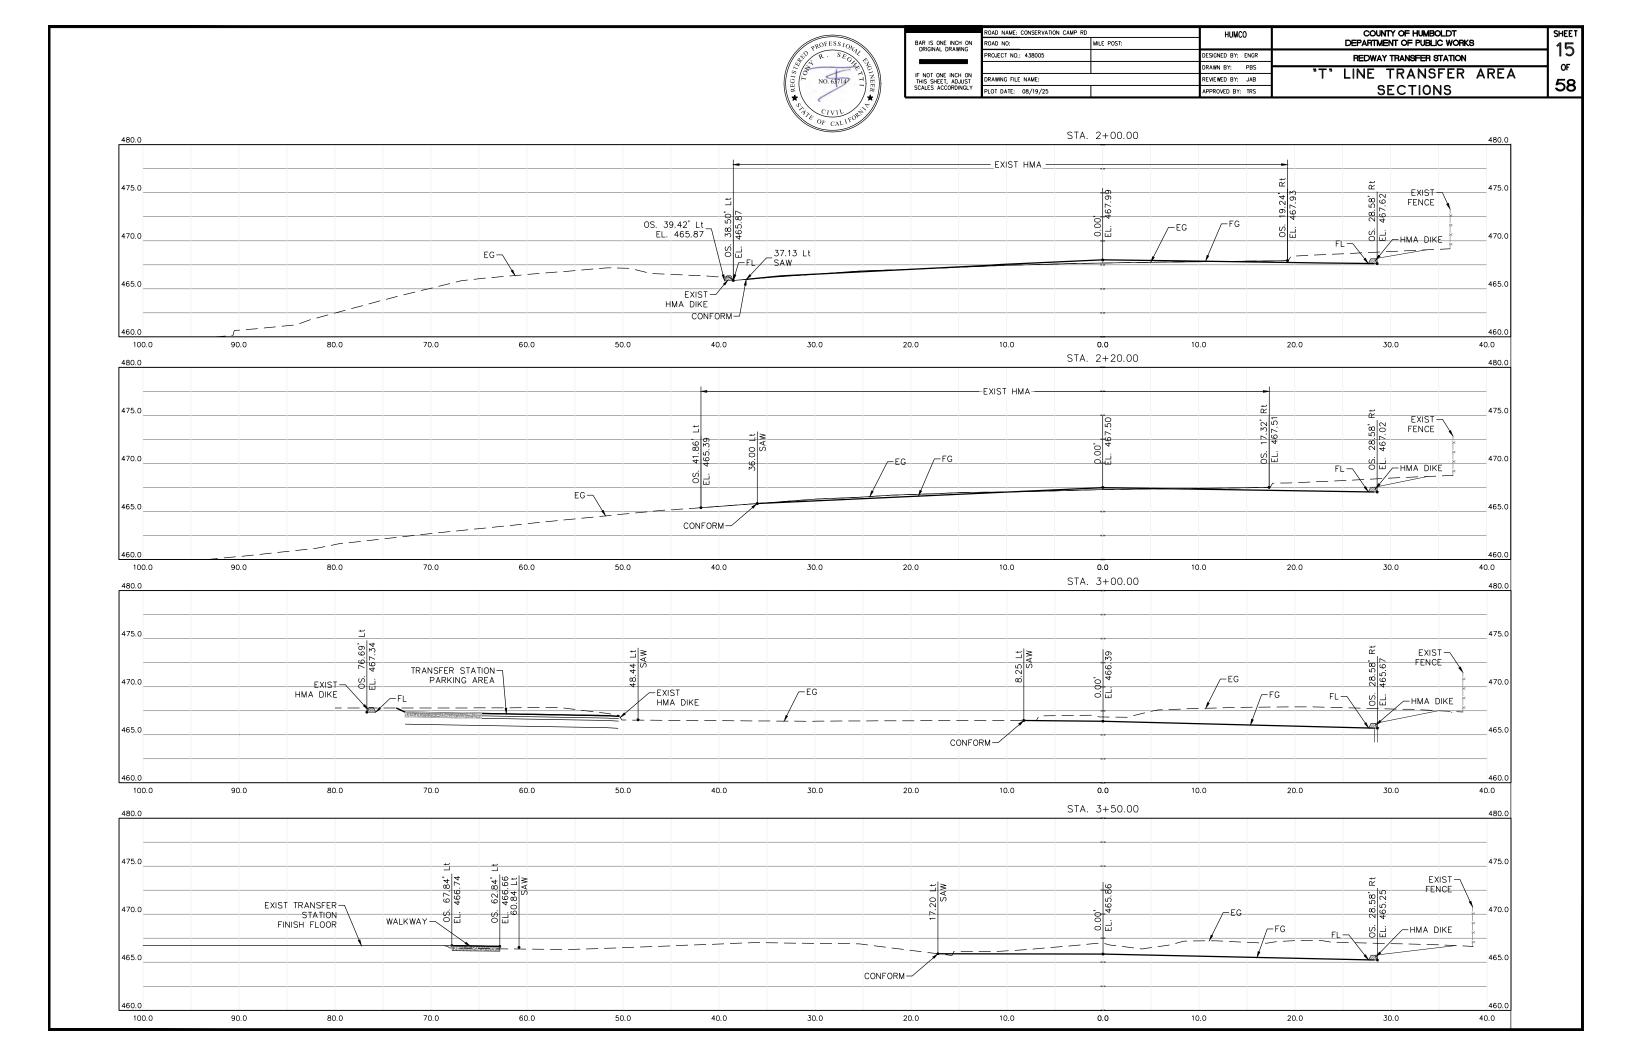





	ROAD NA
BAR IS ONE INCH ON ORIGINAL DRAWING	ROAD NO
ORIGINAL DRAWING	PROJECT
IF NOT ONE INCH ON THIS SHEET, ADJUST	DRAWING
SCALES ACCORDINGLY	DLOT DA

AD NAME: CONSERVATION CAMP RD		HUMCO	COUNTY OF HUMBOLDT	
AD NO:	MILE POST:		DEPARTMENT OF PUBLIC WORKS	16
OJECT NO.: 438005		DESIGNED BY: ENGR	REDWAY TRANSFER STATION	10
		DRAWN BY: PBS	"J" LINE PROFILE AND JOINT	OF
AWING FILE NAME:		REVIEWED BY: JAB	THE PROPERTY OF THE	58
OT DATE: 08/19/25		APPROVED BY: TRS	TRENCH DETAILS	JO

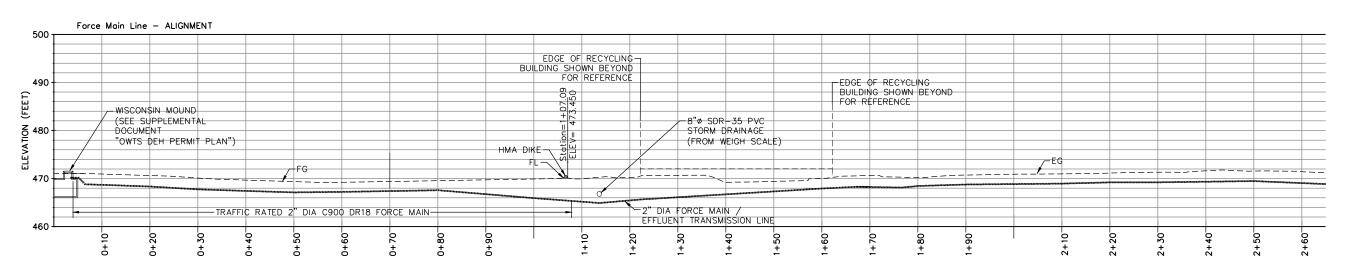

"J" LINE PROFILE AT STATION 0 + 0.00 TO 2 + 65.00

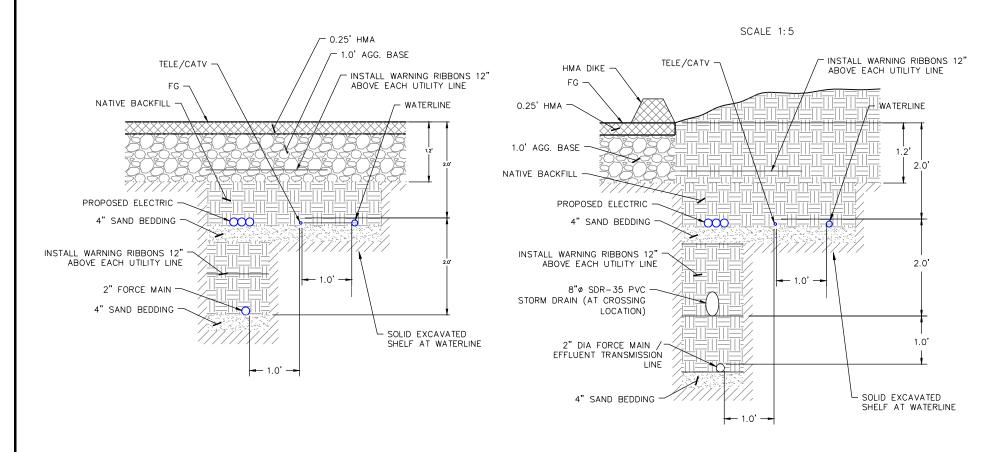

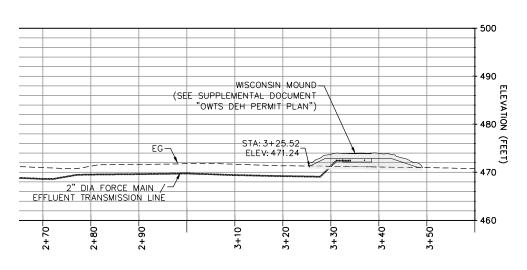


"J" LINE PROFILE AT STATION 2 + 65.00 TO 3 + 60.00 SCALE 1:5


JOINT-SERVICE TRENCH, TYPICAL


SCALE 1:1

**JOINT-SERVICE TRENCH** <u>AT STATION 1 + 13.63</u>

SCALE 1:1

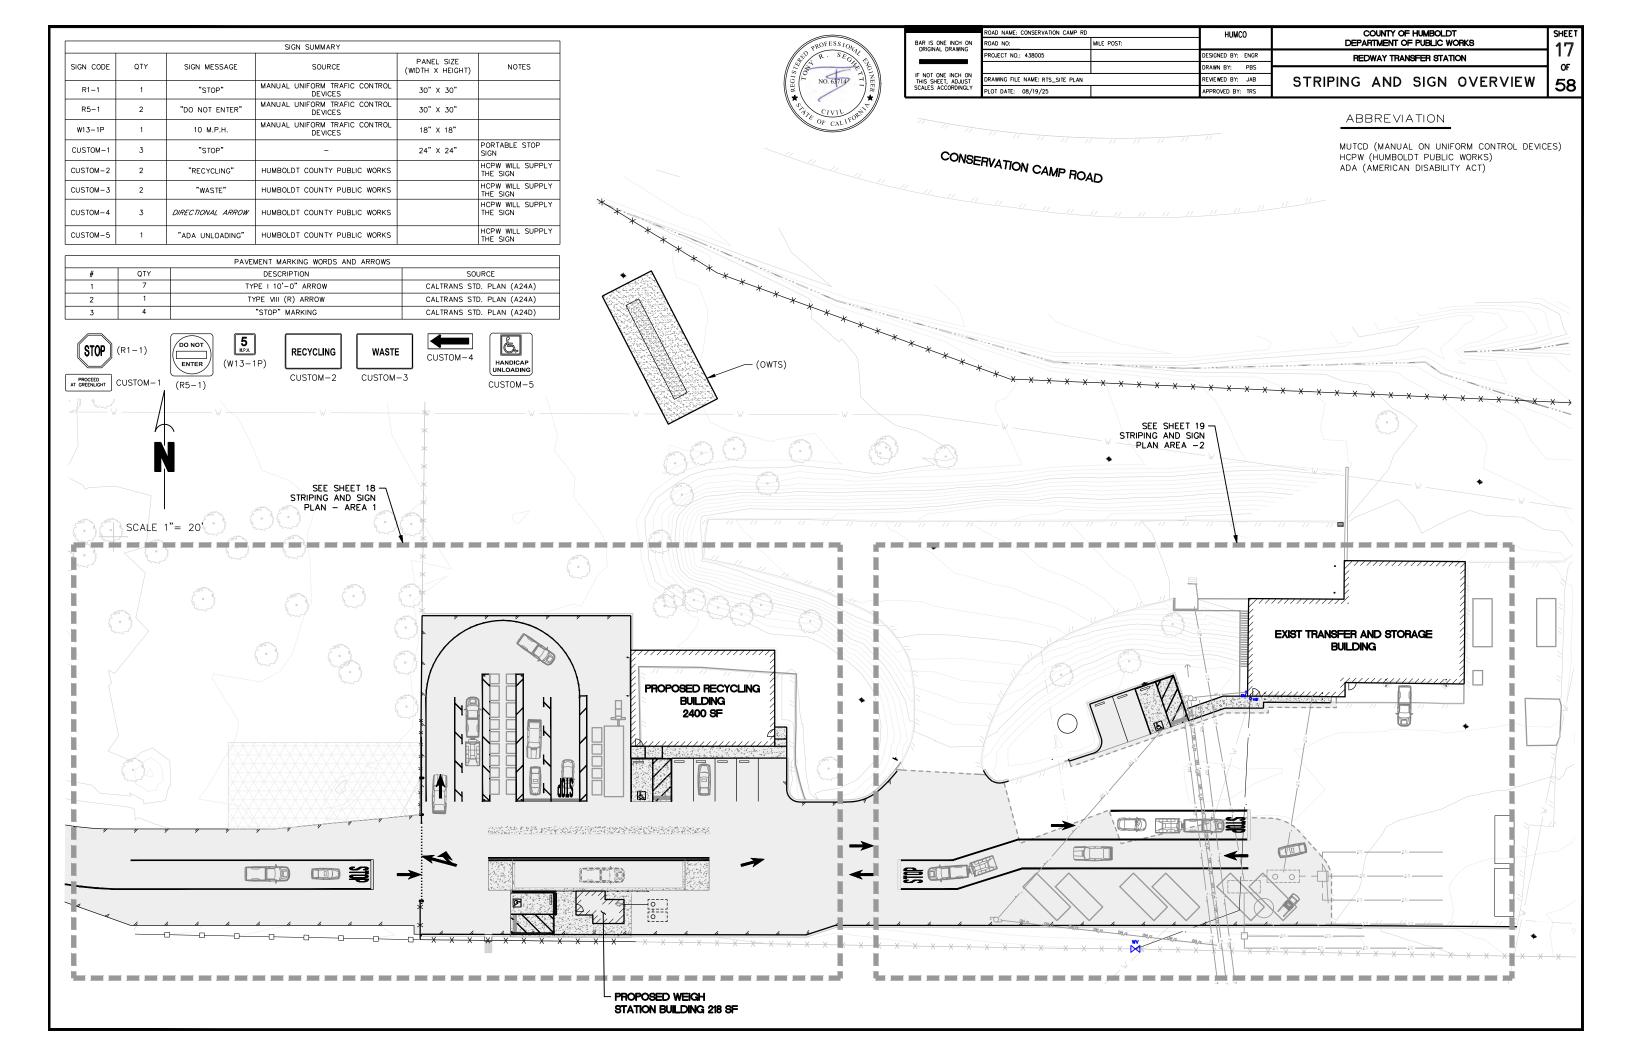

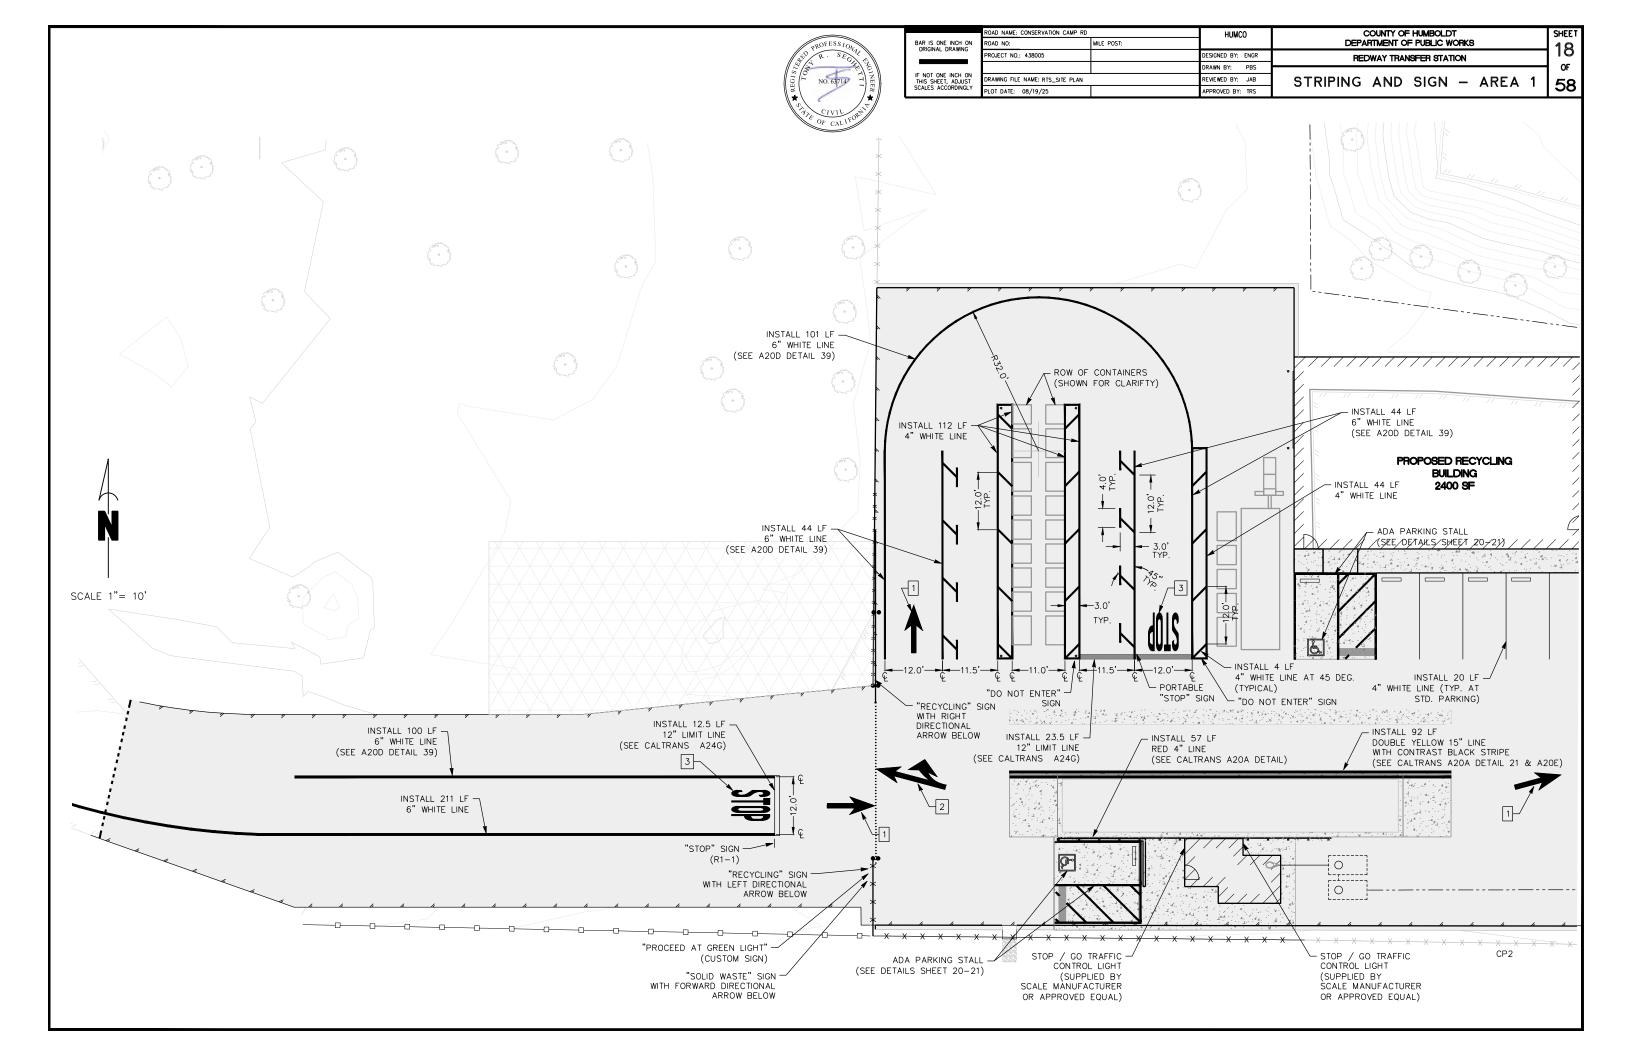

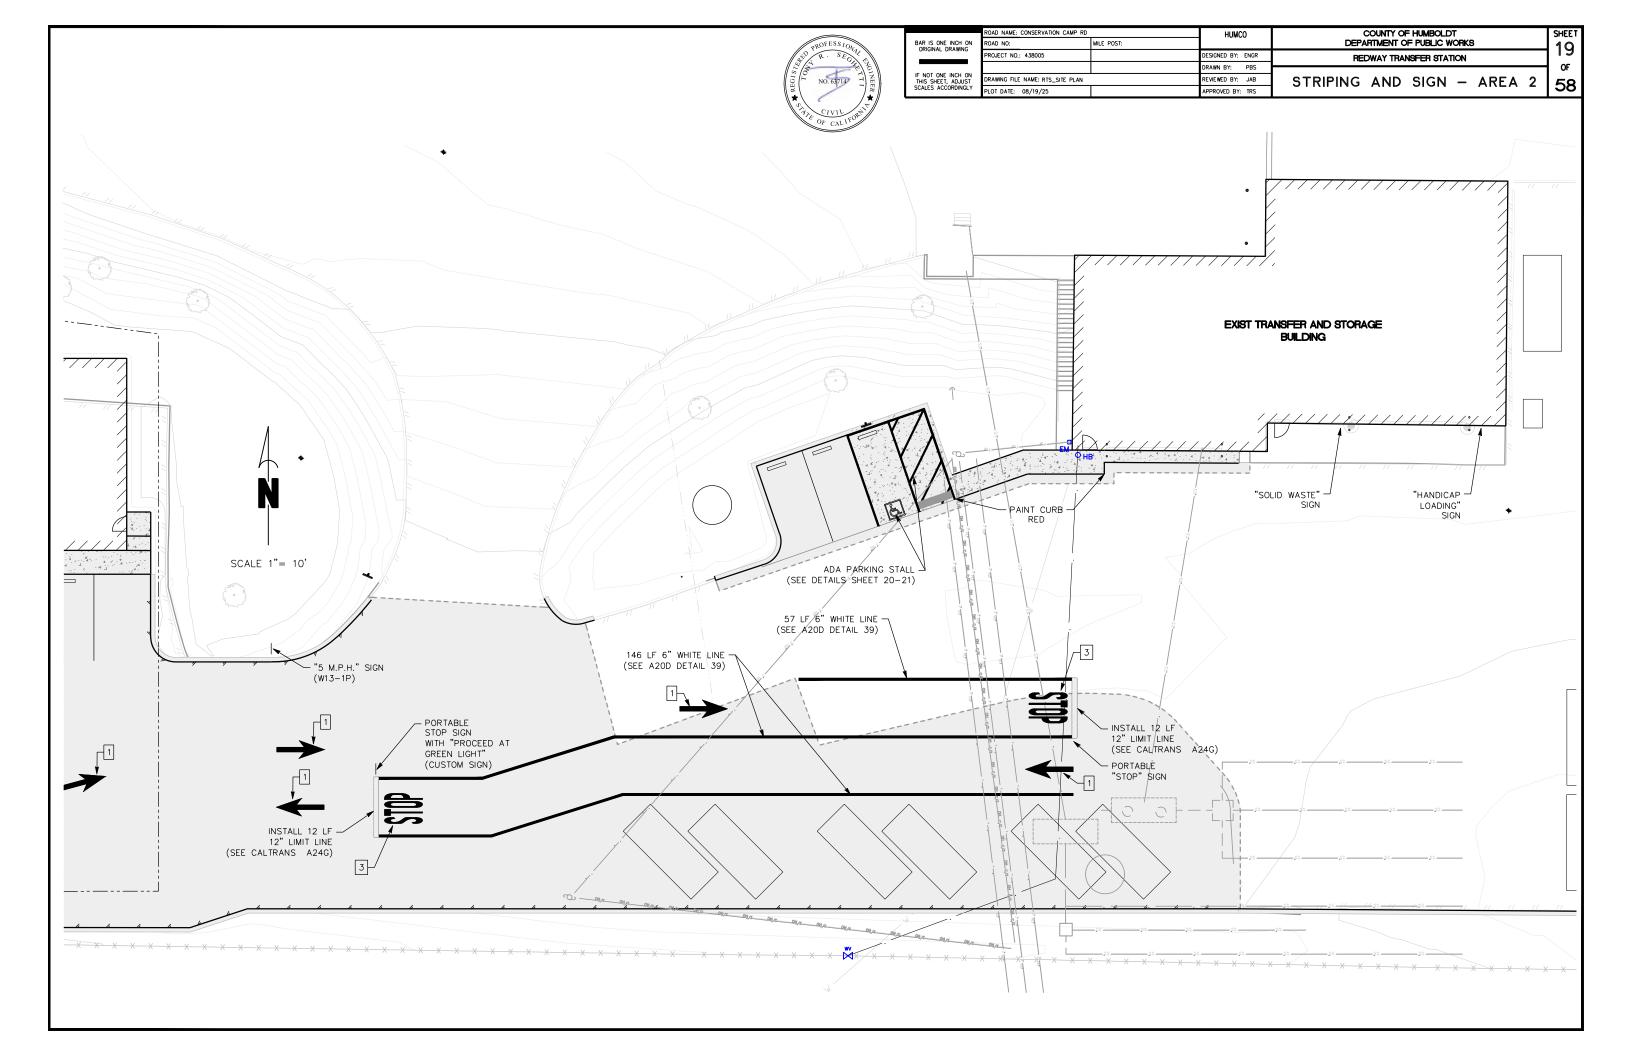

### GENERAL NOTES

### ADA PARKING NOTES:

- 1. ACCESSIBLE PARKING SPACES SERVING A PARTICULAR BUILDING SHALL BE LOCATED ON THE SHORTEST ACCESSIBLE ROUTE OF TRAVEL FROM ADJACENT PARKING TO AN ACCESSIBLE ENTRANCE. IN PARKING FACILITIES THAT DO NOT SERVE A PARTICULAR BUILDING, ACCESSIBLE PARKING SHALL BE LOCATED ON THE SHORTEST ACCESSIBLE ROUTE OF TRAVEL TO AN ACCESSIBLE PEDESTRIAN ENTRANCE OF THE PARKING FACILITY.
- 2. ONE IN EVERY SIX ACCESSIBLE OFF-STREET PARKING STALLS, BUT NOT LESS THAN ONE, SHALL BE SERVED BY AN ACCESSIBLE AISLE OF 8'-0" MINIMUM WIDTH AND SHALL BE SIGNED VAN ACCESSIBLE OR AS ALLOWED PER 2022 CBC SECTION 11B-208.2.4. THE R7-8B SIGN SHALL BE MOUNTED BELOW THE R99B (CA) PLAQUE OR THE R99C (CA) SIGN.
- 3. IN EACH PARKING STALL, A CURB OR BUMPER SHALL BE PROVIDED AND LOCATED TO PREVENT ENCROACHMENT OF VEHICLES OVER THE REQUIRED WIDTH OF WALKWAYS. PARKING STALLS SHALL BE SO LOCATED THAT PERSONS WITH DISABILITIES ARE NOT COMPELLED TO WHEEL OR WALK BEHIND PARKED CARS OTHER THAN THEIR OWN
- SURFACE SLOPES OF ACCESSIBLE OFF-STREET PARKING STALLS SHALL BE THE MINIMUM POSSIBLE AND SHALL NOT EXCEED 2 PERCENT IN ANY DIRECTION
- 5. 2022 CBC TABLE 11B-208.2 SHALL BE USED TO DETERMINE THE REQUIRED NUMBER OF ACCESSIBLE PARKING STALLS IN EACH PARKING LOT OR GARAGE
- 6. WHERE PLAQUE R99B (CA), SIGN R99C (CA) OR SIGN R7-8B ARE INSTALLED, THE BOTTOM OF THE LOWER SIGN OR PLAQUE PANEL SHALL BE A MINIMUM OF 5'-0" ABOVE THE SURROUNDING SURFACE. SIGNS LOCATED IN AN ACCESSIBLE ROUTE SHALL BE 80" MIN TO THE BOTTOM OF THE SIGN.
- THE WORDS "NO PARKING", SHALL BE PAINTED IN WHITE LETTERS NO LESS THAN 1'-0" HIGH AND LOCATED SO THAT IT IS VISIBLE TO TRAFFIC ENFORCEMENT OFFICIALS IN THE LOADING AND UNLOADING ACCESS AISLE. SEE DETAIL 3 SHEET 20.
- 8. A R100B (CA) SIGN SHALL BE POSTED IN A CONSPICUOUS PLACE AT EACH ENTRANCE TO OFF-STREET PARKING FACILITIES OR IMMEDIATELY ADJACENT TO AND VISIBLE FROM EACH STALL. THE SIGN SHALL INCLUDE THE ADDRESS WHERE THE TOWED VEHICLE MAY BE RECLAIMED AND THE TELEPHONE NUMBER OF THE LOCAL TRAFFIC LAW ENFORCEMENT AGENCY AS A PERMANENT PART OF THE SIGN. MINIMUM TEXT HEIGHT SHALL BE 1".
- WHERE A SINGLE (NON-VAN) ACCESSIBLE PARKING SPACE IS PROVIDED, THE LOADING AND UNLOADING ACCESS AISLE SHALL BE 5'-0" WIDE MINIMUM, ON THE PASSENGER SIDE OF THE VEHICLE AS THE VEHICLE IS GOING FORWARD INTO THE
- 10. WHERE A VAN ACCESSIBLE PARKING SPACE IS PROVIDED, THE LOADING AND UNLOADING ACCESS AISLE SHALL BE 8'-0" WIDE MINIMUM, AND SHALL BE ON THE PASSENGER SIDE OF THE VEHICLE AS THE VEHICLE IS GOING FORWARD INTO THE PARKING SPACE. THESE SPACES REQUIRE SIGN R7-8B IN ADDITION TO THE SIGNAGE
- 11. THE ACCESSIBLE PARKING ONLY SIGN SHALL BE SIGN R99C (CA) OR SIGN R99 (CA) WITH PLAQUE R99B (CA). MINIMUM TEXT HEIGHT SHALL BE 1".
- 12. ALL ACCESSIBLE PARKING SPACES, ACCESS AISLES, AND VEHICULAR ROUTES SERVING THEM SHALL HAVE A MINIMUM VERTICAL CLEARANCE OF 98".

### ACCESSIBLE ROUTE WALKING SURFACE NOTES:

- 1. FLOOR AND GROUND SURFACES SHALL BE STABLE, FIRM AND SLIP RESISTANT.
- 2. OPENINGS IN FLOOR OR GROUND SURFACES SHALL NOT ALLOW PASSAGE OF A SPHERE MORE THAN 1/2 INCH DIAMETER. ELONGATED OPENINGS SHALL BE PLACED SO THAT THE LONG DIMENSION IS PERPENDICULAR TO THE DOMINANT DIRECTION OF TRAVEL
- 3. CHANGES IN LEVEL OF 1/4 INCH HIGH MAXIMUM SHALL BE PERMITTED TO BE VERTICAL AND WITHOUT EDGE TREATMENT. CHANGES IN LEVEL BETWEEN 1/4 INCH HIGH MINIMUM AND 1/2 INCH HIGH MAXIMUM SHALL BE BEVELED WITH A SLOPE NOT STEEPER THAN 1:2.
- 4. CHANGES IN LEVEL GREATER THAN 1/2 INCH HIGH SHALL BE RAMPED AND SHALL COMPLY WITH RAMP DETAILS AND NOTES.
- 5. ABRUPT CHANGES IN LEVEL EXCEEDING 4 INCHES IN A VERTICAL DIMENSION BETWEEN WALKS, SIDEWALKS OR OTHER PEDESTRIAN WAYS AND ADJACENT SURFACES OR FEATURES SHALL BE IDENTIFIED BY WARNING CURBS AT LEAST 6 INCHES IN HEIGHT ABOVE THE WALK OR SIDEWALK SURFACE. EXCEPTIONS: A WARNING CURB IS NOT REQUIRED BETWEEN A WALK OR SIDEWALK AND AN ADJACENT STREET OR DRIVEWAY. A WARNING CURB IS NOT REQUIRED WHEN A GUARD OR HANDRAIL IS PROVIDED WITH A GUIDE RAIL CENTERED 2 INCHES MINIMUM AND 4 INCHES MAXIMUM ABOVE THE SURFACE OF THE WALK OR SIDEWALK
- 6. SLOPE: THE RUNNING SLOPE OF WALKING SURFACES SHALL NOT BE STEEPER THAN 1:20 (5%). THE CROSS SLOPE OF WALKING SURFACES SHALL NOT BE STEEPER THAN 1:48 (2%). EXCEPTION: THE RUNNING SLOPE OF SIDEWALKS SHALL NOT EXCEED THE GENERAL GRADE ESTABLISHED FOR THE ADJACENT STREET OR HIGHWAY.
- 7. CLEAR WIDTH: THE CLEAR WIDTH OF INTERIOR WALKING SURFACES SHALL BE 36 INCHES MINIMUM (48" MINIMUM OUTSIDE). EXCEPTIONS: WITHIN EMPLOYEE WORK AREAS, CLEARANCES ON COMMON USE CIRCULATION PATHS SHALL BE PERMITTED TO BE DECREASED BY WORK AREA EQUIPMENT PROVIDED THAT THE DECREASE IS ESSENTIAL TO THE FUNCTION OF THE WORK BEING PERFORMED. THE CLEAR WIDTH SHALL BE PERMITTED TO BE REDUCED TO 32 INCHES MINIMUM FOR A LENGTH OF 24 INCHES MAXIMUM PROVIDED THAT REDUCED WIDTH SEGMENTS ARE SEPARATED BY SEGMENTS THAT ARE 48 INCHES LONG MINIMUM AND 36 INCHES WIDE
- 8. PASSING SPACES: AN ACCESSIBLE ROUTE WITH A CLEAR WIDTH LESS THAN 60 INCHES SHALL PROVIDE PASSING SPACES AT INTERVALS OF 200 FEET MAXIMUM. PASSING SPACES SHALL BE EITHER: A SPACE 60 INCHES MINIMUM BY 60 INCHES MINIMUM; OR AN INTERSECTION OF TWO WALKING SURFACES PROVIDING A T- SHAPED SPACE WHERE THE BASE AND ARMS OF THE T-SHAPED SPACE EXTEND 48 INCHES MINIMUM BEYOND THE INTERSECTION.
- 9. CONTINUOUS GRADIENT: ALL WALKS WITH CONTINUOUS GRADIENTS SHALL HAVE RESTING AREAS, 60 INCHES IN LENGTH, AT INTERVALS OF 400 FEET MAXIMUM. THE RESTING AREA SHALL BE AT LEAST AS WIDE AS THE WALK. THE SLOPE OF THE RESTING AREA IN ALL DIRECTIONS SHALL BE 1:48 (2%) MAXIMUM.




	ROAD NAME: CONSERVATION CAMP RD		HUMCO		COUNTY OF HUMBOLDT	Г
BAR IS ONE INCH ON ORIGINAL DRAWING	ROAD NO:	MILE POST:			DEPARTMENT OF PUBLIC WORKS	ı
	PROJECT NO.: 438005		DESIGNED BY: ENGR		REDWAY TRANSFER STATION	ı
			DRAWN BY: PBS			ı
INIS SHEET, ADJUST	DRAWING FILE NAME: RTS_CONSTRUCTION	ON DETAILS	REVIEWED BY: JAB	ADA (	CONSTRUCTION DETAILS	ı
SCALES ACCORDINGLY	PLOT DATE: 08/19/25		APPROVED BY: TRS	,,,,,,,		ı

### ACCESSIBLE PATH OF TRAVEL NOTES:

- 1. SITE ARRIVAL POINTS: AT LEAST ONE ACCESSIBLE ROUTE SHALL BE PROVIDED WITHIN THE SITE FROM ACCESSIBLE PARKING SPACES AND ACCESSIBLE PASSENGER DROP-OFF AND LOADING ZONES, PUBLIC STREETS AND SIDEWALKS, AND PUBLIC TRANSPORTATION STOPS TO THE ACCESSIBLE BUILDING OR FACILITY ENTRANCE THEY SERVE. WHERE MORE THAN ONE ROUTE IS PROVIDED. ALL ROUTES MUST BE ACCESSIBLE EXCEPTION: AN ACCESSIBLE ROUTE SHALL NOT BE REQUIRED BETWEEN SITE ARRIVAL POINTS AND THE BUILDING OR FACILITY ENTRANCE IF THE ONLY MEANS OF ACCESS BETWEEN THEM IS A VEHICULAR WAY NOT PROVIDING PEDESTRIAN ACCESS
- 2. WITHIN A SITE: AT LEAST ONE ACCESSIBLE ROUTE SHALL CONNECT ACCESSIBLE BUILDINGS, ACCESSIBLE FACILITIES, ACCESSIBLE ELEMENTS, AND ACCESSIBLE SPACES THAT ARE ON THE SAME SITE. EXCEPTION: AN ACCESSIBLE ROUTE SHALL NOT BE REQUIRED BETWEEN ACCESSIBLE BUILDINGS. ACCESSIBLE FACILITIES. ACCESSIBLE ELEMENTS, AND ACCESSIBLE SPACES IF THE ONLY MEANS OF ACCESS BETWEEN THEM IS A VEHICULAR WAY NOT PROVIDING PEDESTRIAN ACCESS
- 3. SPACES AND ELEMENTS: AT LEAST ONE ACCESSIBLE ROUTE SHALL CONNECT ACCESSIBLE BUILDING OR FACILITY ENTRANCES WITH ALL ACCESSIBLE SPACES AND ELEMENTS WITHIN THE BUILDING OR FACILITY, INCLUDING MEZZANINES.


### ADA ENTRANCE NOTES:


- 1. WHEN SIGNS IDENTIFY, DIRECT, OR GIVE INFORMATION ABOUT ACCESSIBLE ELEMENTS AND FEATURES OF A BUILDING OR SITE, THEY SHALL INCLUDE THE INTERNATIONAL SYMBOL OF ACCESSIBILITY.
- 2. ACCESSIBLE BUILDING ENTRANCES SHALL BE IDENTIFIED WITH A MINIMUM OF ONE INTERNATIONAL SYMBOL OF ACCESSIBILITY AND WITH ADDITIONAL DIRECTIONAL SIGNS AS NEEDED TO IDENTIFY ACCESSIBLE FACILITIES AND PATHS OF TRAVEL.

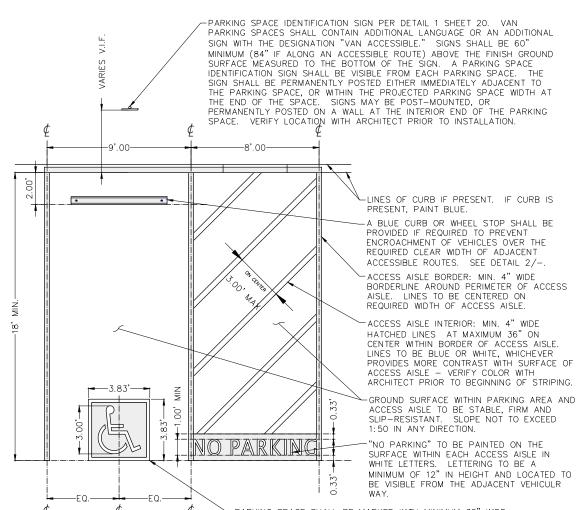

INTERNATIONAL SYMBOL OF ACCESSIBILITY (ISA) MARKING NOT TO SCALE

PARKING SPACE SHALL BE MARKED WITH MINIMUM 36" WIDE BY 36" HIGH INTERNATIONAL SYMBOL OF ACCESSIBILITY COMPLYING WITH CBC SECTION 11B-703.7.2.1 IN WHITE ON A BLUE BACKGROUND. THE CENTERLINE SHALL ALIGN WITH THE CENTERLINE OF THE PARKING SPACE, AND THE LOWER EDGE SHALL ALIGN WITH THE END OF THE PARKING SPACE LENGTH. SEE DETAIL 1/-.

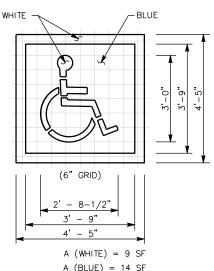

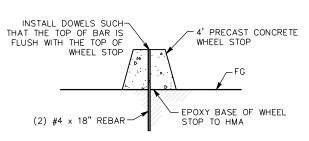


SHEE 1

58

1) INTERNATIONAL SYMBOL OF ACCESSIBILITY (ISA) MARKING

2 CONCRETE WHEEL STOP

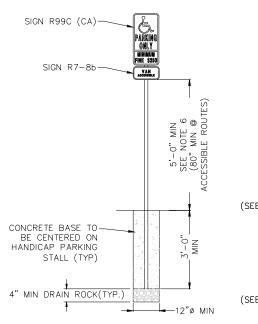




SIGN R99C (CA) (SEE ADA PARKING NOTES 6 & 7 SHEET 20)

ACCESSIBLE

SIGN R7-8b (SEE ADA PARKING NOTES 2 & 7 SHEET 20)

1 ADA SIGN POLE DETAIL NOT TO SCALE

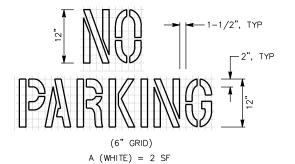

LOADING + UNLOADING AREA
PAVEMENT MARKING LEGEND NOT TO SCALE




P		ROAD NAME: CONSERVATION CAMP RD		HUMCO	COUNTY OF HUMBOLDT
l	BAR IS ONE INCH ON ORIGINAL DRAWING	ROAD NO:	MILE POST:		DEPARTMENT OF PUBLIC WORKS
ı		PROJECT NO.: 438005		DESIGNED BY: ENGR	REDWAY TRANSFER STATION
ı				DRAWN BY: PBS	
l	ITIIS SHEET, ADJUST	DRAWING FILE NAME: RTS_CONSTRUCTION	N DETAILS	REVIEWED BY: JAB	ADA CONSTRUCTION DETAILS
L	SCALES ACCORDINGLY	PLOT DATE: 08/19/25		APPROVED BY: TRS	

SHEET 21 OF 58

UNAUTHORIZED VEHICLES PARKED IN DESIGNATED ACCESSIBLE SPACES NOT DISPLAYING DISTINGUISHING PLACARDS OR SPECIAL LICENSE PLATES ISSUED FOR PERSONS WITH DISABILITIES
WILL BE TOWED AWAY AT THE OWNER'S EXPENSE TOWED VEHICLES MAY BE RECLAIMED AT (Insert Address) OR BY TELEPHONING (Insert Telephone Number)

SIGN R7-8b (SEE ADA PARKING NOTES 8 SHEET 20)

OFF-STREET PARKING SIGNS NOT TO SCALE

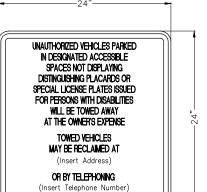



	ROAD NAME: CO
BAR IS ONE INCH ON ORIGINAL DRAWING	ROAD NO:
ORIGINAL DRAWING	PROJECT NO.: 4
IF NOT ONE INCH ON THIS SHEET, ADJUST	DRAWING FILE N.
SCALES ACCORDINGLY	DI OT DATE OF

AD NAME: CONSERVATION CAMP RD	HUMCO	ı	
AD NO:	MILE POST:		
OJECT NO.: 438005		DESIGNED BY: ENGR	Г
		DRAWN BY: PBS	H
AWING FILE NAME: RTS_CONSTRUCTION DETAILS		REVIEWED BY: JAB	l
OT DATE: 08/19/2025	REVISION DATE:	APPROVED BY: TRS	


DEPARTMENT OF PUBLIC WORKS REDWAY TRANSFER STATION MANUFACTURES WEIGH SCAL FOUNDATION PLAN

COUNTY OF HUMBOLDT


	22	
F	OF	
_	58	


SHEET

		REBAR SCHED	ULE	
BAL NO.	QUANTITY	LENGTH (IN.)	DESCRIPTION	WEIGH
A	52	114	# 5 Ø 12 O.C.	515
8	40	150	# 5 @ 12 O.C.	522
c	52	52	# 5 @ 12 O.C.	235
D	20	150	# 5 @ 12 O.C.	261
ε	26	866	# 5 @ 12 O.C.	2957
F	146	150	# 5 Ø 12 O.C.	2903
6	16	32	# 5 @ 8 O.C.	45
H	15	24	# 5 Ø 8 O.C.	33
3	32	24	# 5 @ 8 O.C.	67
K	48	35	# 5 Ø 8 O.C.	146
L	140	52	# 5 @ 12 O.C.	633
M	20	834	# 5 Ø 12 O.C.	1450
		TOTAL WEIGH	IT OF REBAR (LBS.)	7766

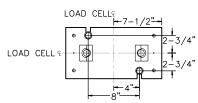

**DETAIL D** 

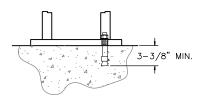

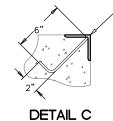


-3 X 3 X 1/4 X 12'-11" ANCHOR F.B. 2" X 1/4" WELDED TO ANGLE @ 18" C.C.

"NELSON" TYPE C-4 ANCHOR STUDS, Ø1/2 X 6" LONG, OR APPROVED EQUIV. (APPROACH COPING NOT INCLUDED)

### NOTES:


- 1. THE FOUNDATION SHOWN IS DESIGNED FOR THE RICE LAKE WEIGHING SYSTEMS 70' X 11' OTR SERIES TRUCK SCALE INSTALLED IN A CONCRETE PIT. REFER TO THE SUPPLEMENTAL DOCUMENTATIONS FOR ADDITIONAL DETAILS SPECIFIC TO RICE LAKE WEIGHING SYSTEMS.
- 2. IF A DIFFERENT MANUFACTURER IS SELECTED, PRIOR APPROVAL MUST BE OBTAINED FROM THE HUMBOLDT COUNTY PUBLIC WORKS ENGINEERING DEPARTMENT.




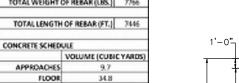

FLOOR: 34.8 PIERS 4.2 WALLS 25.6 74.2

MISC. STEEL 3 X 3 X 1/4 165 LN .FT 809 LBS

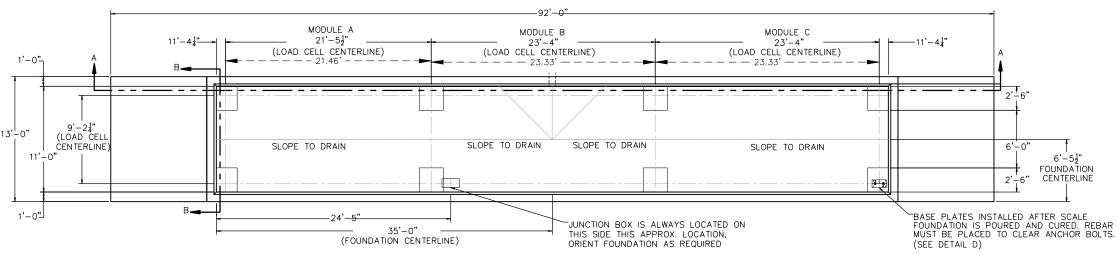

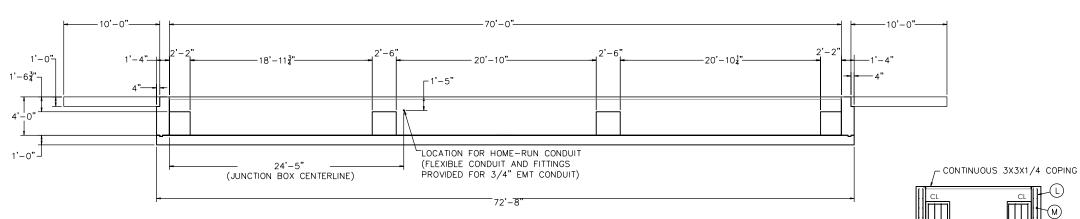


### NOTES:

- CONCRETE: f'c = 3500 PSI @ 28 DAYS.
- REINFORCING STEEL: DEFORMED BARS ASTM A615 GRADE
- STATE AND LOCAL AGENCIES MAY HAVE VARIOUS REQUIREMENTS FOR APPROACH RAMP LENGTH, PITCH, AND 3) FOR CLEAN OUT HEIGHT. PLEASE CHECK WITH ALL AGENCIES PRIOR TO CONSTRUCTION.
- MONOLITHIC POUR OF SLAB AND PIERS IS ALLOWED AT CONTRACTOR'S DISCRETION.
- DEVELOP AND MAINTAIN SITE GRADES WHICH WILL RAPIDLY DRAIN SURFACE AND ROOF RUN-OFF AWAY FROM FOUNDATION
- FOOTINGS HAVE BEEN DESIGNED FOR A MINIMUM SOIL PRESSURE OF 3000 PSF, IT WILL BE THE RESPONSIBILITY OF OTHERS TO VERIFY THIS VALUE.
- WHERE REINFORCING BARS ARE SHOWN CONTINUOUS, LAP SPLICE BARS 40 DIAMETERS.
- APPROACHES TO BE A COMMON PLANE WITHIN 1/4".

  IF FROST CAN PENETRATE BELOW FOUNDATION, AT LEAST


  18 INCHES OF WELL DRAINED, COMPACTED BASE MATERIAL

  MUST BE PROVIDED UNDER FOUNDATION

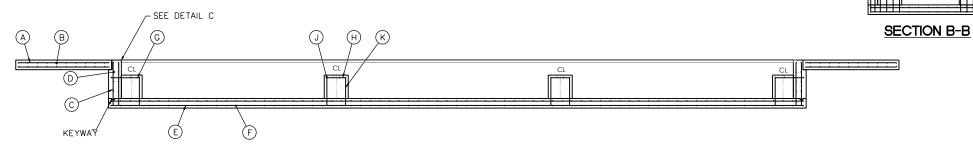

### SECTION A-A

SCALE: 1"=20' (H) 1"=10' (V)

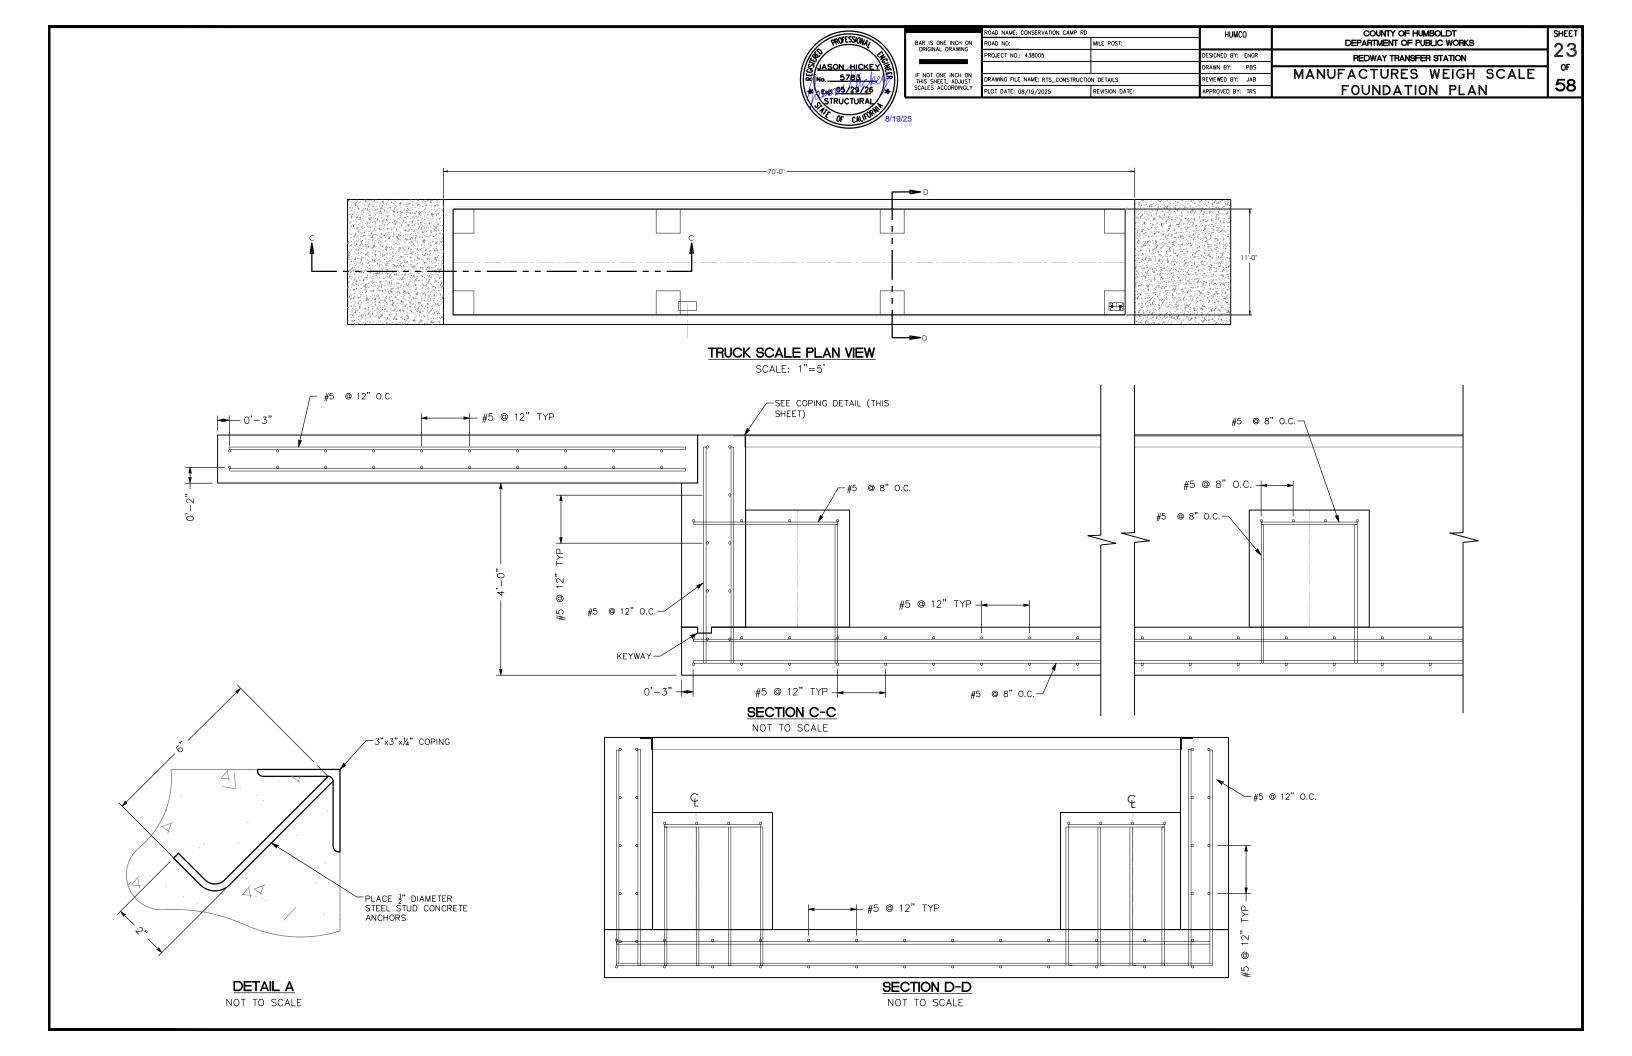


### COUNTY OF HUMBOLDT HUMCO DEPARTMENT OF PUBLIC WORKS ROAD NO: MILE POST: GENERAL NOTES: ROJECT NO.: 438005 DESIGNED BY: ENGR REDWAY TRANSFER STATION DRAWN BY: PBS GENERAL DRAWING FILE NAME: RTS DETAILS AND CROSS SECTIONS REVIEWED BY: JAB CONSTRUCTION DETAILS ALL WORK SHALL COMPLY WITH LOCAL CODES, CALTRANS 2024 LOT DATE: 08/19/25 PROVED BY: TRS STANDARDS AND SPECIFICATION, AND APPLICABLE ASTM - FENCE INSTALLATION TO BE COMPLETED PER MANUFACTURER'S RECOMMENDATIONS AND STANDARD INDUSTRY PRACTICES. CONTRACTOR TO VERIFY ALL FENCE LOCATIONS AND PROPERTY BOUNDARIES PRIOR TO INSTALLATION. ANY DISCREPANCIES SHALL BE REPORTED TO THE RESIDENT **GATE NOTES:** FRAME MATERIAL GRADE AS PER WRITTEN SPECIFICATIONS. PIPE SECTIONS FOR POSTS, BRACES, AND GATES SHALL BE SCHEDULE 40 GALVANIZED PIPE. 2. ALL MATERIAL SHOWN SHALL BE NEW GALVANIZED STEEL UNLESS OTHERWISE NOTED. GATE DIMENSIONS AND POST LOCATIONS ARE NOMINAL AND ARE TO BE FIELD VERIFIED PRIOR TO INSTALLATION. SECURITY GATE, AND ALL NEW LENGTH OF FENCE, SHALL INCLUDE 3 **GATE PLAN** STRANDS OF BARBED WIRE ON TOP. GALVANIZED DEVICES FOR HOLDING BARBED WIRE IN PLACE MUST CHAIN LINK GATE FRAMES SHALL BE A MINIMUM OF 1-7/8" PIPE WEIGHING 2.72 LBS/FT. MATERIAL AND CONSTRUCTION SHALL MEET CALTRANS 2024 STANDARD PLAN A85A AND A86, AT A MINIMUM, OR APPROVED EQUAL.

SHEET

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### **POST SPACING (TP)** GATE OPENING (GO) (SEE SHT. 25 TABLE I) (SEE SHT. 25 TABLE I) T6061-T6 ALUM. TRUSS TRAC GATES CAN BE INSTALLED ENCLOSED (TWO SIDES) **OVERALL GATE LENGTH** NOT TO SCALE (REF. PAGE 24.1 TABLE I) CHAIN LINK FABRIC -2" x 9 GA. KK (REF. NOTE 6) TRUCK ASSEMBLY 3 STRAND BARBWIRE 2" SQ. x 1/8" 6063-T52 ALUM. — (SEE SHT. 25 DETAIL VIEW A) (SEE SHT. 25 DETAIL VIEW C) VERTICAL FOR DRIVE INTERNAL VERTICALS RAIL ATTACHMENT -POST CAP 2" x 5" x 1/8" ALUM. — 1" x 2" x 1/8" 6063-T52 ALUM. -TOP GUSSET TOP HORIZONTAL INTERMEDIATE VERTICALS TYP AT EACH BAY (PLACED VERTICAL) -POST TYP 6063-T52 ALUM. END **VERTICAL MEMBERS -**TENSION BAR 2" SQ x 1/4" ALUM. HORIZONTAL BRACE UL COLLECTOR 3"(TYP)-FINISHED GRADE CABLE TRUSSING FOOTINGS AS -6' MAX.BAY WIDTH -BOTTOM GUSSET ASSEMBLY PER SPECIFICATIONS (TYP) TYP AT EACH BAY 5" X 2 3/4" x .320/190 (SEE SHT. 25 6061-T6 ALUM CHANNEL-DETAIL VIEW D ) BOTTOM HORIZONTAL LOWER GUIDE BRKT. ASSY. (SEE SHT. 25 DETAIL VIEW B) **└BOTTOM TENSION WIRE**

**GATE ELEVATION** 

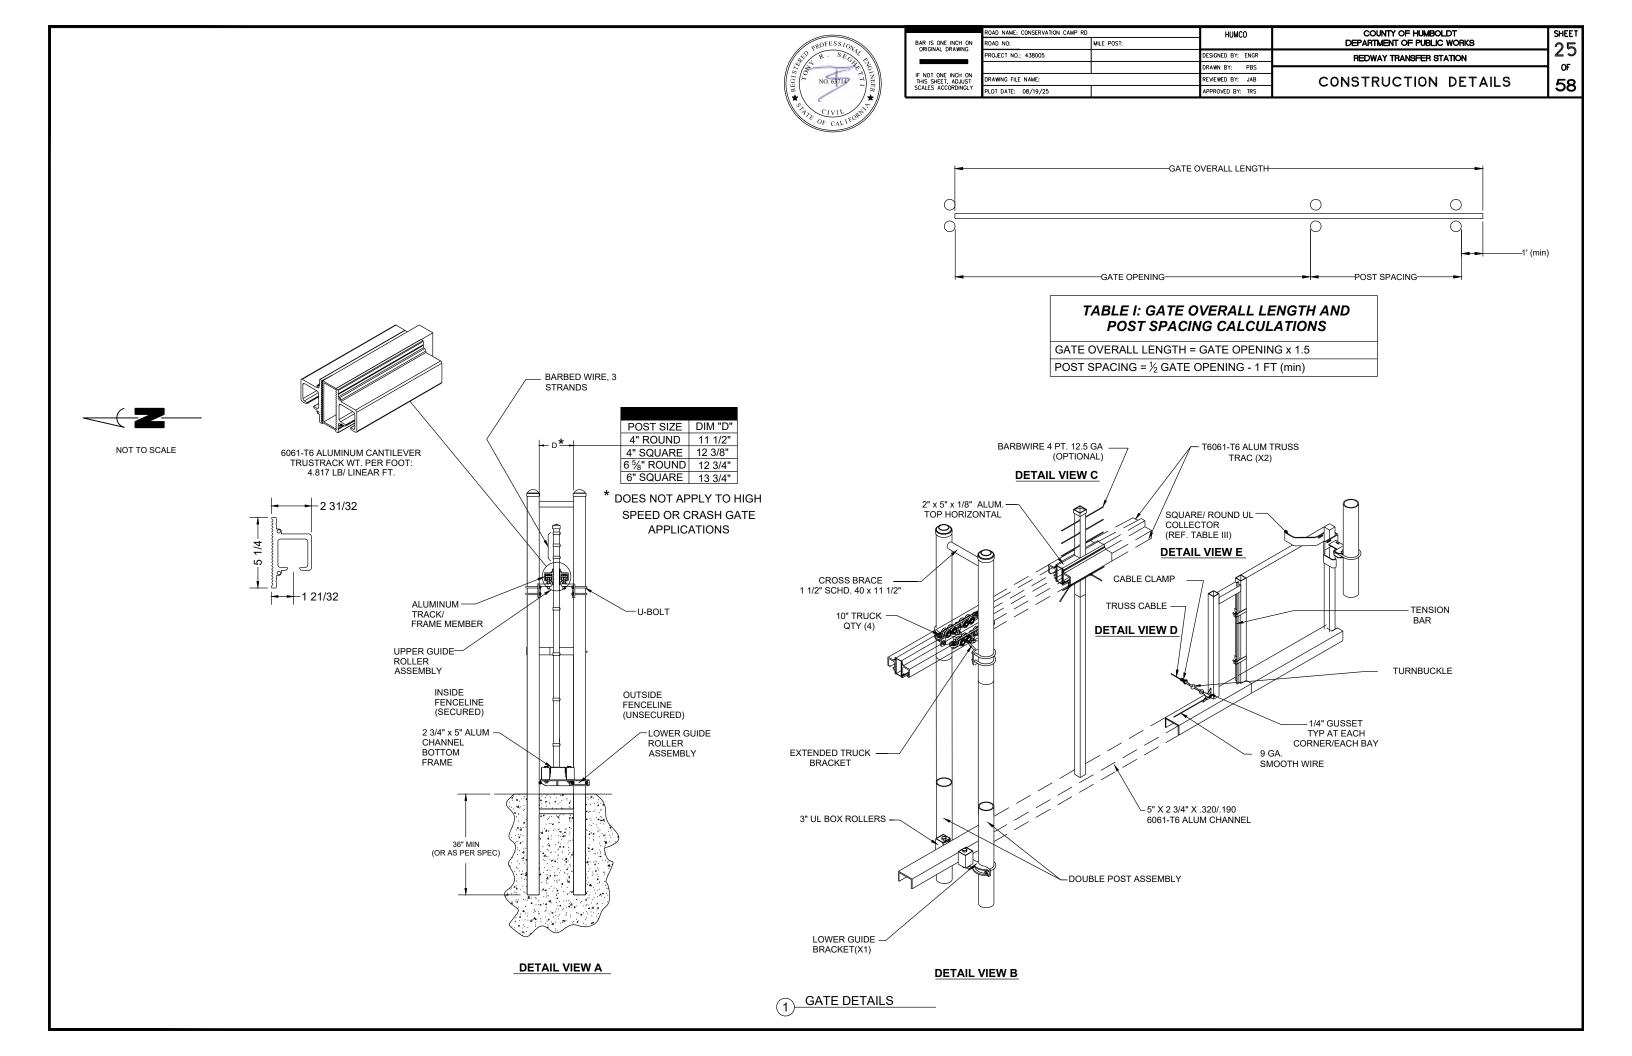

### GENERA NOTES:

- GENERAL
- ALL WORK SHALL COMPLY WITH LOCAL CODES, CALTRANS 2024 STANDARDS AND SPECIFICATION, AND APPLICABLE ASTM STANDARDS
- FENCE INSTALLATION TO BE COMPLETED PER MANUFACTURER'S RECOMMENDATIONS AND STANDARD INDUSTRY PRACTICES.
- CONTRACTOR TO VERIFY ALL FENCE LOCATIONS AND PROPERTY BOUNDARIES PRIOR TO INSTALLATION.
- . ANY DISCREPANCIES SHALL BE REPORTED TO THE RESIDENT ENGINEER OR HUMBOLDT COUNTY PUBLIC WORKS PERSONNEL

### CHAIN LINK SECURITY FENCE NOTES:


- PIPE SECTIONS FOR POSTS, RAILS, BRACES AND GATES SHALL BE SCHEDULE 40 GALVANIZED PIPE MANUFACTURES IN CONFORMANCE WITH ASTM F 1083.
- CHAIN LINK GATE FRAMES SHALL BE A MINIMUM OF 1-7/8" PIPE WEIGHING 2.72 LBS/FT.
- 3. DIMENSIONS SHOWN ARE NOMINAL
- BARBED WIRE FOR SECURITY FENCING SHALL HAVE FOUR POINTS BARBS AND IN CONFORMANCE WITH ASTM A 121.
- 5. BARBED WIRE SHALL BE COMMERCIAL QUALITY CLASS 1 12-1/2 GAGE, CLASS 2 13-1/2 GAGE, OR CLASS 3 12-1/2 GAGE.
- GALVANIZED BOLTS AND NUTS FOR ATTACHING BRACES AND STRAPS TO GALVANIZED DEVICES FOR HOLDING BARBED WIRE IN POSITION MUST BE COMMERCIAL QUALITY.
- 7. LINE AND CORNER POSTS SHALL INCLUDE 3 STRANDS OF BARBED WIRE FOR THE LENGTH OF THE FENCE.


### METAL T-POST FENCE NOTES:

- 1. FENCE TYPE
- FENCE TO CONSIST OF COMMERCIAL—GRADE METAL T—POSTS WITH THREE STRANDS OF TWO PINT BARBED WIRE SPACED AT 10" APART AND ONE SMOOTH WIRE AT THE BOTTOM AT 14" FROM FINISH GROUND.
- WIRE TYPE: STANDARD DOUBLE STRAND BARBED WIRE.
- MINIMUM WIRE SIZE: 12-1/2 GAUGE WITH 14 GAUGE OR HEAVIER TWO-POINT BARBS SPACED NOT MORE THAN 5 INCHES APART.
- MINIMUM PROTECTIVE COATING: CLASS I GALVANIZED COATING PER ASTM A121.
- STRAND-BREAKING STRENGTH: MINIMUM 850 POUNDS OR 60,000 PSI TENSILE STRENGTH.
- BOTTOM WRE: 12.5-GAUGE GALVANIZED SMOOTH WIRE FOR ANIMAL SAFETY OR PER PROJECT REQUIREMENTS.
- TOTAL FENCE HEIGHT: [INSERT HEIGHT, E.G., 5 FEET] ABOVE FINISHED GRADE.
- 2. POST INSTALLATION
- T-POSTS SHALL BE SPACED AT A MAXIMUM OF 10 FEET ON CENTER UNLESS NOTED OTHERWISE.
- T-POSTS SHALL BE DRIVEN TO A MINIMUM DEPTH OF 2.5 FEET, OR AS REQUIRED FOR STRUCTURAL STABILITY.
- ALL TERMINAL AND CORNER POSTS SHALL BE GALVANIZED SCHEDULE 40 STEEL PIPE SET IN CONCRETE FOOTINGS.
- BRACING ASSEMBLIES (H-BRACES OR DIAGONAL TENSION BRACING) TO BE PROVIDED AT CORNERS AND END POSTS.
- 3. WIRE INSTALLATION
- THREE STRANDS OF WIRE SHALL BE EVENLY SPACED BETWEEN THE TOP AND BOTTOM OF THE FOURTH STRAND.
- BOTTOM STRAND SHALL CONSIST OF SMOOTH WIRE TO REDUCE INJURY RISK FOR ANIMALS OR PERSONNEL.
- WIRE SHALL BE PULLED TAUT, FREE OF SLACK, AND ATTACHED TO EACH POST USING GALVANIZED CLIPS, PRE-FORMED WIRE TIES, OR SIMILAR FASTENERS APPROVED BY THE MANUFACTURER.
- BARBS SHALL FACE OUTWARD FROM THE SECURED AREA UNLESS OTHERWISE DIRECTED BY THE RESIDENT ENGINEER OR HUMBOLDT COUNTY PUBLIC WORKS PERSONNEL.
- 4. CLEARING & GRADING
- CLEAR FENCE LINE OF ALL VEGETATION, ROCKS, AND OBSTRUCTIONS TO A MINIMUM WIDTH OF 3 FEET.
- GRADE MINOR RISES AND DEPRESSIONS TO ALLOW FENCE WIRE TO CLOSELY FOLLOW TERRAIN WITHOUT EXCESSIVE GAPS.
- 5. FINISH & PROTECTION
- ALL WIRE AND METAL COMPONENTS SHALL HAVE CORROSION-RESISTANT COATINGS.
- FIELD REPAIRS TO COATINGS MUST BE MADE USING COLD GALVANIZING COMPOUND OR MANUFACTURER—APPROVED PAINT.



	ROAD NAME: CONSERVATION CAMP RD		HUMCO	COUNTY OF HUMBOLDT
BAR IS ONE INCH ON ORIGINAL DRAWING	ROAD NO:	MILE POST:		DEPARTMENT OF PUBLIC WORKS
ORIGINAL DRAWING	PROJECT NO.: 438005		DESIGNED BY: ENGR	REDWAY TRANSFER STATION
			DRAWN BY: PBS	
CALES ACCORDING	DRAWING FILE NAME:		REVIEWED BY: JAB	CONSTRUCTION DETAILS
	PLOT DATE: 08/19/25		APPROVED BY: TRS	

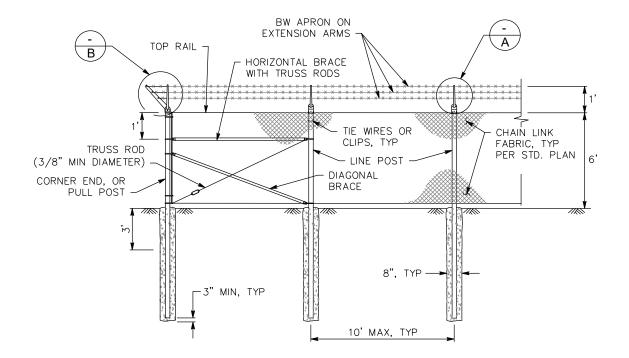


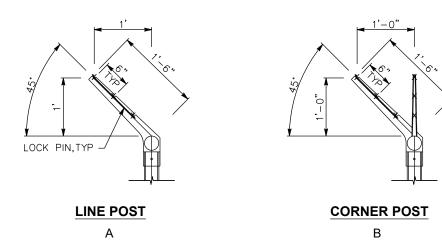

3 BARBED WIRE (POST TOP)
NOT TO SCALE

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## 2 CHAIN LINK SECURITY FENCE, TYPICAL DETAIL NOT TO SCALE

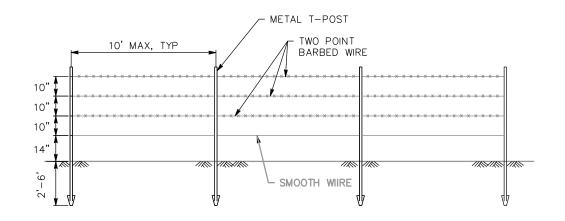


4 METAL T-POST FENCE, TYPICAL DETAIL SCALE: NTS





- 1. SP = 2024 CALTRANS STANDARD PLANS SS = 2024 CALTRANS STANDARD SPECIFICATION
- THE CEMEMENTITIOUS MATERIAL CONTENT TO CONFORM WITH SECTION 90-2.01D OF STATE OF CALIFORNIA DEPARTMENT OF TRANSPORTATION 2024 STANDARD SPECIFICATIONS.



	ROAD NAME: CONSERVATION CAMP RD		HUMCO	COUNTY OF HUMBOLDT	SHEET
BAR IS ONE INCH ON ORIGINAL DRAWING	ROAD NO:	MILE POST:		DEPARTMENT OF PUBLIC WORKS	
	PROJECT NO.: 438005		DESIGNED BY: ENGR	REDWAY TRANSFER STATION	
SCALES ACCORDINGLY			DRAWN BY: PBS		OF
	DRAWING FILE NAME:		REVIEWED BY: JAB	CONSTRUCTION DETAILS	58
	PLOT DATE: 08/19/25		APPROVED BY: TRS	CONTROL TON DETAILS	

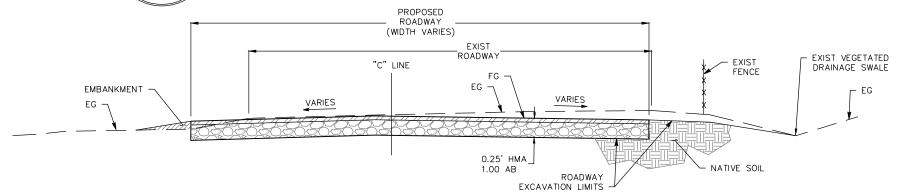

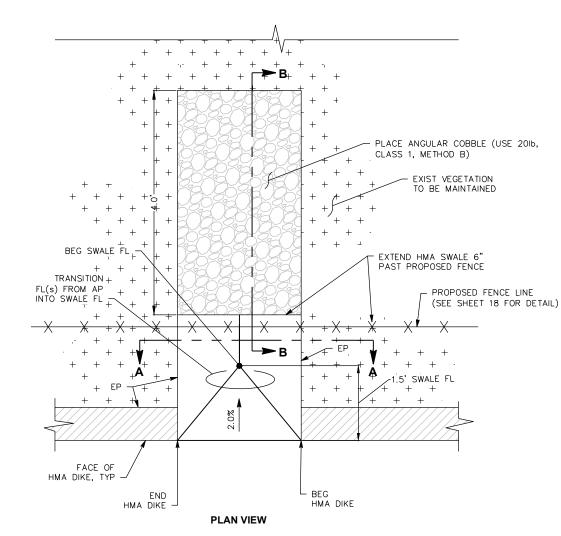

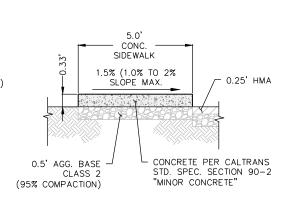


### **TYPICAL SIDEWALK**

### TYPICAL ROADWAY SECTION 3.0' CONC. VALLEY NOT TO SCALE 0.25' HMA 1.50' 0.5' CLASS A CONCRETE VARYING CUT 0.25' HMA SLOPE LEVEL LINE 1.0' AGG. BASE 1.0' AGG. AT 95% COMPACTION BASE AT 1.25' O.C. EACH WAY CONCRETE PER CALTRANS -STD. SPEC. SECTION 90-2 "MINOR CONCRETE"


EXTEND FINAL/TOP LIFT OF HMA FROM DRIVE AISLE UNDER THE DIKE WITH NO JOINT AT THE EP/FL.


NOTE: DETAIL SHOWN DEFINES HMA AREAS OUTSIDE PARKING STALLS, WITH FLOW TOWARDS THE EP/FL. PARKING STALL HMA (AND PCC-NOT SHOWN IN DETAIL) AREAS WOULD VARY, WITH DRAINAGE FLOWING AWAY FROM MOST EP LOCATIONS.

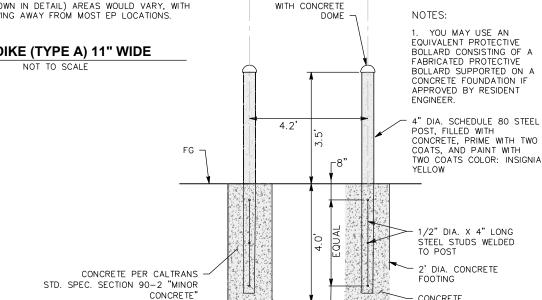

HMA DIKE (TYPE A) 11" WIDE

### HMA SWALE FL TRANSITION AND ROCK DISAPATOR NOT TO SCALE

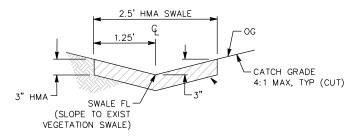

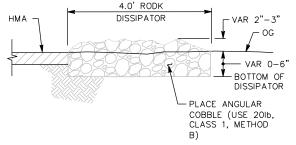

**SECTION A-A** NOT TO SCALE

**SECTION B-B** NOT TO SCALE

**PROTECTIVE BOLLARD** NOT TO SCALE

✓ SWALE FL

1/2" DIA. X 4" LONG STEEL STUDS WELDED TO POST 2' DIA. CONCRETE

FOOTING

CONCRETE

**CONCRETE VALLEY GUTTER** 

NOT TO SCALE


FINISH TOP




	ROAD NAME: CONSERVATION CAMP RD.		DESIGN SECTION	COUNTY OF HUMBOLDT	
ORIGINAL DRAWING	ROAD NO:	MILE POST:	ENGINEERING	DEPARTMENT OF PUBLIC WORKS	
	PROJECT NO.: 438005		DESIGNED BY: ENGR	REDWAY TRANSFER STATION	
TALES ACCORDINGLY			DRAWN BY: PBS	WEICH STATION DINIDING	
	DRAWING FILE NAME: RTS_WEIGH SHACK		REVIEWED BY: TRS	WEIGH STATION BUILDING	
	PLOT DATE: 08/19/2025		APPROVED BY: JAB	ELEVATION PLAN	

SHEET


OF 56

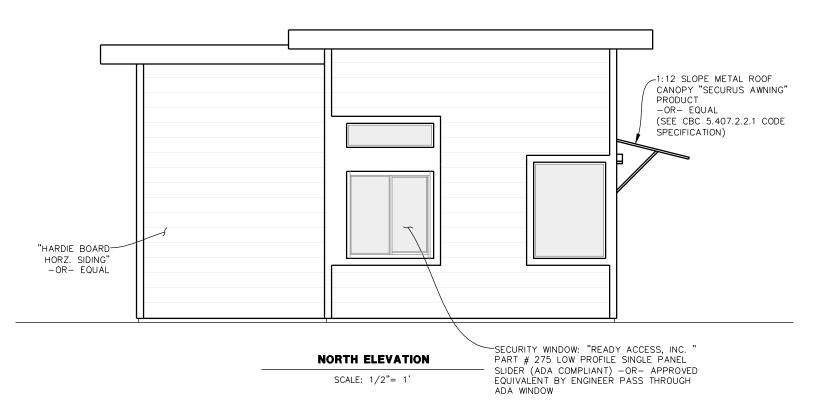


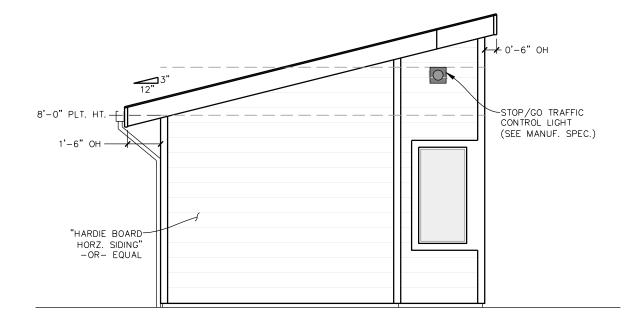

### **EAST ELEVATION**

SCALE: 1/2"= 1'

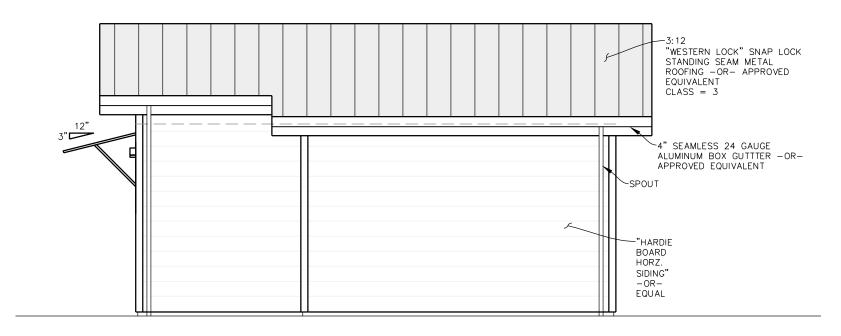


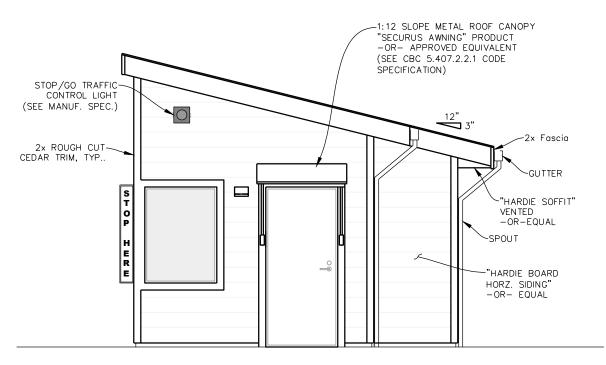

#### **SOUTH ELEVATION WEST ELEVATION**

SCALE: 1/2"= 1'

SCALE: 1/2"= 1'

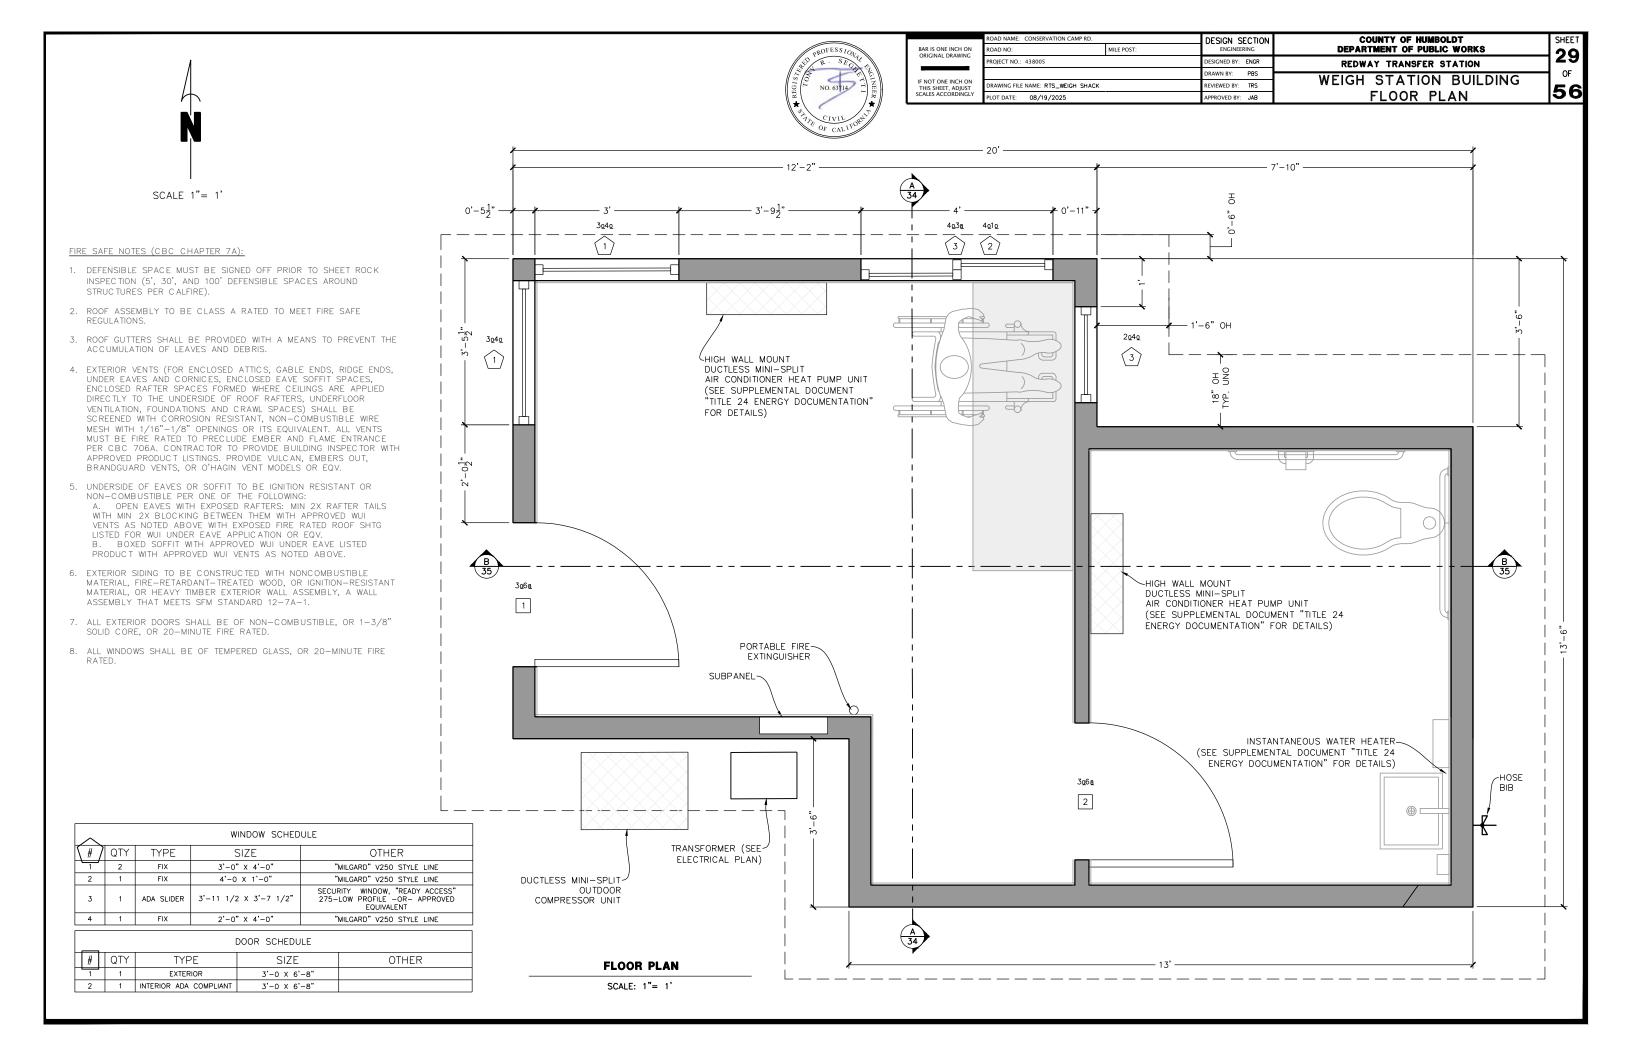

### LIGHTING NOTES:

- 1. ALL LIGHTING FIXTURES NOTED, OR EQUIVALENT, ARE TO BE INSTALLED PER SPECIFICATIONS BY THE
- 2. LIGHTING PLAN IS DIAGRAMMATIC IN NATURE AND REQUIRES COORDINATION AMONG TRADES.
- 3. VERIFY EXACT EQUIPMENT AND FIXTURES WITH OWNER PRIOR TO INSTALLATION.
- 4. SEE ELECTRICAL PLAN FOR LUMINAIRE SCHEDULE.



	ROAD NAM
BAR IS ONE INCH ON ORIGINAL DRAWING	ROAD NO:
ORIGINAL DRAWING	PROJECT NO
IF NOT ONE INCH ON THIS SHEET, ADJUST	DRAWING F
SCALES ACCORDINGLY	PLOT DATE

	DESIGN SECTION	ROAD NAME: CONSERVATION CAMP RD.		
DEP#	ENGINEERING	MILE POST:	AD NO:	
RED	DESIGNED BY: ENGR	PROJECT NO.: 438005		
WEIGI	DRAWN BY: PBS			
WEIGI	REVIEWED BY: TRS	DRAWING FILE NAME: RTS_WEIGH SHACK		
E	APPROVED BY: JAB		DT DATE: 08/19/2025	

ARTMENT OF PUBLIC WORKS DWAY TRANSFER STATION H STATION BUILDING

COUNTY OF HUMBOLDT

LECTRICAL PLAN

SHEET

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SCALE 1"= 1'

### **ELECTRICAL LEGEND:**



DUPLEX CONVENIENCE OUTLET MOUNTED +18" OR SPECIFIED ABOVE FINISH FLOOR TO BOX CENTER UNO. 120 VOLT UNLESS SPECIFIED. SUBSCRIPTS:

GFCI — GROUND FAULT CIRCUIT INTERRUPTER

WP - WEATHER PROOF IG - ISOLATED GROUND

a - SMALL-CASE LETTER FOR SWITCHED OUTLETS "TIED" TO SWITCHED LIGHTING. BLANK OR "u" IS UNSWITCHED.

240V - 240 VOLT. WIRE RECEPT. TO CKT # SHOWN USING #12 CONDUCTORS.



DOUBLE DUPLEX RECEPTACLE



RECESSED CAN LIGHT



S=SMOKE ALARM, SEE LFS.



SMOKE & CARBON MONOXIDE ALARM-SEE LFS



EXHAUST FAN



CEILING MOUNT MOTION DETECTOR - SEE LS F - FAN LIGHT



TELEPHONE OUTLET -- MOUNT +18" AFF UNO BOX BOX AND BLANK PLATE ONLY WITH 3/4" CONDUIT STUB TO ACCESSIBLE LOCATION ABOVE CEILING OR BELOW FLOOR, OR AS SHOWN ON PLANS.



DATA OUTLET -- BOX AND CONDUIT AS ABOVE



PH & DATA -- BOX AND CONDUIT AS ABOVE



EXTERIOR MOTION SENSOR LIGHT



EXTERIOR WALL MOUNT FIXTURE - SEE LFS



WALL SWITCH--MOUNT +42" AFF TO BOX CENTER SUBSCRIPTS:

1 = SINGLE POLE 3 = THREE WAY

D = DIMMERK = KEY OPERATED


4 = FOUR WAY

P = PILOTWP = WEATHERPROOF MS = MOTION SENSOR


a, b, ETC. = SWITCH OPERATES ALL FIXTURES

WITH SAME SUBSCRIPT

/ ELECTRICAL RUN

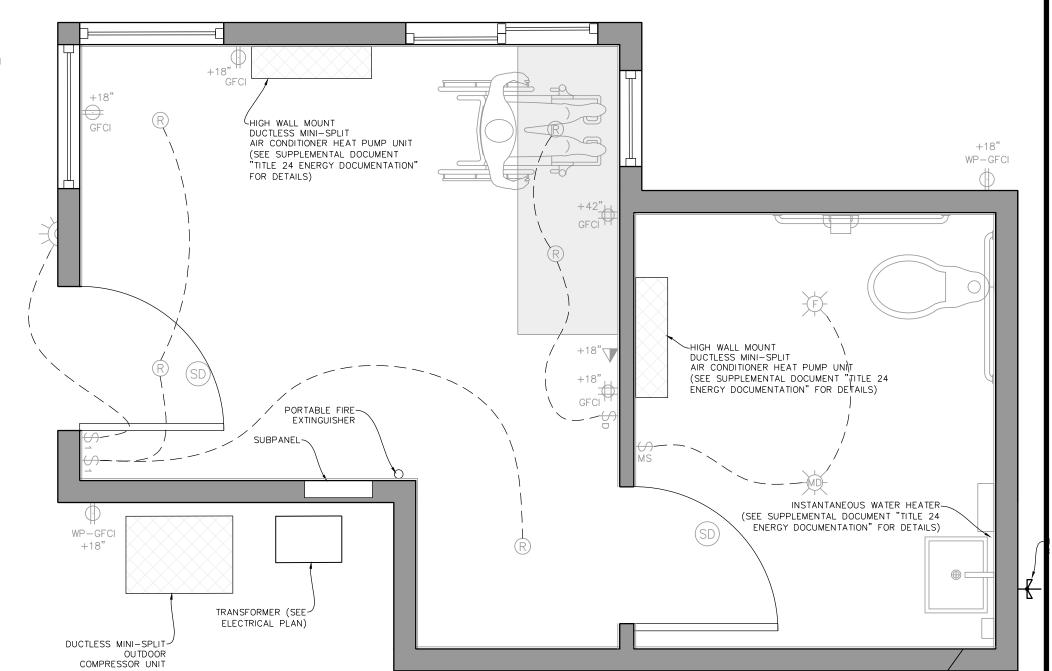

### **ELECTRICAL PLAN**

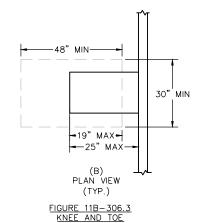

CLEARANCE

SURFACES

34" MAX

27

4" MAX-

\* 8" MIN -

PROVIDE 19" MIN AT WORK

11" MIN

ELEVATION

(TYP.)

-18" MIN <del>-</del>

### ADA LAVATORY (SINK) NOTES:

-25"

6" MAX

9" MIN

WALL SURFACE UNDER 48'

36" MIN REAR GRAB

BAR LENGTH

(TYP.)

NON-ABSORBENT PER (TYP.)

TO BE SMOOTH HARD

8" MIN --

27

11" MIN

ELEVATION @ LAVATORY

34" MAX

29" MIN

- ACCESSIBLE LAVATORIES SHALL BE A MINIMUM 17" IN HORIZONTAL DEPTH AND MOUNTED WITH THE RIM OR COUNTER EDGE NO HIGHER THAN 34" ABOVE FINISH FLOOR.
- 2. CLEAR SPACE IN FRONT OF ACCESSIBLE LAVATORIES SHALL BE A MINIMUM 30" WIDE AND 48" DEEP, AND MAY EXTEND A MAXIMUM OF 19" INTO VERTICAL KNEE AND TOE CLEARANCES AS DESCRIBED BELOW.
- 3. VERTICAL KNEE CLEARANCE UNDER ACCESSIBLE LAVATORIES SHALL BE 29'
  AT THE FRONT EDGE OF THE LAVATORY, REDUCING TO 27" AT A POINT 8"
  BACK FROM THE FRONT EDGE
- BACK FROM THE FRONT EDGE.

  4. VERTICAL TOE CLEARANCE UNDER ACCESSIBLE LAVORATORIES SHALL BE A MINIMUM 9" EXTENDING FROM THE FRONT EDGE OF THE LAVORATORY TO A DISTANCE NO MORE THAN 6" FROM THE BACK WALL.
- HOT WATER AND DRAINPIPES UNDER ACCESSIBLE LAVATORIES SHALL BE INSULATED OR OTHERWISE COVERED. THERE SHALL BE NO SHARP OR ABRASIVE SURFACES UNDER LAVATORIES.
- 6. FAUCET CONTROLS FOR LAVATORIES SHALL BE LEVER TYPE, PUSH TYPE, OR ELECTRONICALLY CONTROLLED MECHANISMS. SELF-CLOSING VALVES MUST MAINTAIN A MINIMUM 10 SECONDS OF OPEN FLOW. REFER TO 'ADA BATHROOM NOTES' FOR ADDITIONAL FAUCET CONTROL REQUIREMENTS.



- 1. THE BATHROOM DOOR SHALL HAVE A PRIVACY LATCH.
- 2. BATHROOM WALL SURFACES SHALL BE SMOOTH, HARD AND NON-ABSORBENT TO 48" IN HEIGHT, AND SHALL NOT BE ADVERSELY AFFECTED BY MOISTURE.
- 3. BATHROOM FLOOR SURFACES SHALL BE SMOOTH, HARD AND NON-ABSORBENT, EXTENDING UPWARD A MINIMUM 5" ONTO WALLS.
- 4. FLUSH VALVES FOR ACCESSIBLE TOILETS AND URINALS SHALL BE LOCATED A MAXIMUM 44" ABOVE FINISH FLOOR, OPERABLE PARTS FOR ALL OTHER TOILET ROOM FIXTURES AND ACCESSORIES SHALL BE LOCATED A MAXIMUM 40" ABOVE FINISH FLOOR
- FLUSH VALVES FOR ACCESSIBLE TOILETS AND URINALS, FAUCET CONTROLS, AND ANY OTHER TOILET ROOM CONTROLS OR OPERATING MECHANISMS SHALL BE OPERABLE WITH ONE HAND WITH NO TIGHT GRASPING, PINCHING, OR TWISTING.
- MAXIMUM PRESSURE TO OPERATE FLUSH VALVES, FAUCET CONTROLS, AND ANY OTHER TOILET ROOM CONTROLS OR OPERATING MECHANISMS SHALL NOT EXCEPT 5 POUNDS—FORCE
- 7. MIRRORS LOCATED ABOVE LAVATORIES SHALL BE INSTALLED WITH THE BOTTOM EDGE A MAXIMUM 40" ABOVE FINISHED FLOOR. MIRRORS NOT LOCATED ABOVE LAVATORIES SHALL BE INSTALLED WITH THE BOTTOM EDGE 35" ABOVE FINISHED FLOOR

ADA LAVATORY AND WORK COUNTER ELEVATION / PLAN VIEW (SCALE N.T.S.)

MIRROR

9" MIN

### ADA TOILET NOTES:


- ACCESSIBLE TOILETS SHALL BE POSITIONED BETWEEN 17" AND 18" FROM THE SIDE WALL OR PARTITION.
- 2. ACCESSIBLE TOILETS SHALL HAVE AN ELONGATED BOWL WITH A
- SEAT HEIGHT BETWEEN 17" AND 19" ABOVE FINISH FLOOR.

  3. CLEAR SPACE IN FRONT OF ACCESSIBLE TOILETS SHALL BE MINIMUM 60" WIDE AND 48" DEEP.
- 4. FLUSH VALVES FOR ACCESSIBLE TOILETS SHALL BE LOCATED ON THE WIDE SIDE OF THE TOILET AREA. REFER TO 'ADA BATHROOM NOTES' FOR ADDITIONAL FLUSH VALVE REQUIREMENTS.
- 5. TOILET PAPER DISPENSERS SHALL BE MOUNTED A MINIMUM OF 1-1/2" CLEAR UNDER THE SIDE GRAB BAR AND A MINIMUM OF 19" ABOVE FINISH FLOOR TO  $\mathbb Q$  OF DISPENSER AND HORIZONTALLY BETWEEN 7" AND 9" FROM THE FRONT EDGE OF THE TOILET SEAT TO THE  $\mathbb Q$  OF THE DISPENSER.
- GRAB BARS SHALL BE PROVIDED IN ACCESSIBLE TOILET COMPARTMENTS ON THE SIDE WALL CLOSEST TO THE TOILET AND ON THE REAR WALL.
- 7. SIDE GRAB BARS IN TOILET COMPARTMENTS SHALL BE MINIMUM 42" IN LENGTH, AND SHALL BEGIN A MAXIMUM 12" FROM THE REAR WALL. THE FRONT END OF A SIDE GRAB BAR SHALL BE POSITIONED A MINIMUM 24" IN FRONT OF THE TOILET AND 54" FROM THE REAR WALL.
- 8. REAR GRAB BARS IN TOILET COMPARTMENTS SHALL BE MINIMUM 36" IN LENGTH, SHALL EXTEND A MINIMUM 12" FROM THE CENTERLINE OF THE TOILET ON THE WALL SIDE AND A MINIMUM OF 24" FROM CENTERLINE ON THE OTHER SIDE. THE SPACE BETWEEN THE REAR GRAB BAR AND THE TOP OF THE TOILET TANK SHALL BE A MINIMUM OF 1-1/2"

### ADA GRAB BAR NOTES:

- THE DIAMETER OR WIDTH OF CIRCULAR GRAB BAR GRIPPING SURFACES SHALL BE 1-1/4" TO 2". ALL GRAB BARS SHALL BE CAPABLE OF SUPPORTING A 250-POUND POINT LOAD, AND SHALL NOT ROTATE WITHIN THEIR FITTINGS.
- 2. ALL GRAB BARS SHALL HAVE 1-1/2" OF CLEARANCE BETWEEN THE BAR & WALL, SHALL HAVE 12" OF CLEARANCE BETWEEN THE BAR AND ANY PROJECTING OBJECT ABOVE THE BAR, SHALL HAVE 1-1/2" OF CLEARANCE BETWEEN THE BAR AND ANY PROJECTING OBJECT BELOW THE BAR, AND SHALL BE MOUNTED BETWEEN 33" AND 36" ABOVE FINISH FLOOR MEASURED TO THE TOP OF THE GRIPPING SURFACE.



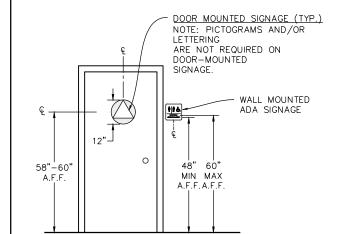

DIFCT NO · 438005

OT DATE: 08/19/2025

WING FILE NAME: RTS\_WEIGH SHACK

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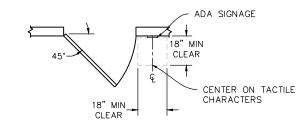


FIGURE 11B-703.4.2
LOCATION OF TACTILE SIGNS AT DOORS

### ADA SIGNAGE NOTES:

DESIGN SECTION

SIGNED BY: ENGR

RAWN BY: PBS

VIEWED BY: TRS

ROVED BY: JAB

 DOOR MOUNTED SIGNS SHALL BE CENTERED ON THE DOOR AND LOCATED BETWEEN 58" AND 60" IN HEIGHT, MEASURED FROM THE FINISHED FLOOR TO THE CENTERLINE OF THE SIGN.

COUNTY OF HUMBOLDT

**DEPARTMENT OF PUBLIC WORKS** 

REDWAY TRANSFER STATION

WEIGH STATION BUILDING

ADA DETAILS

SHEET

31

OF


56


- 2. WALL MOUNTED SIGNS SHALL BE LOCATED 48 INCHES MINIMUM ABOVE THE FINISH FLOOR OR GROUND SURFACE, MEASURED FROM THE BASELINE OF THE LOWEST BRAILLE CELLS AND 60 INCHES MAXIMUM ABOVE THE FINISH FLOOR OR GROUND SURFACE, MEASURED FROM THE BASELINE OF THE HIGHEST LINE OF RAISED CHARACTERS (TEXT).
- 3. UNISEX SANITÀRY FACILITIES SHALL BE IDENTIFIED BY A 12"
  DIAMETER CIRCLE LOCATED ON THE DOOR THAT IS 1/4" THICK WITH
  A 1/4" THICK TRIANGLE SUPERIMPOSED WITHIN THE CIRCLE. THE
  TRIANGLE SYMBOL SHALL CONTRAST WITH THE CIRCLE SYMBOL AND
  THE CIRCLE SYMBOL SHALL CONTRAST WITH THE DOOR, EITHER
  LIGHT ON A DARK BACKGROUND OR DARK ON A LIGHT
  BACKGROUND.
- 4. MEN'S RESTROOM FACILITIES SHALL BE IDENTIFIED BY AN EQUILATERAL TRIANGLE LOCATED ON THE DOOR THAT IS 1/4" THICK WITH EDGES 12" LONG AND VERTEX POINTING UPWARD. THI TRIANGLE SYMBOL SHALL BE MOUNTED CENTERED ON THE DOOR, AND SHALL CONTRAST WITH THE DOOR, EITHER LIGHT ON A DARK BACKGROUND OR DARK ON A LIGHT BACKGROUND.
- 5. WOMEN'S RESTROOM FACILITIES SHALL BE IDENTIFIED BY A CIRCLE LOCATED ON THE DOOR THAT IS 1/4" THICK AND 12" IN DIAMETER THE CIRCLE SYMBOL SHALL BE MOUNTED CENTERED ON THE DOOR, AND SHALL CONTRAST WITH THE DOOR, EITHER LIGHT ON A DARK BACKGROUND OR DARK ON A LIGHT BACKGROUND.
- 6. ACCESSIBLE RESTROOM, SHOWER, AND CHANGING ROOM FACILITIES SHALL BE IDENTIFIED BY THE INTERNATIONAL SYMBOL OF ACCESSIBILITY. THE SYMBOL CONSISTS OF A WHITE FIGURE ON A BLUE BACKGROUND OR ANY LIGHT COLOR ON A DARK BACKGROUND OR DARK COLOR ON A LIGHT BACKGROUND AS APPROVED BY THE BUILDING DEPARTMENT.
- 7. RESTROOM, SHOWER, AND CHANGING ROOM IDENTIFICATION SIGNAGE (I.E., MEN'S, WOMEN'S, ETC.) SHALL BE LOCATED ON THE WALL ADJACENT TO THE LATCH SIDE OF THE DOOR AT A LOCATION THAY ALLOWS A PERSON TO APPROACH WITHIN 3" OF THE SIGNAGE WITHOUT ENCOUNTERING PROTRUDING OBJECTS OR STANDING WITHIN THE SWING OF THE DOOR. THIS CLEAR FLOOR AREA SHALL BE MINIMUM 18" WIDE AND MINIMUM 18" DEEP. WHERE THERE IS NO WALL SPACE AT THE LATCH SIDE OF A SINGLE DOOR OR AT THE RIGHT SIDE OF DOUBLE DOORS, SIGNS SHALL BE LOCATED ON THE NEAREST ADJACENT WALL.
- 8. LETTERS AND NUMERALS SHALL BE SANS—SERIF UPPERCASE CHARACTERS, RAISED 1/32", AND SHALL BE ACCOMPANIED BY GRADE 2 BRAILLE. CHARACTERS SHALL BE A MINIMUM 5/8" HIGH AND A MAXIMUM OF 2" HIGH. BRAILLE DOTS SHALL BE DOMED OR ROUNDED.
- 9. PICTORIAL SYMBOL SIGNS (I.E., PICTOGRAMS), IF UTILIZED IN CONJUNCTION WITH TEXT IDENTIFICATION, SHALL BE LOCATED DIRECTLY ABOVE TEXT DESCRIPTIONS. PICTOGRAM BORDERS SHAL BE A MINIMUM 6" HIGH.
- 10. THE CHARACTERS AND BACKGROUND ON WALL MOUNTED SIGNS SHALL BE EGGSHELL, MATTE, OR OTHER NON-GLARE FINISH, AND THE COLOR AND CONTRAST OF SIGNS SHALL DISTINCTIVELY CONTRAST WITH THE COLOR AND CONTRAST OF THE WALLS UPON WHICH THE SIGNS ARE MOUNTED.

FLUSH VALVE SOAP DISPENSER ON WIDE SIDE 42" MIN SIDE GRAB PAPER TOWER BAR LENGTH DISPENSER PROVIDE SOLID ANCHOR AT 24" i 12" GRAB BARS (TYP.) MIŅ MIN LAVATORY TOILET PAPER 1 -½"\_ DISPENSER W/O STOPS 40"MAX TO MIN MIRROR/ALL MAX OPERÁBLE 33"--36" 29 - 36 PARTS MIN \_#U ADA TOILET W/ 9"MIN-MAX. 2" HIGH TOILET SEAT 5" TALL BASE MIN 60 BOARD OR COVE FLOORING TO RE SMOOTH HARD NON-ABSORBENT

ADA BATROOM ELEVATION (SCALE N.T.S.)

ADA DOOR DETAIL (SCALE N.T.S.)

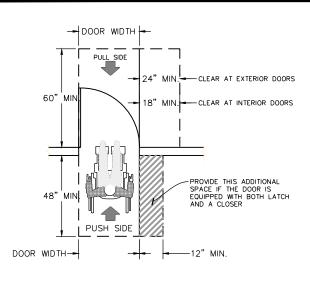

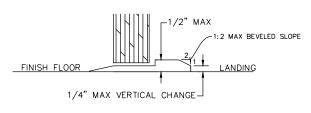

DOOR THRESHOLD DETAIL / MAXIMUM CHANGES IN LEVEL ON ADA PATH

### ADA DOOR/GATE NOTES:

- 1. MANEUVERING CLEARANCE AND LEVEL AREA IN THE DIRECTION OF THE DOOR SWING SHALL BE A MINIMUM OF 60" IN LENGTH.
- 2. MANEUVERING CLEARANCE AND LEVEL AREA IN THE OPPOSITE DIRECTION OF THE DOOR SWING SHALL BE A MINIMUM OF 48" IN
- 3. SURFACE SLOPES OF LEVEL AREAS SHALL NOT EXCEED A 1:48 OR 2% GRADIENT.
- DOORWAYS SHALL HAVE A MIN. CLEAR OPENING OF 32".
- 5. EXIT DOORS SHALL BE CAPABLE OF OPENING A MINIMUM OF 90 DEGREES.
- 6. LEVEL AREAS ON EITHER SIDE OF DOORS SHALL NOT BE MORE THAN 1/2 INCH LOWER THAN THE THRESHOLD OF THE DOORWAY. CHANGE IN LEVEL BETWEEN 1/4 INCH AND 1/2 INCH SHALL BE BEVELED WITH A SLOPE NO GREATER THAN 1 UNIT VERTICAL TO 2 UNITS
- 7. BOTTOM 10 INCHES OF DOOR SHALL HAVE A SMOOTH UNINTERRUPTED SURFACE THAT ALLOWS THE DOOR TO BE OPENED BY A WHEELCHAIR FOOTREST WITHOUT CREATING A TRAP OR HAZARDOUS CONDITION.
- 8. EFFORT TO OPERATE INTERIOR & EXTERIOR DOORS SHALL BE WITHIN 5 POUNDS MAX. PRESSURE AS MEASURED TO THE DOOR FACE AT THE DOOR OPENING HARDWARE OR 30 INCHES FROM THE HINGED SIDE, WHICHEVER IS FARTHER FROM THE HINGE. REQUIRED FIRE DOORS SHALL NO EXCEED 15 POUNDS MAX. PRESSURE.


  9. HANDLES, PULL LATCHES, LOCKS AND OTHER OPERATING DEVICES ON
- ACCESSIBLE DOORS SHALL HAVE A SHAPE THAT IS EASY TO GRASP WITH ONE HAND AND DOES NOT REQUIRE TIGHT GRASPING, TIGHT PINCHING OR TWISTING OF THE WRIST TO OPERATE.
- 10. LATCHING AND LOCKING DOORS THAT ARE HAND OPERATED AND WHICH ARE IN A PATH OF TRAVEL SHALL BE OPERABLE WITH A SINGLE EFFORT BY LEVER TYPE, PANIC BARS, PUSH-PULL ACTIVATING BARS OR OTHER HARDWARE DESIGNED TO PROVIDE
- 11. OPENING HARDWARE SHALL BE 34" MINIMUM AND 44" MAXIMUM
- ABOVE THE FINISHED FLOOR OR GROUND.

  12. DOOR AND GATE CLOSERS, IF PRESENT, SHALL BE ADJUSTED SO THAT FROM THE OPEN POSITION OF 90 DEGREES, THE TIME REQUIRED TO MOVE THE DOOR TO A POSITION OF 12 DEGREES FROM THE LATCH IS 5 SECONDS MINIMUM.

  13. DOOR AND GATE SPRING HINGES, IF PRESENT, SHALL BE ADJUSTED
- SO THAT FROM THE OPEN POSITION OF 70 DEGREES, THE DOOR OR GATE SHALL MOVE TO THE CLOSED POSITION IN 1.5 SECONDS
- 14. RECESSED DOORMATS SHALL BE ADEQUATELY ANCHORED TO
- PREVENT INTERFERENCE WITH WHEELCHAIR TRAFFIC.

  15. CARPET OR TILES ADJACENT TO DOORWAY THRESHOLDS SHALL BE SECURELY ATTACHED TO THE FLOOR SURFACE.

### ADA DOOR PLAN - TYPICAL (SCALE N.T.S.)

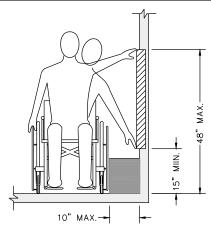


### ADA UNOBSTRUCTED SIDE REACH:

WHERE A CLEAR FLOOR OR GROUND SPACE ALLOWS A PARALLEL APPROACH TO AN ELEMENT AND THE SIDE REACH IS UNOBSTRUCTED, THE HIGH SIDE REACH SHALL BE 48 INCHES MAXIMUM AND THE LOW SIDE REACH SHALL BE 15 INCHESMINIMUM ABOVE THE FINISH FLOOR

EXCEPTIONS: 1. AN OBSTRUCTION SHALL BE PERMITTED BETWEEN THE CLEAR FLOOR OR GROUND SPACE AND THE ELEMENT WHERE THE DEPTH OF THE OBSTRUCTION IS 10 INCHES MAXIMUM.

### ADA UNOBSTRUCTED SIDE REACH

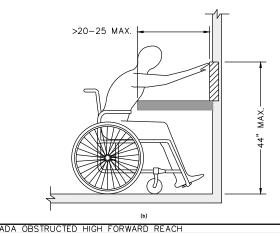

### ADA OBSTRUCTED HIGH FORWARD REACH:

WHERE A HIGH FORWARD REACH IS OVER AN OBSTRUCTION, THE CLEAR FLOOR SPACE COMPLYING WITH SECTION 305 AND KNEE AND TOE CLEARANCE COMPLYING WITH SECTION 306 SHALL EXTEND BENEATH THE ELEMENT FOR A DISTANCE NOT LESS THAN THE REQUIRED REACH DEPTH OVER THE OBSTRUCTION. THE HIGH FORWARD REACH SHALL BE 48 INCHES MAXIMUM ABOVE THE FLOOR WHERE THE REACH DEPTH OVER THE OBSTRUCTION IS 20 INCHES MAXIMUM. THE HIGH FORWARD REACH SHALL BE 44 INCHES MAXIMUM ABOVE THE FLOOR WHERE THE REACH DEPTH OVER THE OBSTRUCTION IS GREATER THAN 20 INCHES AND NOT MORE THAN 25 INCHES MAXIMUM.



IF NOT ONE INCH THIS SHEET, ADJI SCALES ACCORDIN

	ROAD NAME: CONSERVATION CAMP RD.		DESIGN SECTION	COUNTY OF HUMBOLDT	
H ON WING	ROAD NO:	MILE POST:	ENGINEERING	DEPARTMENT OF PUBLIC WORKS	
WING	PROJECT NO.: 438005		DESIGNED BY: ENGR	REDWAY TRANSFER STATION	
			DRAWN BY: PBS	WEIGH STATION BUILDING	
CH ON DJUST	DRAWING FILE NAME: RTS_WEIGH SHACK		REVIEWED BY: TRS		
DINGLY	PLOT DATE: 08/19/2025		APPROVED BY: JAB	ADA DETAILS	


OF 56

ADA BATHROOM DETAIL



	ROAD NAME: CONSERVATION CAMP RD.		DESIGN SECTION	COUNTY OF HUMBOLDT	
BAR IS ONE INCH ON ORIGINAL DRAWING	ROAD NO:	MILE POST:	ENGINEERING	DEPARTMENT OF PUBLIC WORKS	
ORIGINAL DRAWING	PROJECT NO.: 438005		DESIGNED BY: ENGR	REDWAY TRANSFER STATION	
IF NOT ONE INCH ON THIS SHEET, ADJUST SCALES ACCORDINGLY			DRAWN BY: PBS	WEIGH STATION BUILDING	
	DRAWING FILE NAME: RTS_WEIGH SHACK		REVIEWED BY: TRS		
	PLOT DATE: 08/19/2025		APPROVED BY: JAB	ADA DETAILS	
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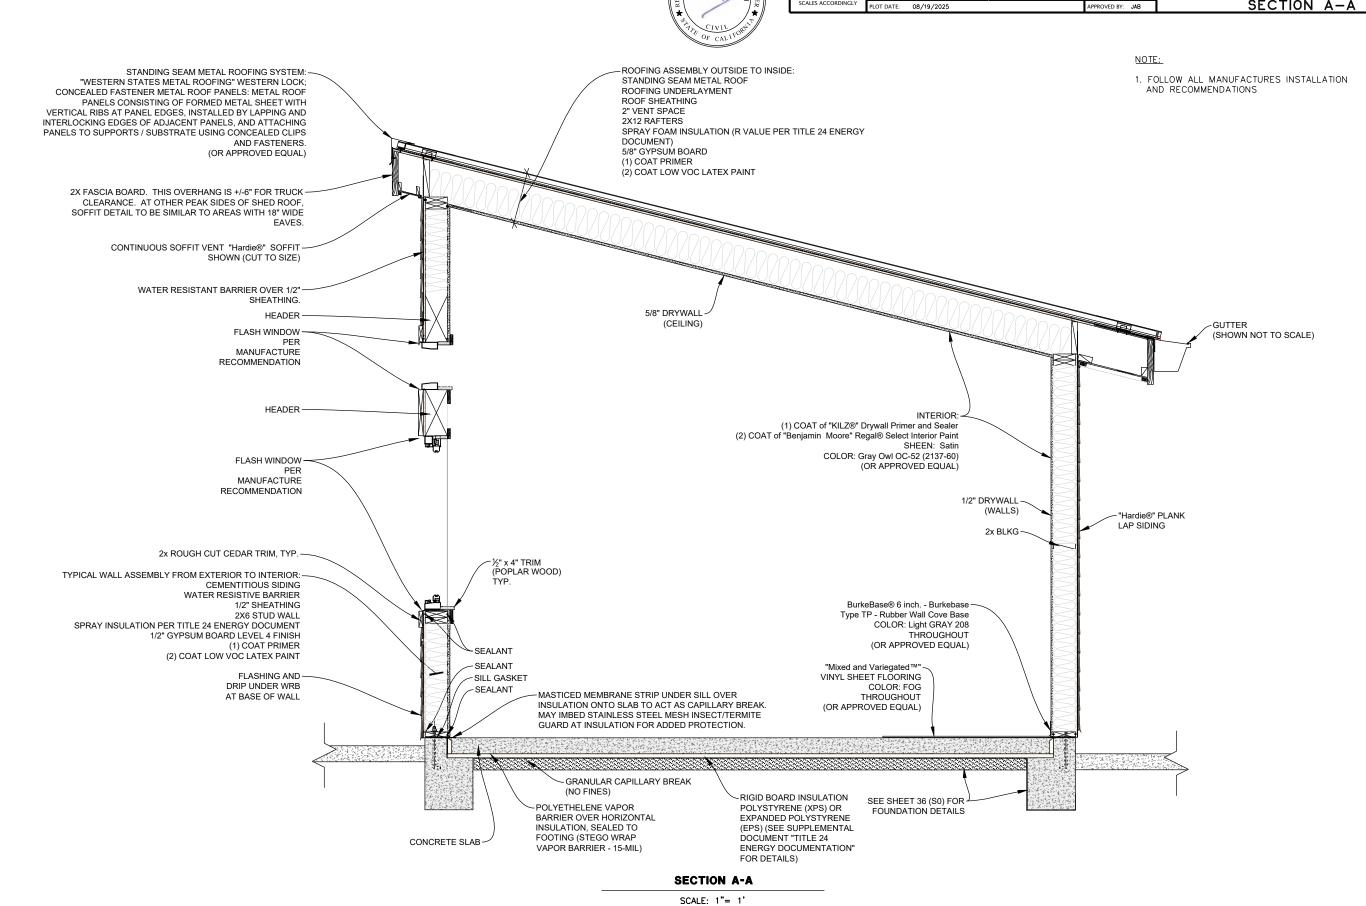
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ADA FLOOR PLAN DETAILS

SCALE: 1"= 1'
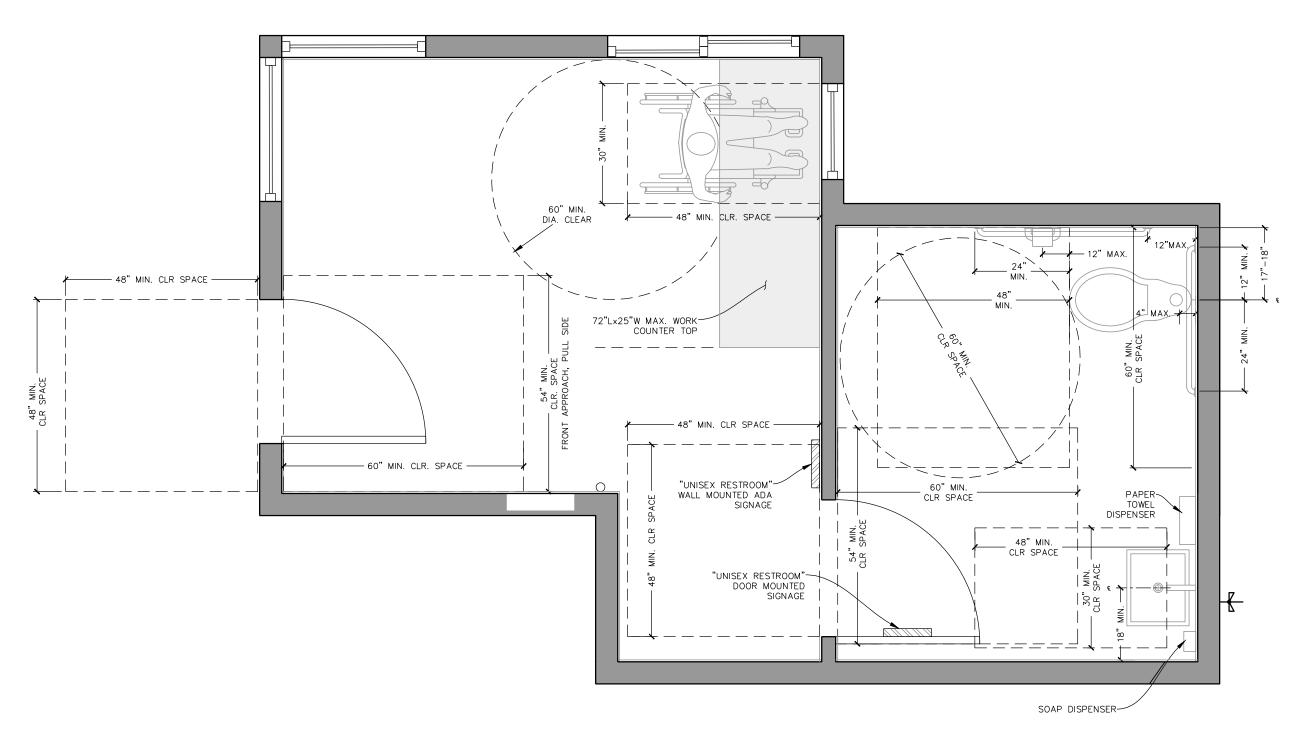
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ORIGINAL DRAWING	ROAD NO:	MILE POST:	ENGINEERING	DEPARTMENT OF PUBLIC WORKS	
	PROJECT NO.: 438005		DESIGNED BY: ENGR	REDWAY TRANSFER STATION	
			DRAWN BY: PBS	WEIGH STATION BUILDING	
	DRAWING FILE NAME: RTS_WEIGH SHACK		REVIEWED BY: TRS		





	ROAD NAME: CONSERVATION CAMP RD.				
BAR IS ONE INCH ON ORIGINAL DRAWING	ROAD NO:	MILE POST:			
ORIGINAL DRAWING	PROJECT NO.: 438005				
IF NOT ONE INCH ON THIS SHEET, ADJUST	DRAWING FILE NAME: RTS_WEIGH SHACK				
SCALES ACCORDINGLY	PLOT DATE: 08/19/2025				

DESIGN SECTION ENGINEERING

DESIGNED BY: ENGR

DRAWN BY: PBS

EVIEWED BY: TRS

PROVED BY: JAB


REDWAY TRANSFER STATION WEIGH STATION BUILDING SECTION B-B


COUNTY OF HUMBOLDT DEPARTMENT OF PUBLIC WORKS

56

SHEET 35

OF

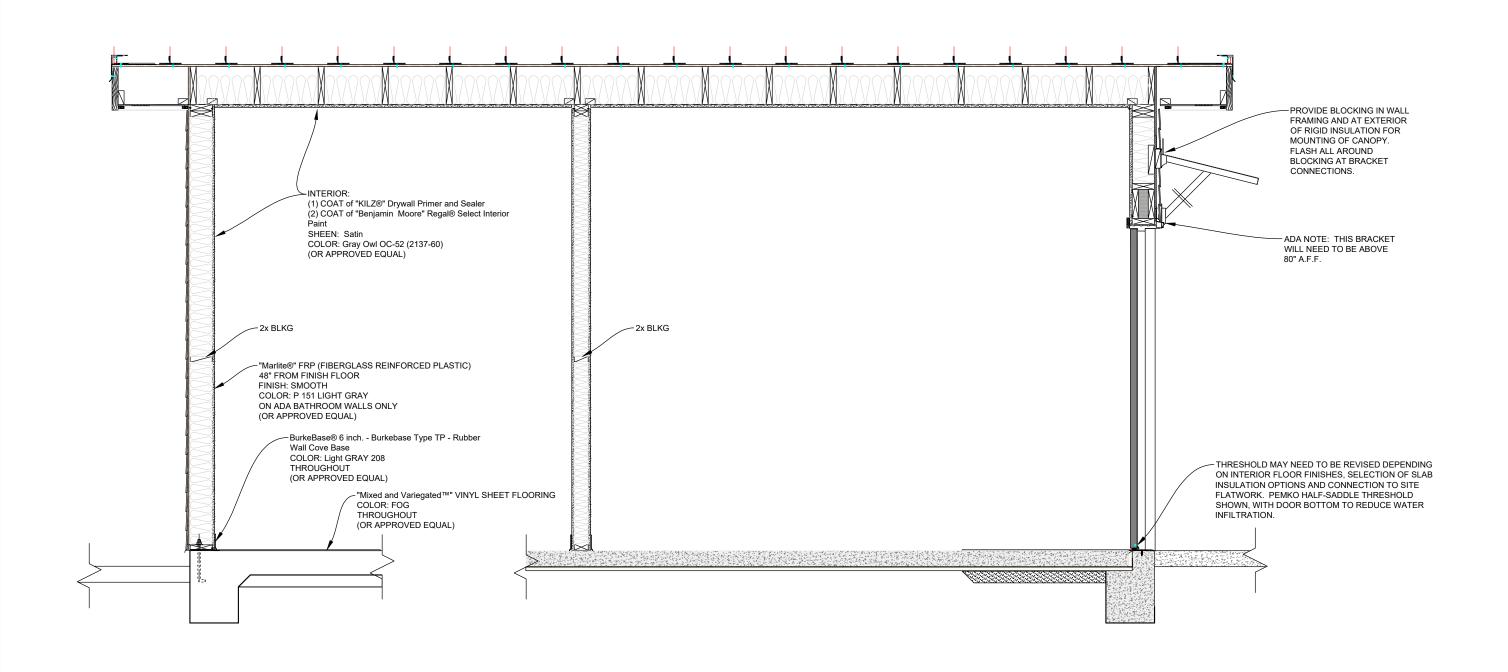

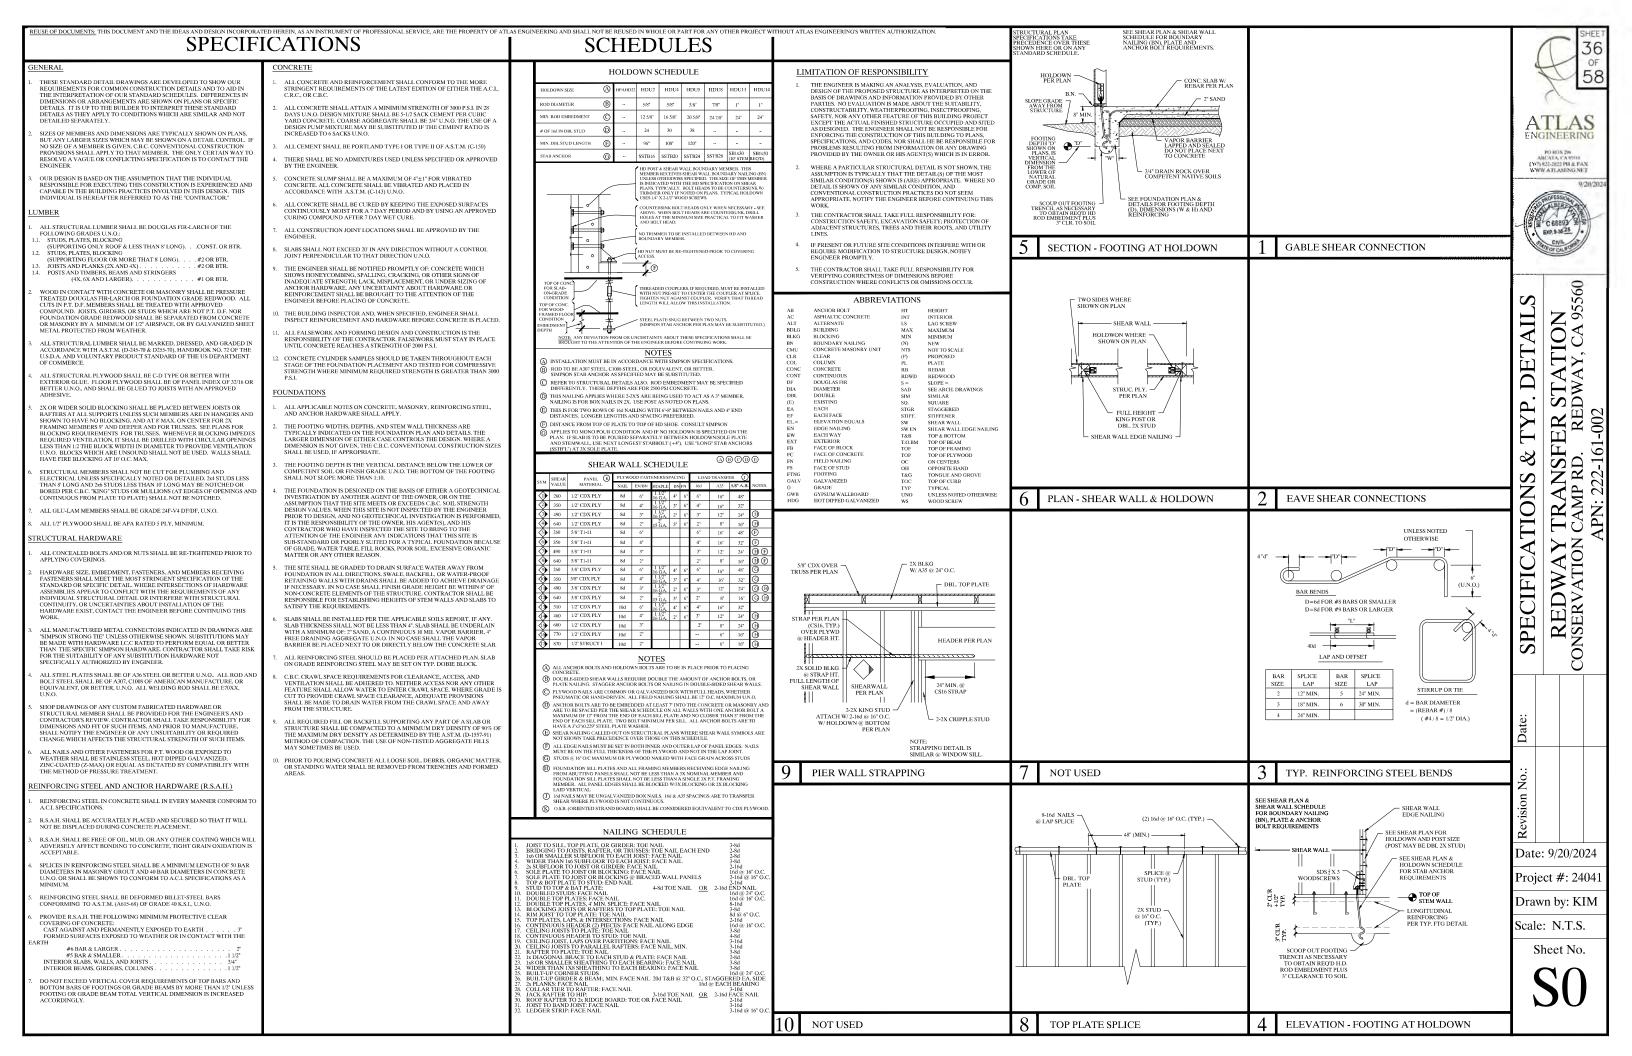

		PECIAL INSPECTIONS & STR	$\cup$	<u> </u>		
		VERIFICATION & INSPECTION	C	P	INSPECTED BY (SIGNATURE)	DATE
2077.0	1.	VERIFY MATERIALS BELOW SHALLOW FOUNDATIONS ARE ADEQUATE TO ACHIEVE THE DESIGN BEARING CAPACITY.		х		
SOILS	2.	VERIFY EXCAVATIONS ARE EXTENDED TO PROPER DEPTH AND HAVE REACHED PROPER MATERIAL.		х		
	1.	INSPECT FORMWORK FOR SHAPE, LOCATION AND DIMENSIONS OF THE CONCRETE MEMBER BEING FORMED.		х		
	2.	INSPECTION OF REINFORCING STEEL & PLACEMENT.		Х		
	a.	OBTAIN MILL CERTIFICATES FOR REINFORCING STEEL, VERIFY COMPLIANCE WITH APPROVED CONSTRUCTION DOCUMENTS, AND VERIFY STEEL SUPPLIED CORRESPONDS TO CERTIFICATE.	-	-		
	3.	INSPECTION OF BOLTS TO BE INSTALLED IN CONCRETE PRIOR TO AND DURING PLACEMENT OF CONCRETE	Х			
CONCRETE	4.	INSPECTION OF ANCHORS INSTALLED/EPOXIED IN HARDENED CONCRETE.		Х		
	5.	VERIFY USE OF REQUIRED DESIGN MIX, 3000 PSI. SAMPLE AND SLUMP ONLY. <sup>6</sup> NOTE: (1) SAMPLE (4-6" CYLINDERS PER 150 CU. YD. OF CONCRETE. (1) SAMPLE PER DAY. (1) SAMPLE PER BATCH/TRUCK IF LESS THAN (5) BATCHES		x		
	6.	INSPECTON OF CONCRETE PLACEMENT	X			
	7.	INSPECTION FOR MAINTENANCE OF SPECIFIED CURING TEMPERATURE AND TECHNIQUES.		Х		
	1.	STRUCTURAL WOOD INSPECTION (NOT REQUIRED WHERE FASTENER SPACING OF THE SHEATHING IS MORE THAN 4" O.C.)				
	a.	SHEARPLY NAILING				
		i. SHEAR WALLS		X		
		ii. FLOOR SHEATHING		Х		
		iii. ROOF SHEATHING		Х		
	b.	HOLDOWN & ANCHOR BOLT INSTALLATIONS		Х		
	c.	LATERAL TIES, STRAPPING & MISC. SHEAR CONNECTORS (INCLUDING DRAG STRUTS & BRACES)		х		
	2.	NON-STRUCTURAL SYSTEMS AND COMPONENTS				
SEISMIC <sup>2</sup> RESISTANCE	a.	OBTAIN CERTIFICATE THAT NON-STRUCTURAL COMPONENTS AND DESIGNATED SEISMIC SYSTEMS HAVE BEEN TESTED PER SECTION 1708.5 OF 2010 CBC.	-	-		
	b.	VERIFY THAT THE EQUIPMENT LABEL AND ANCHORAGE OR MOUNTING CONFORM TO THE CERTIFICATE OF COMPLIANCE WHEN MECHANICAL AND ELECTRICAL EQUIPMENT MUST BE SEISMICALLY QUALIFIED.		x		
	c.	PIPING SYSTEMS AND MECHANICAL UNITS CONTAINING FLAMMABLE, COMBUSTIBLE OR TOXIC MATERIALS (NATURAL GAS)		х		
	d.	STAND-BY POWER SYSTEMS.		Х		
	e.	ANCHORAGE OF NON-EMERGENCY ELECTRICAL EQUIPMENT		Х		
	f.	ANCHORAGE OF STORAGE RACKS 8' OR GREATER IN HEIGHT (WHERE APPLICABLE).		Х		
	g.	SUSPENDED CEILING AND ITS ANCHORAGE (WHERE APPLICABLE).		Х		
GENERAL SPECTIONS	1.	PERIODIC STRUCTURAL OBSERVATION SHALL OCCUR DURING DEMOLITION AND ROUGH FRAMING PRIOR TO COVERING WALLS		x		

### **INSPECTION NOTES:**

- 1) ALL SPECIAL INSPECTIONS SHALL BE PROVIDED BY ATLAS ENGINEERING, UNLESS OTHER ARRANGEMENTS ARE MADE PRIOR TO INSPECTION AND CONFIRMED WITH THE ENGINEER-OF-RECORD. SOILS/EXCAVATION INSPECTIONS SHALL BE PROVIDED BY "CRAWFORD & ASSOCIATES, INC.", (916) 952-6684.
- 2) 48 HOURS NOTICE IS REQUIRED PRIOR TO SPECIAL INSPECTION.
- 3) EACH CONTRACTOR RESPONSIBLE FOR THE CONSTRUCTION OF A MAIN WIND- OR SEISMIC-FORCE-RESISTING SYSTEM, DESIGNATED SEISMIC SYSTEM OR A WIND OR SEISMIC-RESISTING COMPONENT LISTED IN THE STATEMENT OF SPECIAL INSPECTIONS SHALL SUBMIT A WRITTEN STATEMENT OF RESPONSIBILITY TO THE BUILDING OFFICIAL AND THE OWNER PRIOR TO THE COMMENCEMENT OF WORK ON THE SYSTEM OR COMPONENT. THE CONTRACTOR'S STATEMENT OF RESPONSIBILITY SHALL CONTAIN ACKNOWLEDGEMENT OF AWARENESS OF THE SPECIAL REQUIREMENTS CONTAINED IN THE STATEMENT OF SPECIAL
- 4) PROVIDE CONCRETE BATCH PLANT "RECIPE"/MIX DESIGN FOR REVIEW PRIOR TO PLACEMENT.
- 5) PROVIDE CERTIFICATE OF COMPLIANCE FOR ALL MATERIALS (USED FOR SEISMIC RESISTANCE) FOR REVIEW & APPROVAL PRIOR TO CONSTRUCTION.

### EARTHQUAKE DESIGN DATA:

I = 1.00 (OCCUPANCY CATEGORY II)  $S_s = 1.922$   $S_1 = 0.776$ SITE CLASS "D"  $S_{DS} = 1.281$   $S_{D1} = 0.776$ SEISMIC DESIGN CATEGORY "E" BASIC SEISMIC-FORCE-RESISTING SYSTEM(S): A. BEARING WALL SYSTEMS: 13) LIGHT-FRAMED WALLS SHEATHED WITH WOOD STRUCTURAL PANELS RATED FOR SHEAR RESISTANCE (R=6.5) SEISMIC RESPONSE COEFFICIENT,  $C_s = 0.1077(ASD)$ EQUIVALENT LATERAL FORCE PROCEDURE

### FOUNDATION DESIGN DATA:

ALLOWABLE BEARING PRESSURE = 1500 PSF (MIN.)





# TRANSFER STATION CAMP RD. REDWAY, CA 95560 APN: 222-161-002 INSPECTION SCHEDULE

Date: 9/20/2024


Date:


Project #: 24041

Drawn by: KIM

Scale: N.T.S. Sheet No.

LEGEND:

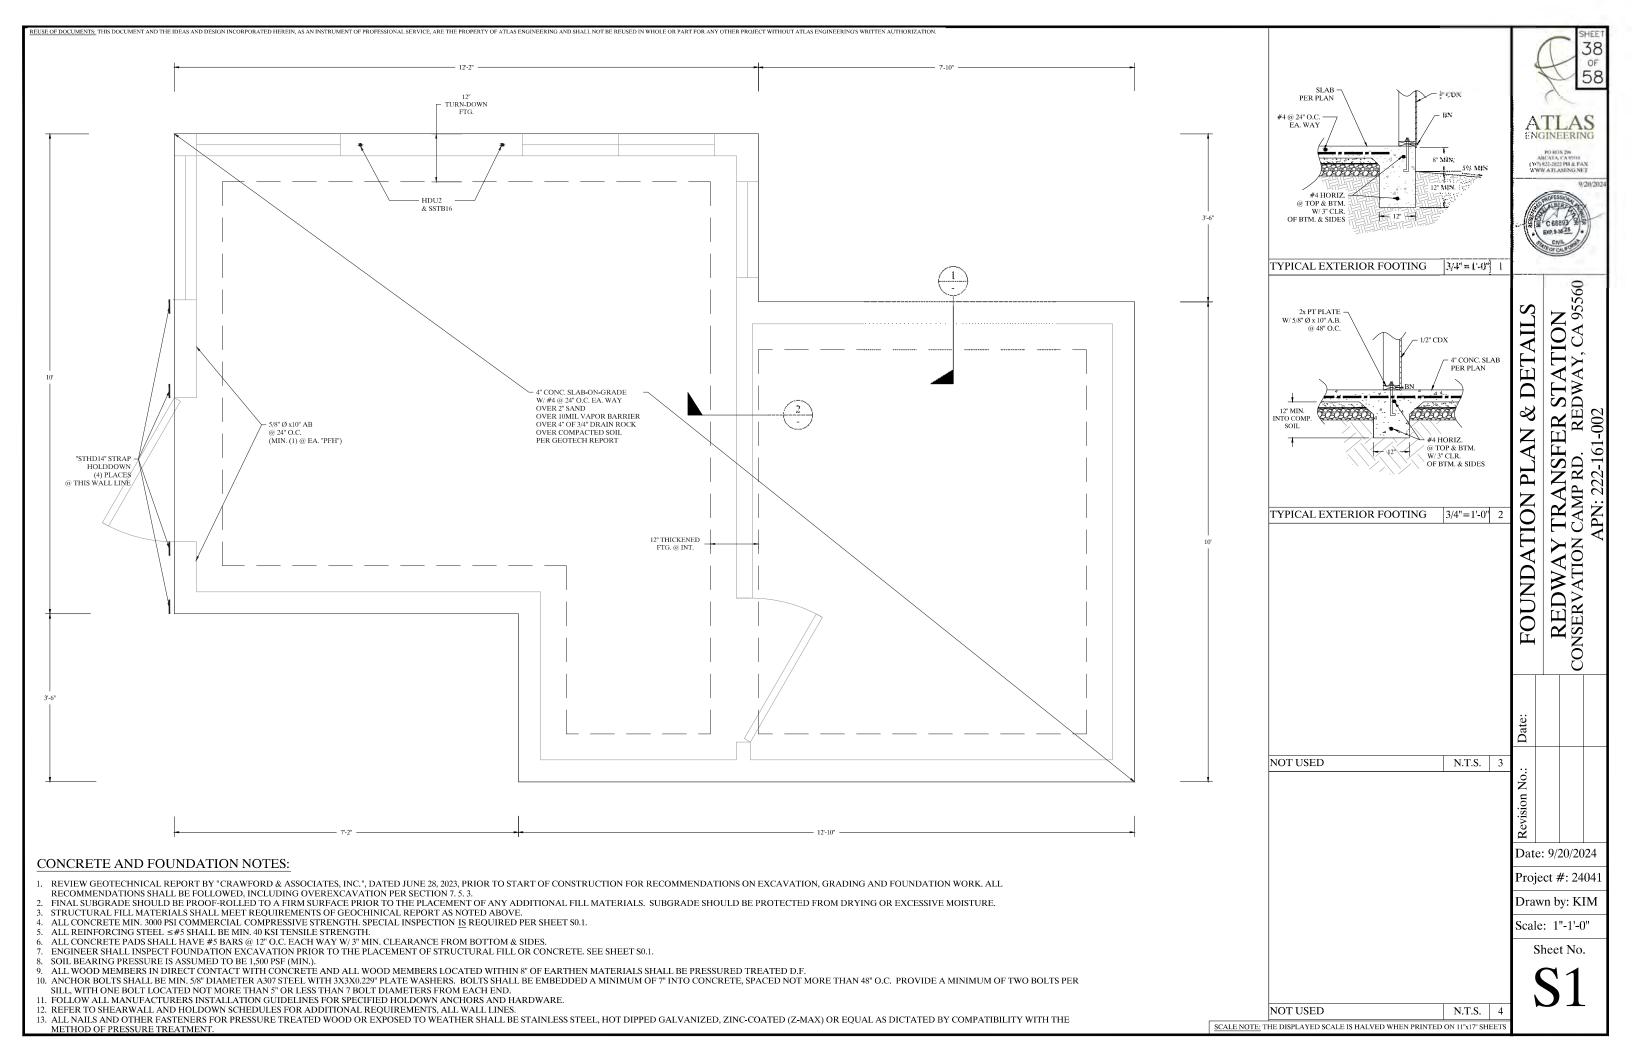

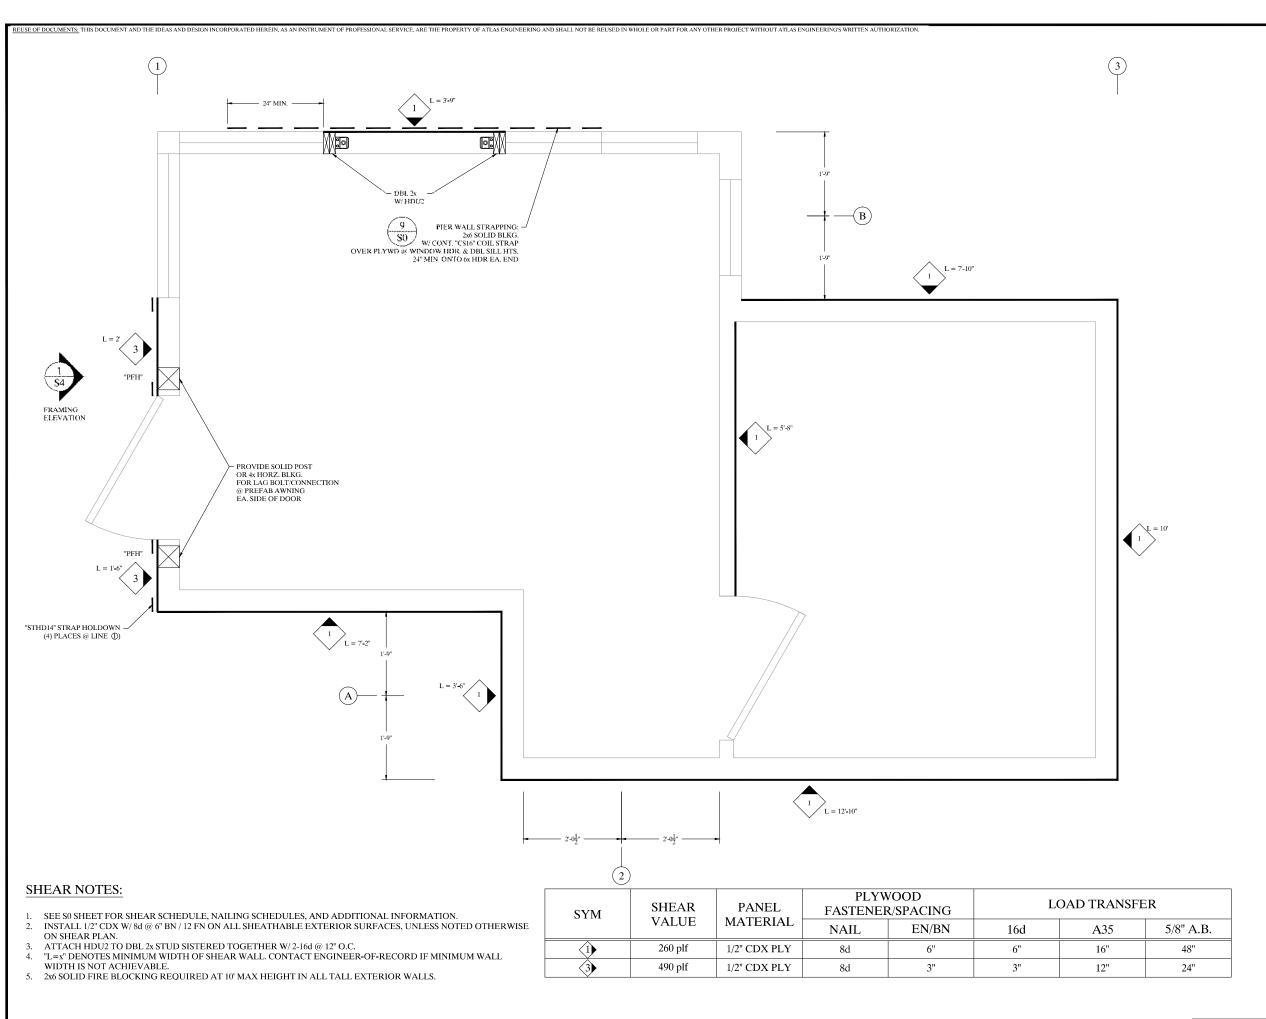

PO BOX 2% ARCATA, CA 95518 [107] 822-2822 PH & FAX WWW ATLASENG.NET




REDWAY TRANSFER STATION
CONSERVATION CAMP RD. REDWAY, CA 95560
APN: 222-161-002 SHEAR PLAN


Date: 9/20/2024 Project #: 24041

Drawn by: KIM

Scale: 1"-1'-0"

Sheet No.

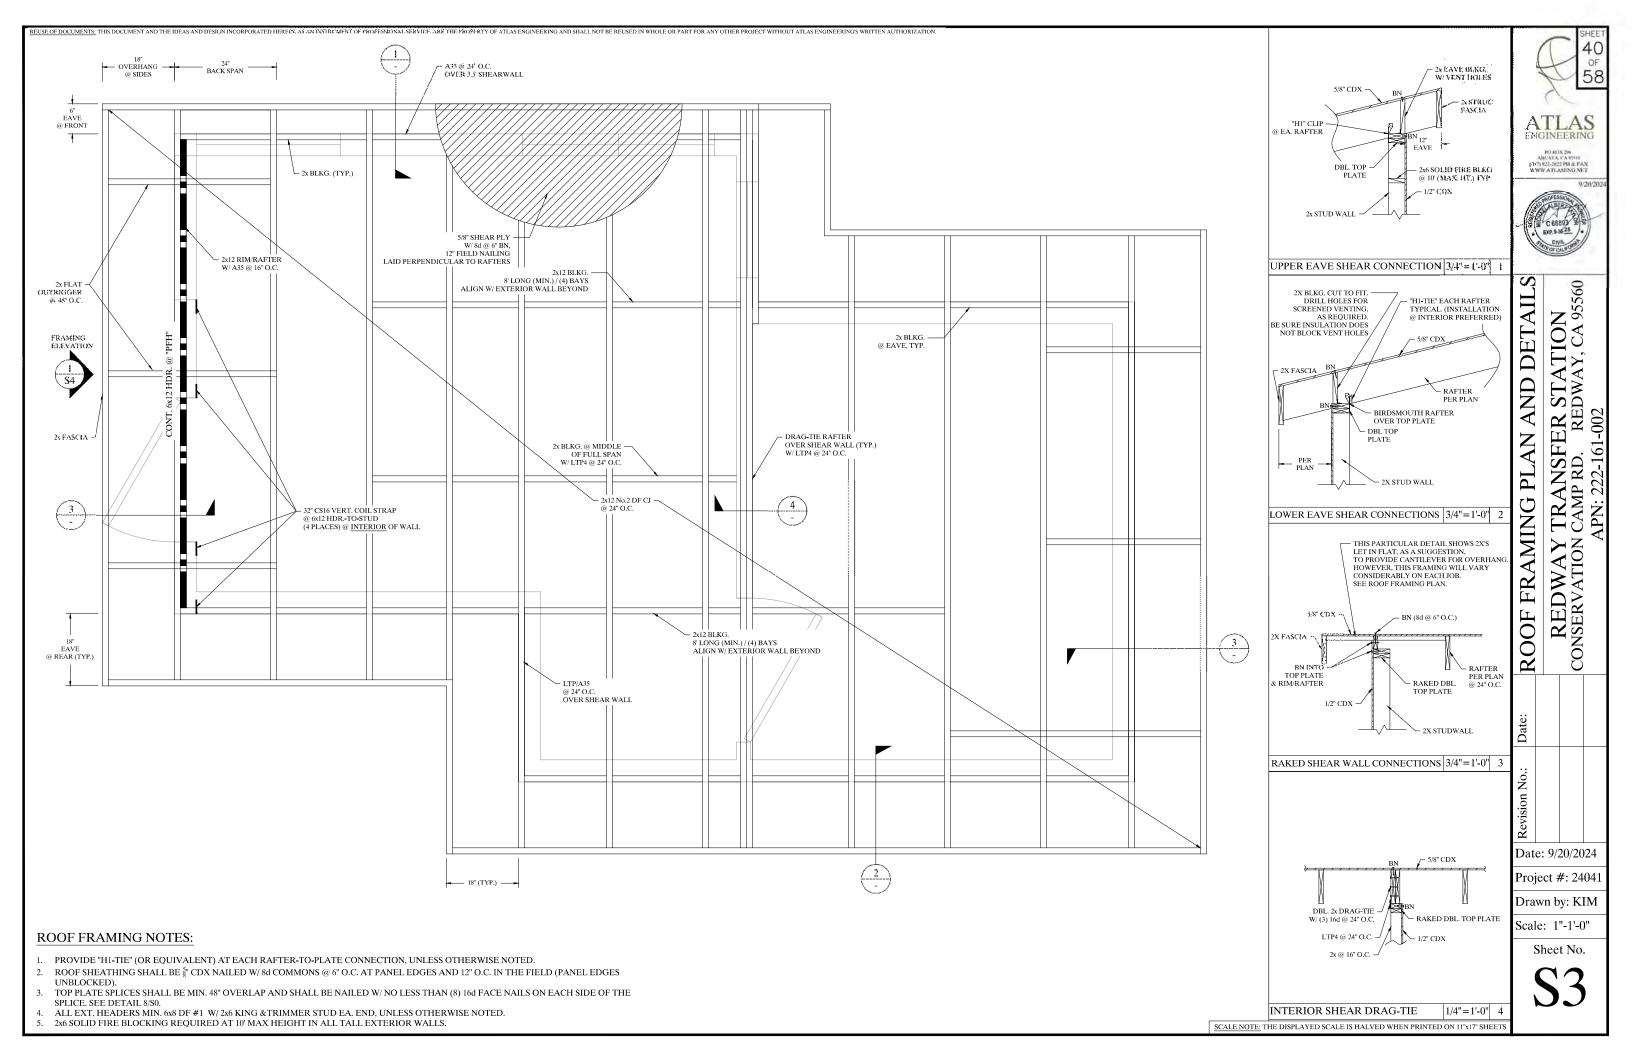

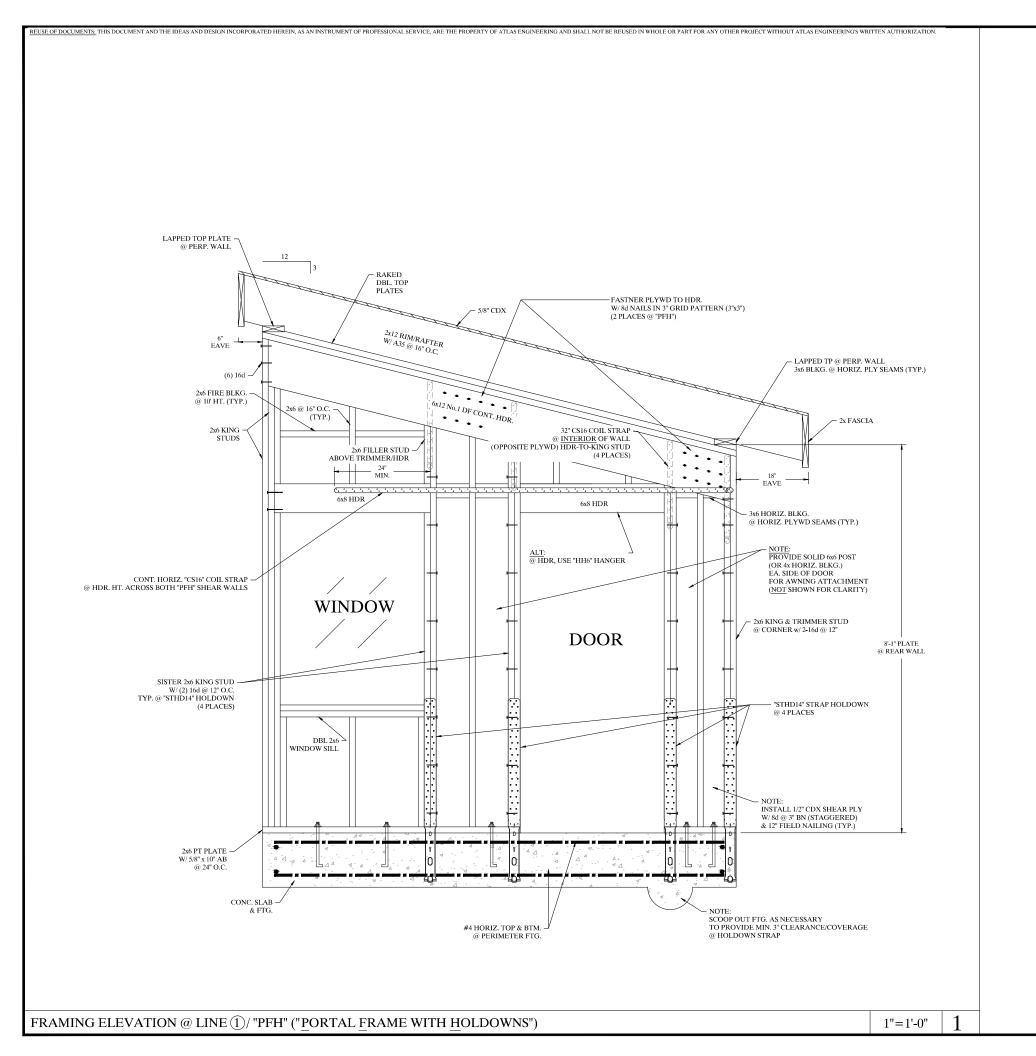

REDWAY TRANSFER STATION
CONSERVATION CAMP RD. REDWAY, CA 95560
APN: 222-161-002

STRUCTURAL DETAILS

Revision No.:


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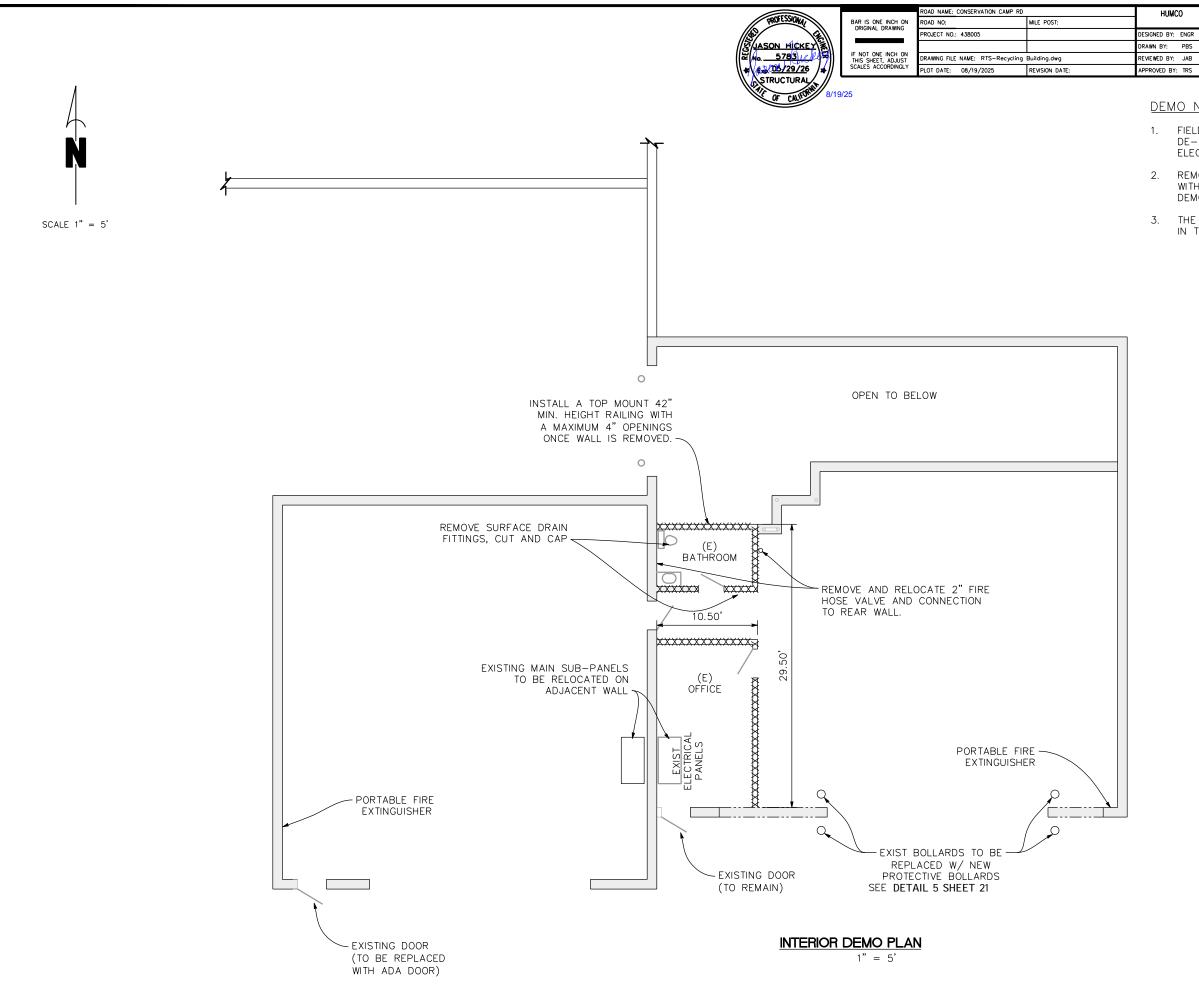
Drawn by: KIM

Scale: 1"=1'-0"

Sheet No.

PO BOX 2% ARCATA, CA 95515 (307) 822-2822 PH & FAX WWW ATLASENG.NET



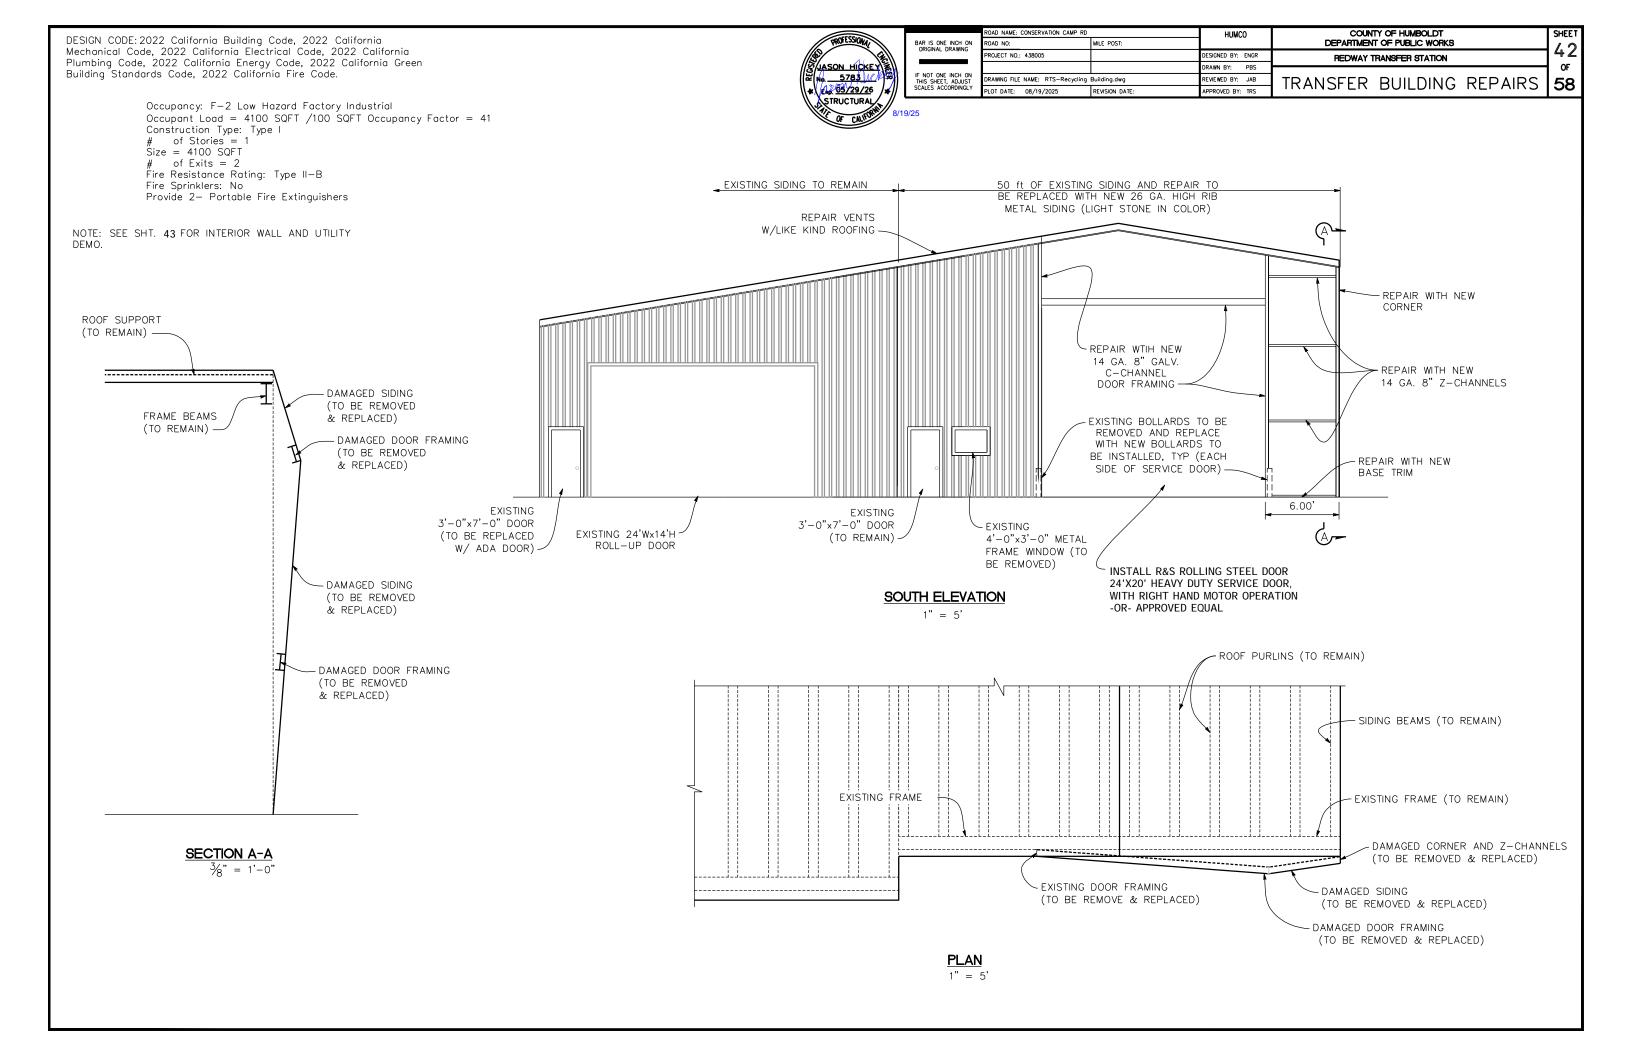

### DEMO NOTES:

1. FIELD VERIFY ALL ELECTRICAL IN OFFICE AND BATHROOM IS DE-ENERGIZED PRIOR TO DEMO. ALSO, SEE SHEET 47 ELECTRICAL PLAN NOTES.

COUNTY OF HUMBOLDT

TRANSFER BUILDING INTERIOR

DEMO PLAN


DEPARTMENT OF PUBLIC WORKS


REDWAY TRANSFER STATION


SHEET

58

- REMOVE ALL FIXTURES, CUT AND CAP ALL UTILITIES FLUSH WITH TOP OF CONCRETE WITHIN THE OFFICE AND BATHROOM DEMO SHOWN AS HATCHED XXXXXXX.
- 3. THE CEILING ABOVE THE BATHROOM AND OFFICE IS INCLUDED IN THE DEMO, BUT NOT SHOWN FOR CLARITY.

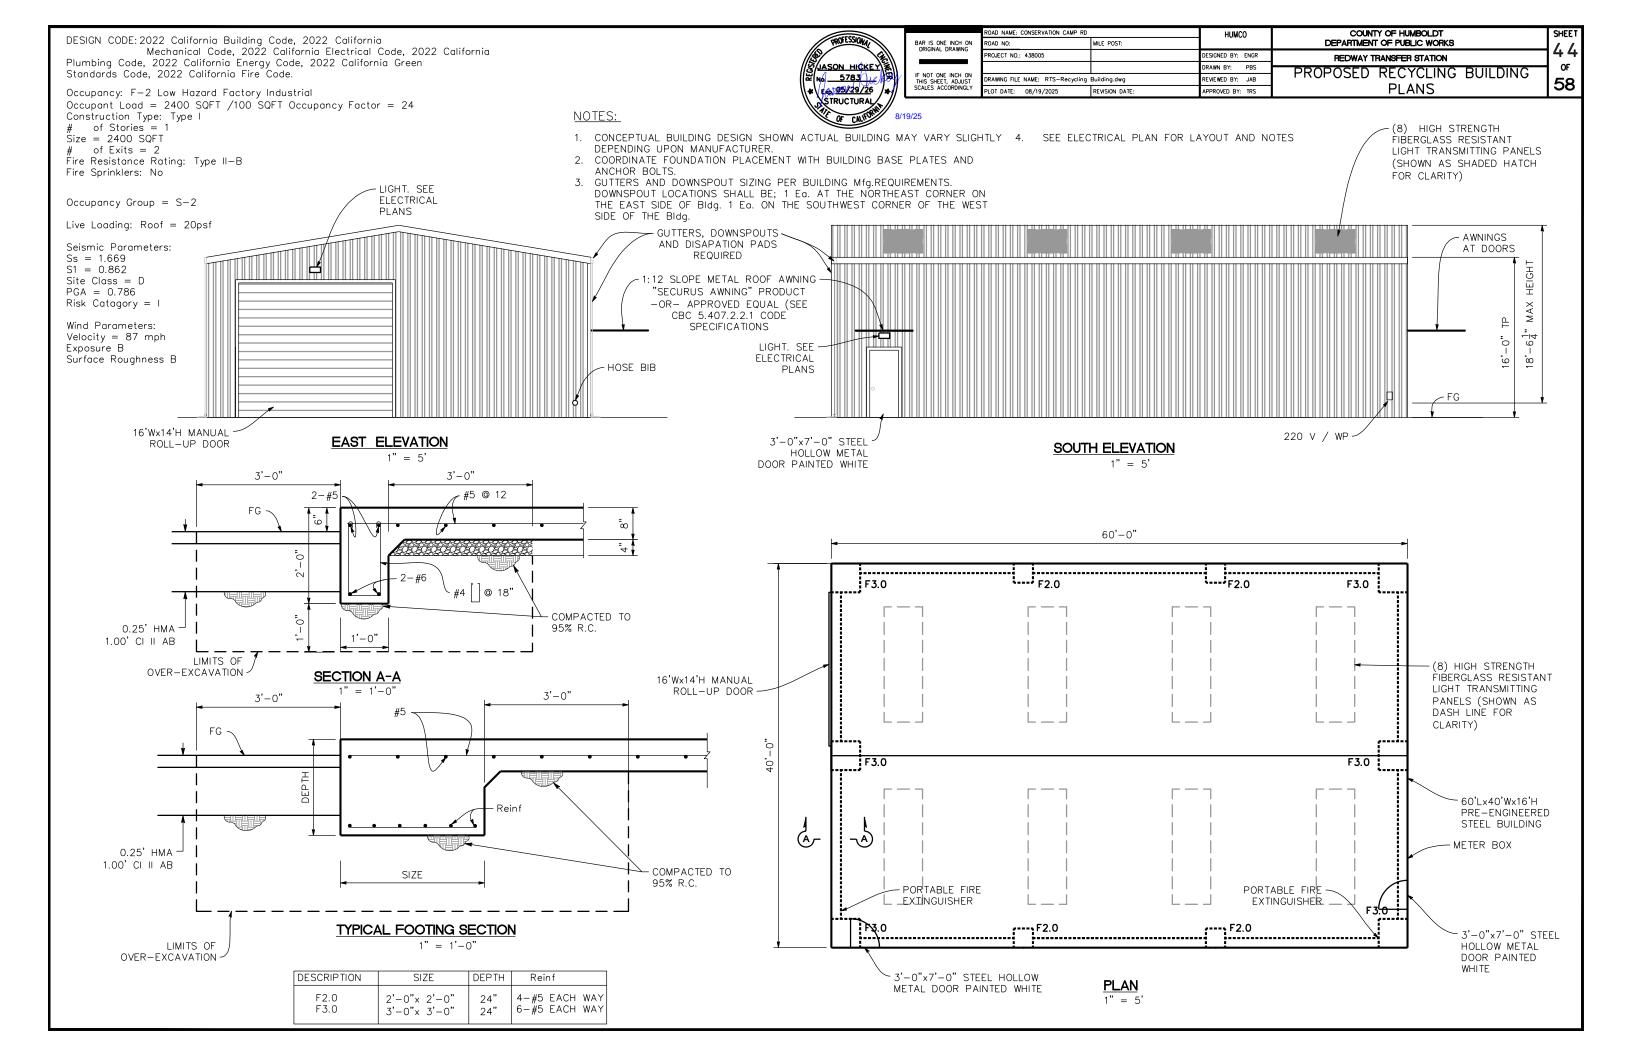

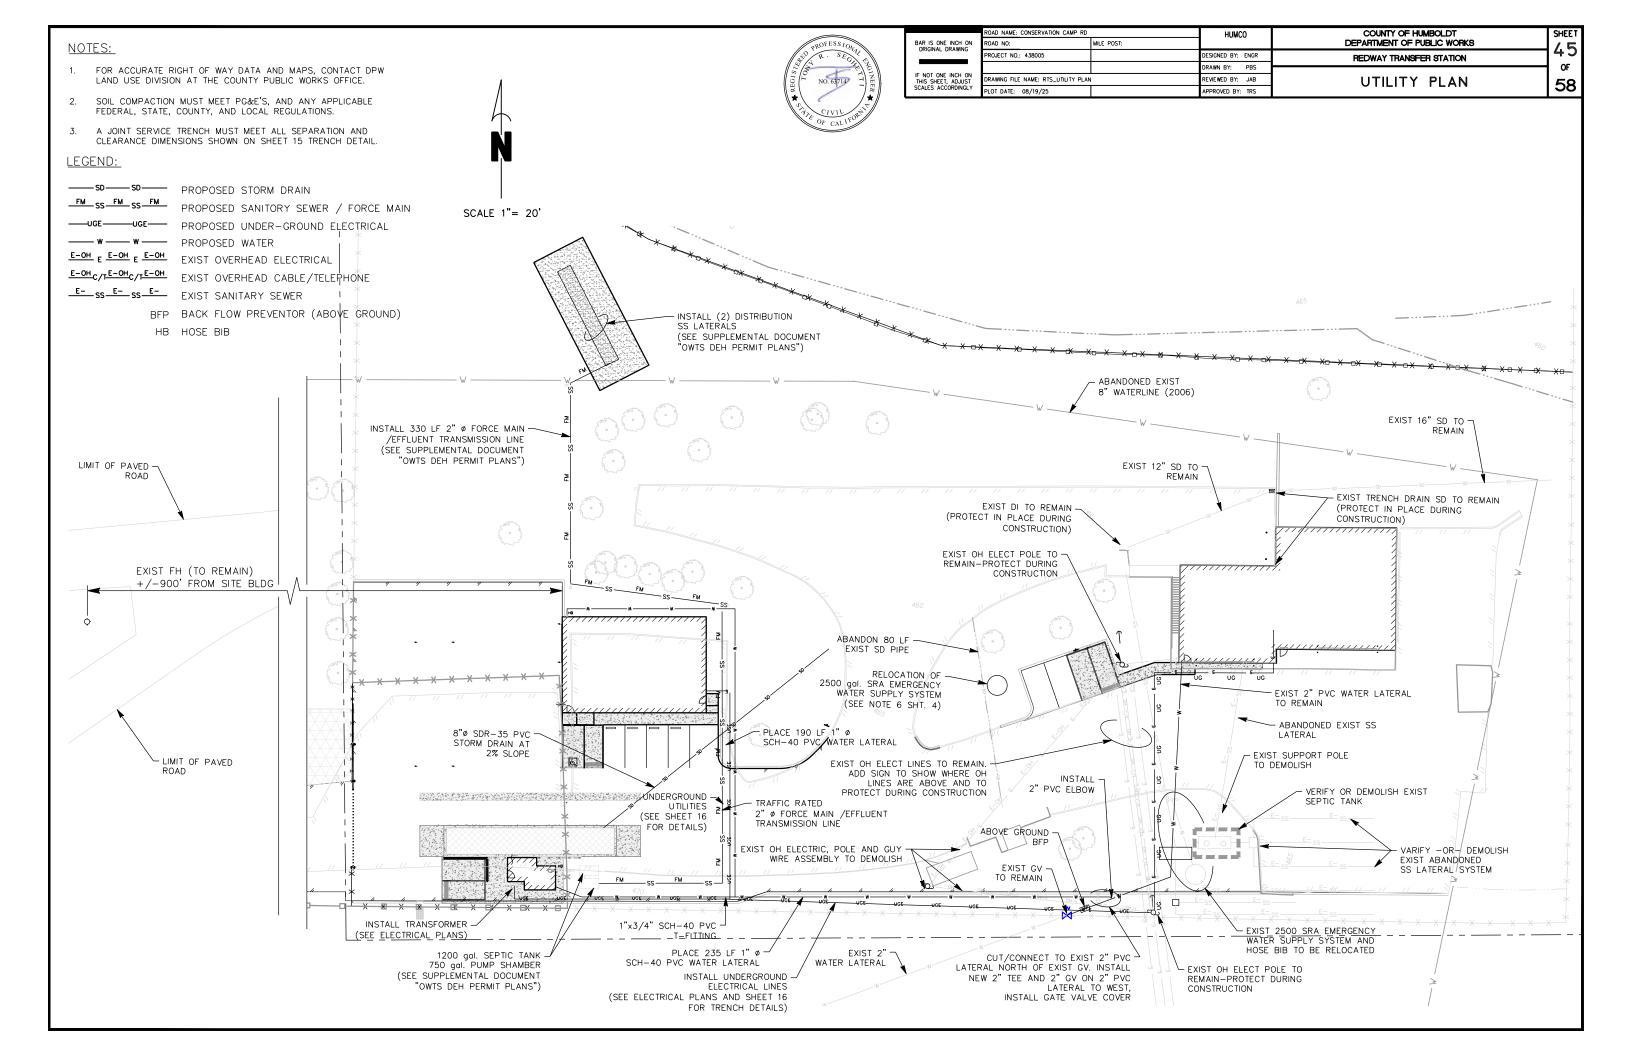

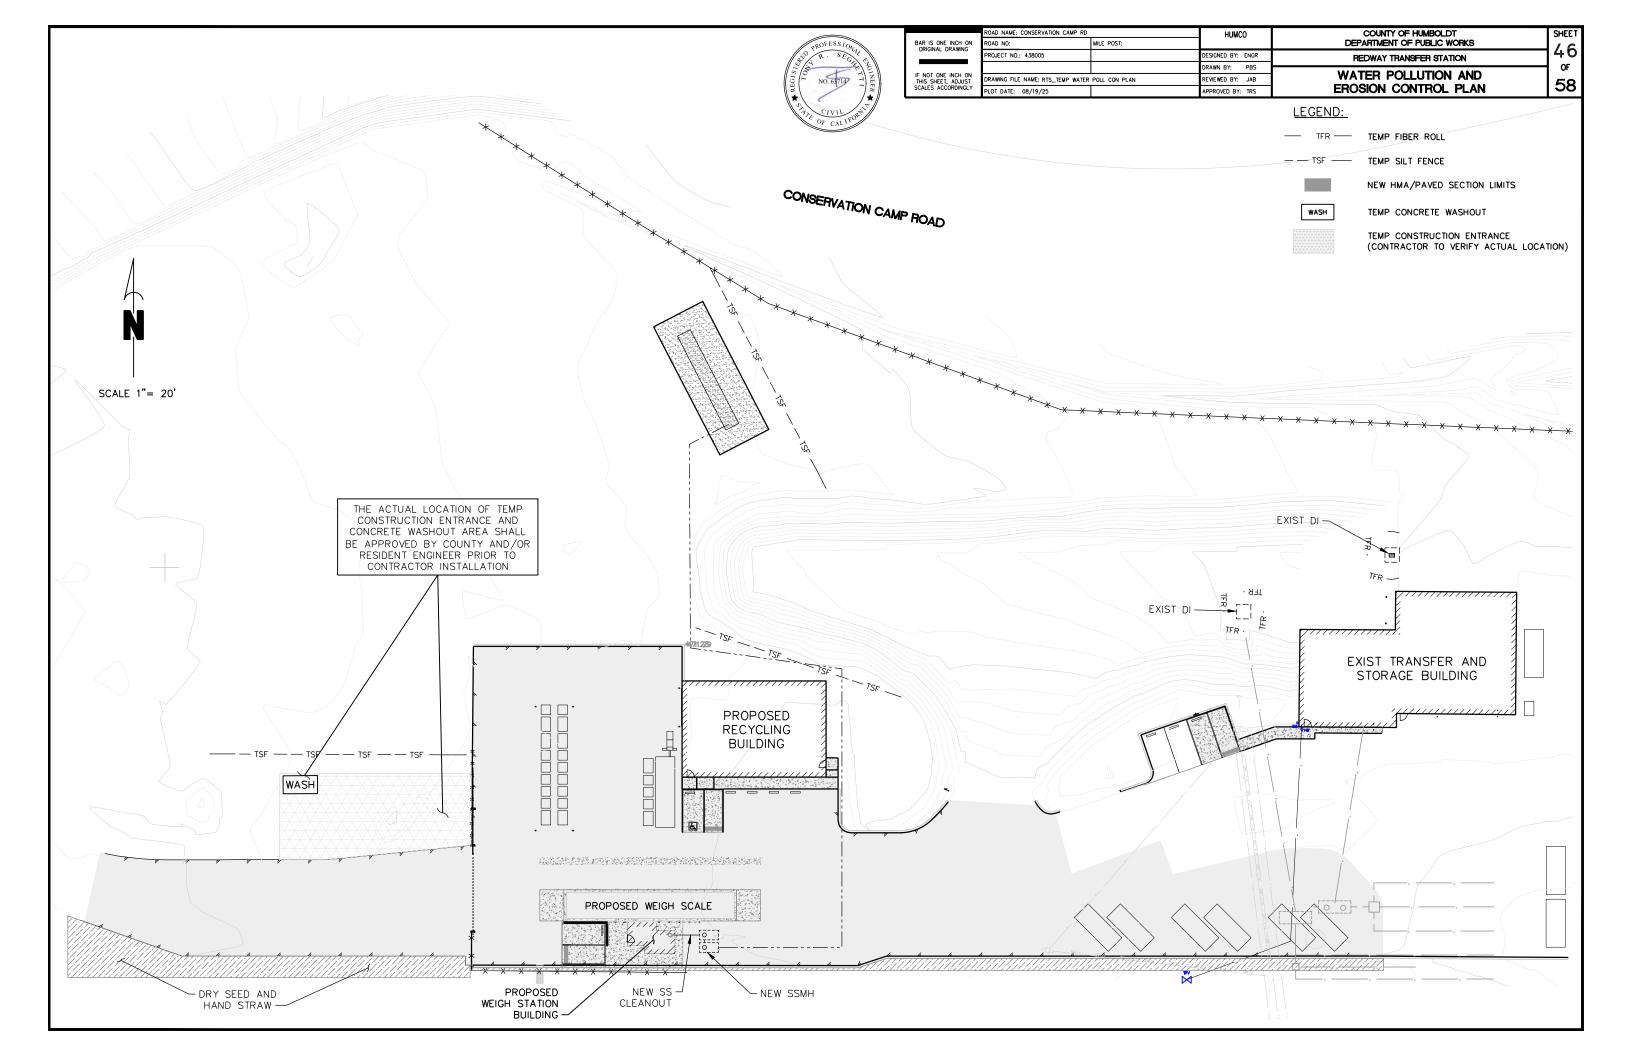



June 17, 2025

### M. NEILS ENGINEERING, INC.

Electrical Engineers | Lighting Designers 100 Howe Ave., Suite 235N Sacramento, CA 95825-8217 www.mneilsengineering.com Fel: (916) 923-4400 Fax: (916) 923-441 PROJECT #: 19086.21

# BAR IS ONE INCH ON ORIGINAL DRAWING

ROAD NAME: CONSERVATION CAMP RD M.NEILS ENGINEERING ROAD NO: MILE POST: EA NO.: PROJECT NO.: 438005 DESIGNED BY: SKL CONTRACT NO BRIDGE NO: DRAWN BY: PI IF NOT ONE INCH ON THIS SHEET, ADJUST SCALES ACCORDINGLY DRAWING FILE NAME REVIEWED BY: SKL/JLB PLOT DATE: 6/17/25 REVISION DATE: APPROVED BY: JLB

REDWAY TRANSFER STATION **ELECTRICAL SHEET INDEX, SYMBOL** LIST AND ABBREVIATIONS

COUNTY OF HUMBOLDT

DEPARTMENT OF PUBLIC WORKS

ΟF 58

SHEET

E0.1

### **DEMOLITION GENERAL NOTES**

- INFORMATION SHOWN RFI ATIVE TO EXISTING CONDITIONS IS BASED UPON AVAILABLE RECORDS AND DATA. THEREFORE, IT SHALL BE REGARDED AS AN APPROXIMATION ONLY. CONTRACTOR AGREES THAT II DATA: THEREFORE, IT STALE BE REGARDED AS AN AFFOCAMMENTON ONE. CONTRACTOR AGREES THA ACCORDANCE WITH GENERALLY ACCEPTED CONSTRUCTION PRACTICES; CONTRACTOR WILL BE REQUIRED TO ASSUME SOLE AND COMPLETE RESPONSIBILITY FOR JOB SITE CONDITIONS DURING THE COURSE OF CONSTRUCTION OF THE PROJECT. PRIOR TO SUBMITTING BID AND/OR BEFORE START OF ANY ELECTRICAL WORK, INSPECT ALL EXISTING LOCATIONS AND CONDITIONS AND ASCERTAIN WORK REQUIRED TO CLEAR PROJECT AREA OF ALL EXISTING ELECTRICAL ITEMS NOT BEING REUSED OR EXISTING TO REMAIN AS IS. REPORT ALL DISCREPANCIES AND COORDINATE ALL DEMOLITION WORK WITH THE OWNER'S REPRESENTATIVE. MAINTAIN SERVICE TO EXISTING ELECTRICAL EQUIPMENT IN AREAS ADJACENT TO REMODEL AREA, UNLESS OTHERWISE NOTED.
- PROTECT ALL EXISTING ELECTRICAL EQUIPMENT ON EXISTING WALLS AND CEILINGS NOT REQUIRED TO BE DEMOLISHED UNLESS OTHERWISE NOTED. DELIVER ALL EXISTING SUELCTRICAL EQUIPMENT IN REMODELED AREAS, THAT ARE REMOVED AND NOT REUSED ELSEWHERE, AND ARE DEEMED TO BE SALVAGEABLE IN THE JUDGMENT OF THE CONTRACTOR AND OWNER'S REPRESENTATIVE, TO THE OWNER. DELIVER ALL SALVAGED ELECTRICAL EQUIPMENT AND OTHER ITEMS TO A LOCATION DESIGNATED BY THE OWNER'S REPRESENTATIVE. REMOVE FROM SITE, ALL OTHER ELECTRICAL EQUIPMENT, HARDWARE, AND OTHER ITEMS THAT ARE DEEMED UNSALVAGEABLE BY CONTRACTOR AND THE OWNER'S
- CUT, PATCH AND MATCH IN ALL AREAS AFFECTED BY REMOVAL OF ELECTRICAL EQUIPMENT AND DEVICES
- CAUSE AS LITTLE INTERFERENCE OR INTERRUPTION OF EXISTING UTILITIES AND SERVICES AS POSSIBLE SCHEDULE ANY POWER OR OTHER UTILITY SHUTDOWN WITH THE OWNER'S REPRESENTATIVE SHUTDOWNS WHICH MAY BE REQUIRED SHALL BE PRESENTED IN WRITING TO THE OWNER'S REPRESENTATIVE FOR APPROVAL TWO WEEKS PRIOR TO COMMENCEMENT OF WORK. SHUTDOWN WORK SHALL BE PERFORMED ON OVERTIME HOURS IF SO DIRECTED BY OWNER'S REPRESENTATIVE.
- DISCONNECT AND REMOVE ALL EXISTING ELECTRICAL EQUIPMENT, FIXTURES, OUTLETS, DEVICES CONDUIT, WIRING AND OTHER ELECTRICAL ITEMS, WHETHER SHOWN OR NOT, FROM EXISTING CEILINGS AND WALLS WHICH ARE TO BE DEMOLISHED. MAINTAIN CIRCUIT CONTINUITY TO ALL EXISTING REMAINING DEVICES, UNLESS OTHERWISE NOTED.
- COORDINATE WITH OTHER TRADES AND PROMPTLY TRANSMIT ALL INFORMATION REQUIRED BY THEM. COORDINATE THE SEQUENCE OF DEMOLITION WITH OTHER TRADES TO ENSURE THAT ALL WORK PROCEEDS WITH A MINIMUM OF INTERFERENCE AND DELAY.
- RELOCATE ALL CONDUITS THAT ARE TO REMAIN IN SERVICE WHICH ARE IN A LOCATION TO CONFLICT
- WHEREVER EXISTING ELECTRICAL DEVICES, PANELS, CONDUITS, CABLES, AND OTHER ITEMS, CONFLICT WITH REMODEL WORK, WHETHER SHOWN OR NOT, RELOCATE THESE ITEMS TO COORDINATE WITH NEW
- 9. REUSE EXISTING CONDUITS AND WIRING WHEREVER POSSIBLE UNLESS OTHERWISE NOTED TO BE
- 10. PROVIDE PROTECTIVE COVERING OVER EXISTING EQUIPMENT WHEN INSTALLING ALL NEW WORK.
- 11. PROVIDE NEW TYPED PANEL DIRECTORIES FOR EXISTING PANELS INVOLVED IN THIS RENOVATION WORK REFLECTING ALL CHANGES TO CIRCUIT DESIGNATIONS
- 12. ASBESTOS REMOVAL: IN THE EVENT ASBESTOS IS FOUND TO BE PRESENT IN AREAS CONFLICTING WITH ELECTRICAL WORK BEFORE CONTINUATION OF WORK IN THOSE AREAS NOTIFY THE OWNER'S REPRESENTATIVE FOR THE REMOVAL OF SUCH HAZARDOUS MATERIAL BY A CERTIFIED ASBESTOS
- CIRCUIT NUMBERS AND CIRCUITING BASED UPON AS-BUILTS. ACTUAL CONDITION MAY VARY. TRACE AND VERIFY ALL CIRCUITS SHOWN ARE AVAILABLE FOR DEMOLITION AND REUSE AS NEEDED DURING THE REMODEL PHASE. DOCUMENT ALL CHANGES ON AS-BUILT DRAWINGS.

## **ELECTRICAL SYMBOL LIST**

LUMINAIRE - CEILING SURFACE OR PENDANT MOUNTED (LETTER "X" INDICATES TYPE "a" DENOTES SWITCH FUNCTION, "ABC-#" INDICATES PANEL AND CIRCUIT NUMBER - TYPICAL FOR ALL LUMINAIRES UNLESS NOTED OTHERWISE).

ENCLOSED LUMINAIRE - SURFACE MOUNTED

LUMINAIRE - WALL MOUNTED

\$a SINGLE POLE TOGGLE SWITCH, +45" A.F.F. - "a" LETTER DENOTES SWITCH FUNCTION, TYPICAL FOR ALL SWITCHES UNLESS NOTED OTHERWISE

DIMMER SWITCH - SIZE AS NOTED ON PLAN, +45" A.F.F.

(J) JUNCTION BOX - SIZE AS REQUIRED BY CODE

 $\bowtie$ DUPLEX CONVENIENCE OUTLET - NEMA 5-20R +18" A.F.F. TYPICAL FOR ALL CONVENIENCE OUTLETS, UNLESS NOTED OTHERWISE (LETTER "A" SHOWN ADJACENT TO OUTLET DESIGNATES MOUNTED HORIZONTALLY ABOVE COUNTER).

GFCI DUPLEX CONVENIENCE OUTLET - NEMA 5-20R

QUADPLEX CONVENIENCE OUTLET - NEMA 5-20R

SPECIAL RECEPTACLE AS SHOWN ON PLANS

FLEXIBLE CONDUIT CONCEALED. NUMBER OF HASH MARKS DENOTES QUANTITY OF WIRES. CURVED HASH MARK DENOTES QUANTITY OF #12 GREEN GROUND WIRES. CONDUCTORS OTHER THAN #12 ARE INDICATED ON PLANS. NO HASH MARKS DENOTES 2 #12 AWG AND 1 #12 GREEN GROUND IN 1/2" MINIMUM DIAMETER CONDUIT.

CONDUIT RUN UNDERFLOOR OR UNDERGROUND MINIMUM 1" DIAMETER.

CONDUIT HOMERUN TO PANELBOARD, SWITCHBOARD OR TERMINAL CABINET

CONDUIT TURNED AND RISED UP

 CONDUIT TURNED AND DROPPED DOWN EXISTING CONDUIT AND WIRING

-×- × -×- EXISTING CONDUIT TO BE REMOVED OR ABANDONED, REMOVE WIRES. COORDINATE WITH

EXISTING OVERHEAD WIRING

PANELBOARD - SURFACE MOUNTED 

PANELBOARD - FLUSH MOUNTED 

EXISTING PANELBOARD - SURFACE MOUNTED

EXISTING PANELBOARD - FLUSH MOUNTED

4 EQUIPMENT DISCONNECT SWITCH - EXTERNALLY OPERATED, FUSED WITH FUSE SIZE

Ш EQUIPMENT DISCONNECT SWITCH - EXTERNALLY OPERATED, NON-FUSIBLE

\$<sub>OL</sub> TOGGLE TYPE MOTOR RATED DISCONNECT SWITCH WITH OVERLOAD PROTECTION

ELECTRICAL PULL BOX. "PB#" INDICATES SIZE CORRESPONDING TO PULL BOX SCHEDULE.

DRAWING SHEET NUMBERED NOTE DESIGNATION - APPLIES TO NUMBERED NOTE ON SAME

ELECTRICAL TRANSFORMER. RATING PER SPECIFICATIONS.

DRAWING PLAN OR DETAIL DESIGNATION - "1" OR "A" DENOTES PLAN OR DETAIL NUMBER, E-1 "E-1" DENOTES SHEET NUMBER

MECHANICAL EQUIPMENT DESIGNATION - SEE MECHANICAL PLANS

### SYMBOL LIST NOTES:

- 1. "ABC-#" INDICATES PANEL AND CIRCUIT NUMBER.
- MINIMUM CONDUCTOR SIZE FOR 120V BRANCH CIRCUITS SHALL BE #12 AWG. AT A MINIMUM ALL BRANCH CIRCUITS SHALL CONTAIN 3/4"C, 2#12 AWG AND 1#12 GND UNLESS OTHERWISE INDICATED.
- LIGHTLY AND ACCOMPANIED BY (E). SUCH ELECTRICAL EQUIPMENT, OUTLETS, AND DEVICES ARE TO REMAIN AS IS, UNLESS OTHERWISE NOTED ON PLAN OR SPECIFICATION.
- 4. ELECTRICAL OUTLET BOXES MOUNTED ON OPPOSITE SIDES OF FIRE-RATED WALLS OR PARTITIONS SHALL BE SEPARATED BY A HORIZONTAL DISTANCE OF NOT LESS THAN 24 INCHES PER CBC, WHETHER SHOWN ON THE PLANS OR NOT.
- VERIFY ON SITE THAT ALL PANELBOARDS HAVE MINIMUM WORKING SPACES PER CODE AND THAT THE DEDICATED PANELBOARD SPACES ARE CLEAR OF ALL DUCTS. PIPING AND EQUIPMENT FOREIGN TO THE PANEL BOARDS. NOTIFY THE ENGINEER FOR CORRECTIVE ACTION IN THE EVENT THAT FOREIGN OBJECTS IMPEDE THE DEDICATED PANELBOARD AREAS.
- WHERE CONDUIT STUB IS INDICATED, PROVIDE CONDUIT WITH BUSHING AT THE END OF CONDUIT AND PULL ROPE INTO ACCESSIBLE CELLING AREA

	ELECTRICAL SHEET INDEX					
No. OF SHEETS	DRAWING No.	DRAWING DESCRIPTIONS				
1	E0.1	ELECTRICAL SHEET INDEX, SYMBOL LIST AND ABBREVIATIONS				
2	E1.0	SITE PLAN - ELECTRICAL				
3	E2.0	WAREHOUSE FLOOR PLAN - ELECTRICAL				
4	E2.1	RECYCLE BUILDING & WEIGH STATION FLOOR PLAN - ELECTRICAL				
5	E3.0	ONE-LINE POWER DIAGRAM AND PANEL SCHEDULE				
6	E4.0	ELECTRICAL DETAILS				
7	E5.0	TITLE 24 INDOOR LIGHTING COMPLIANCE FORMS				
8	E5.1	TITLE 24 WEIGH STATION - INDOOR LIGHTING				
9	E5.2	TITLE 24 WEIGH STATION - INDOOR & OUTDOOR LIGHTING				
10	E5.3	TITLE 24 WEIGH STATION - OUTDOOR LIGHTING				
11	E5.4	TITLE 24 RECYCLE BUILDING - INDOOR LIGHTING				
12	E5.5	TITLE 24 RECYCLE BUILDING - INDOOR & OUTDOOR LIGHTING				
13	E5.6	TITLE 24 RECYCLE BUILDING - OUTDOOR LIGHTING				

	ABBREVIATIONS							
A A.F.F.	AMPERES ABOVE FINISHED FLOOR	NEMA	NATIONAL ELECTRICAL MANUFACTURERS ASSOCIATION					
A.F.F.	ABOVE FINISHED GRADE	О.Н.	OVERHEAD					
AF	AMP FUSE	PFB	PROVISIONS FOR FUTURE CIRCUIT BREAKER					
A.I.C.	AMPERE INTERRUPTING CAPACITY	PH	PHASE					
AS	AMP SWITCH	PVC	POLYVINYL CHLORIDE					
AWG	AMERICAN WIRE GAUGE	(R)	REMOVE					
BKR	BREAKER	(RE)	RELOCATE EXISTING					
C.	CONDUIT	RCPT.	RECEPTACLE					
CU	COPPER	SWBD	SWITCHBOARD					
(E)	EXISTING	SYS	SYSTEM					
(ER)	EXISTING RELOCATED	THW	INSULATED STRAND WIRE					
EMT	ELECTRICAL METALLIC CONDUIT	THHN	NYLON JACKETED WIRE					
GND	GROUND	TYP	TYPICAL					
GFCI	GROUND FAULT CIRCUIT INTERRUPTER	UGPS	UNDERGROUND PULL SECTION					
Isc	SHORT CIRCUIT AMPERES	UL	UNDERWRITERS LABORATORY					
KVA	KILO VOLT AMPERE	w	WIRE, WATT					
LT.	LIGHT	WP	WEATHER PROTECTED					
MAX.	MAXIMUM	WR	WEATHER RESISTANT AND					
MIN.	MINIMUM		WEATHERPROOF					
MOG.	MOGUL BASE	XFMR	TRANSFORMER					
N (N)	NEUTRAL NEW	XHHW	CROSS-LINKED POLYETHYLENE WIRE INSULATED					
(N)	INEAA	Y	WYE					

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ORIGINAL DRAWING
IF NOT ONE INCH ON THIS SHEET, ADJUST SCALES ACCORDINGLY

ROAD NAME: CONSERVATION CAMP RD	M.NEILS ENGINEERING		
ROAD NO:	MILE POST:		
PROJECT NO.: 438005	EA NO.:	DESIGNED BY: SKL	
CONTRACT NO.:	BRIDGE NO:	DRAWN BY: PI	
PRAWING FILE NAME:		REVIEWED BY: SKL/JLB	
PLOT DATE: 6/17/25	REVISION DATE:	APPROVED BY: JLB	

REDWAY TRANSFER STATION SITE PLAN - ELECTRICAL

COUNTY OF HUMBOLDT

DEPARTMENT OF PUBLIC WORKS

58 E1.0

48

REFER TO PLAN FOR LOCATION OF BOXES AND TYPES USED.

BOX SCHEDULE					
TAG	NOMINAL WIDTH	NOMINAL LENGTH	NOMINAL DEPTH		
PB10	10"	17"	12"		
PB13	13"	24"	12"		
PB17	17"	30"	12"		
PB24	24"	36"	12"		
DB30	30"	48"	12"		

UNDERGROUND PULL

SCREW-ON JACKMOON, TYCO OR EQUAL. CONDUIT PLUG, -COVER TYPICAL EACH END, MATCH SIZE OF PLUG WITH CONDUIT LENGTH --UNDERGROUND PULL BOX PER PLAN SEAL END OF CONDUITS 12" CONCRETE AND PENETRATION WATER TIGHT EXTENSION, QUANTITY AS NEEDED CONDUIT PER PLAN MAINTAIN 12" -PULL ROPE, TYPICAL -CONDUIT STUB AND CAP SEPARATION BETWEEN ELECTRICAL (WHERE OCCURS) AND SIGNAL CONDUITS, 18" MINIMUM DEPTH -CONDUIT PER PLAN TRAFFIC RATED -BOX CONCRETE PAD NOTES:

- 1. PULL BOX SHALL BE TRAFFIC RATED WHEN SUBJECT TO VEHICULAR TRAFFIC
- 2. CLEAN 2" AND LARGER SPARE EMPTY CONDUITS WITH APPROPRIATE SIZE MANDREL PRIOR TO PLACING PULL ROPE AND PLUGGING EMPTY CONDUITS WITH CONDUIT PLUGS.
- 3. PULL ROPE: TIE OFF EACH END TO DUCT PLUG TO PREVENT PULL ROPE LOSS IN CONDUIT.

FEEDER SCHEDULE TAG ### DESCRIPTION 1" C., 3 #10, AND 1 #10 GND. 203\*\* 1" C., 3 #8, AND 1 #8 GND. TAGS DENOTED WITH "\*" HAVE BEEN UPSIZED FOR VOLTAGE DROP.

### NUMBERED NOTES

- PROVIDE NEW DRY TYPE TRANSFORMER WITH NEMA 3R ENCLOSURE. REFER TO ONE-LINE POWER DIAGRAM, "2/E3.0".
- PROVIDE 1" CONDUIT FOR SIGNAL WIRING FROM SCALE BUILDING TO SCALE. WIRING BY SCALE INSTALLER. COORDINATE LOCATION AND REQUIREMENTS PRIOR TO INSTALLATION
- PROVIDE 120V CIRCUIT TO SEPTIC TANK CONTROL PANEL AND PUMP, REFER TO SEPTIC TANK DETAIL ON CIVIL PLANS.

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EXIST TRANSFER AND STORAGE BUILDING


(E) ELECTRIC METER

WITH PULL WIRE. (E) ELECTRICAL O.H. LINE


TRAFFIC RATED

SEE ONE-LINE POWER DIAGRAM. PROVIDE SPARE EMPTY 2" CONDUIT.




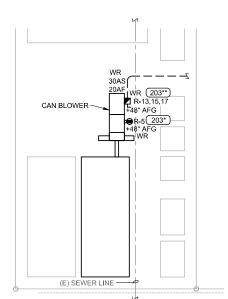

CAN BLOWER CONNECTION PLAN

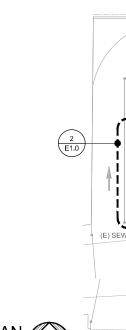

1 (N) TRANSFORMER "TR"

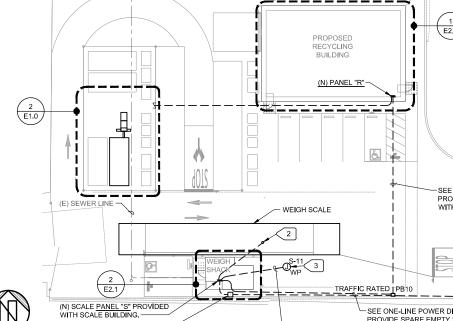

1"C. WITH 2 #10

SEE ONE-LINE POWER DIAGRAM. PROVIDE SPARE EMPTY 2" CONDUIT WITH PULL WIRE. (R) ELECTRICAL O.H. LINE COORDINATE WITH ELECTRIC UTILITY (R) POWER POLE, COORDINATE WITH – SEE ONE-LINE POWER DIAGRAM. PROVIDE SPARE EMPTY 2" CONDUIT – (R) ELECTRICAL O.H. LINE. COORDINATE WITH ELECTRIC UTILITY. – WITH PULL WIRE.

(E) ELECTRIC SERVICE POLE WITH UTILITY SERVICE -

SITE PLAN - ELECTRICAL SCALE : 1" = 20'-0"



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PROJECT #: 19086.21

www.mneilsengineering.com Tel: (916) 923-4400 Fax: (916) 923-4410

M.NEILS ENGINEERING ROAD NO: MILE POST: PROJECT NO.: 438005 EA NO.: DESIGNED BY: SKL BRIDGE NO: DRAWN BY: PI DRAWING FILE NAME: REVIEWED BY: SKL/JLB PLOT DATE: 6/17/25 REVISION DATE: APPROVED BY: JLB

ROAD NAME: CONSERVATION CAMP RD

DEPARTMENT OF PUBLIC WORKS REDWAY TRANSFER STATION WAREHOUSE FLOOR PLAN - ELECTRICAL

COUNTY OF HUMBOLDT

58 E2.0


### **EXISTING SITE CONDITIONS NOTE**


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### NUMBERED NOTES

- REROUTE ALL EXISTING CIRCUITS FROM REMOVED MAIN PANEL TO NEW PANEL "MPL" RESPECTIVE TO THEIR VOLTAGES. SEE ONE-LINE DIAGRAM FOR ADDITIONAL INSTRUCTIONS. PROVIDE UPDATED PANEL SCHEDULE REFLECTING AS-BUILT CONDITIONS AT PROJECT
- 2 MOUNT ELECTRICAL EQUIPMENT TO NEW UNISTRUT MOUNTING STAND. SEE DETAIL "5/E4.0".
- REROUTE ALL EXISTING CIRCUITS FROM REMOVED ELECTRICAL EQUIPMENT TO NEW PANELS "MPL" AND "MPH" RESPECTIVE TO THEIR VOLTAGE REQUIRMENTS. SEE ONE-LINE DIAGRAM FOR ADDITIONAL INSTRUCTIONS, NOTIFY ENGINEER OF RECORD IF EQUIPMENT CIRCUIT BREAKER REQUIREMENTS DIFFER FROM DRAWINGS, PROVIDE UPDATED PANEL SCHEDULE REFLECTING AS-BUILT CONDITIONS AT PROJECT COMPLETION.
- disconnect and remove all conductors serving all loads connected to the SECONDARY SIDE OF THE TRANSFORMER.
- 5 MAINTAIN CEC REQUIRED WORKING CLEARANCE IN FRONT OF ALL ELECTRICAL EQUIPMENT.





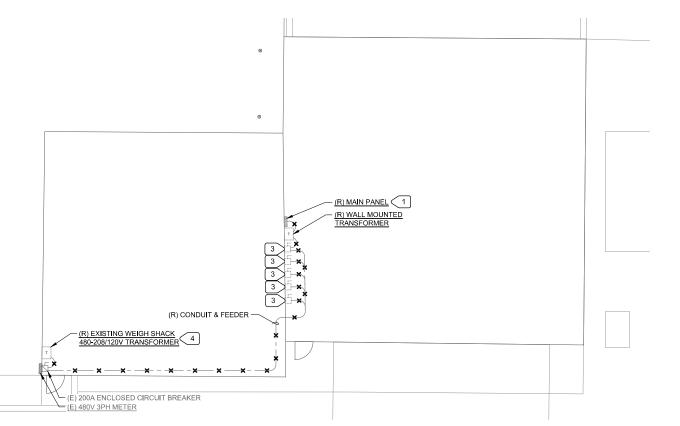

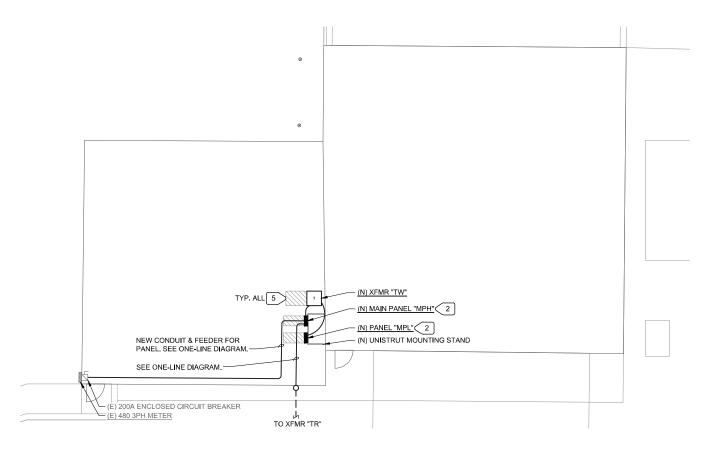




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ROAD NAME: CONSERVATION CAMP RD		M.NEILS ENGINEERING	COUNTY OF HUMBOLDT	Ts
ROAD NO:	MILE POST:		DEPARTMENT OF PUBLIC WORKS	Ιc
PROJECT NO.: 438005	EA NO.:	DESIGNED BY: SKL	REDWAY TRANSFER STATION	I١
CONTRACT NO.:	BRIDGE NO:	DRAWN BY: PI	DECYCLE BUILDING & WEIGH OTATION	ł
DRAWING FILE NAME:		REVIEWED BY: SKL/JLB	RECYCLE BUILDING & WEIGH STATION	F
PLOT DATE: 6/17/25	REVISION DATE:	APPROVED BY: JLB	FLOOR PLAN - ELECTRICAL	Ľ

50 of 58 **E2.1** 

	FEEDER SCHEDULE
G (###	DESCRIPTION
203	1" C., 3 #12, AND 1 #12 GND.
303	3/4" C., 3 #10, AND 1 #10 GND.
502	1" C., 2 #6, AND 1 #10 GND.





1	LOCATE WALL PACK FIXTURE OVER THE ROLL-UP DOOR.
2	LOCATE WALL PACK FIXTURE OVER THE DOOR.
3	PROVIDE NEW DRY TYPE TRANSFORMER "TR" ON NEW CONCRETE PAD. REFER TO ONE-LINE POWER DIAGRAM AND DETAIL "2/E4.0" FOR CONCRETE PAD.
4	PROVIDE PRIMARY DISCONNECT IN NEMA 3R ENCLOSURE. REFER TO ONE-LINE POWER DIAGRAM.
5	PROVIDE ASTRONIMICAL TIME SWITCH, INTERMATIC ET90000, FOR EXTERIOR LIGHTING CONTROL.
6	PROVIDE TIME SWITCH, INTERMATIC ET90000, FOR INTERIOR LIGHTING CONTROL.
7	PROVIDE 15A-2P MOTOR RATED DISCONNECT SWITCH WITH OVERLOAD PROTECTION.

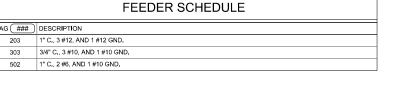
NUMBERED NOTES

	LUMINAIRE SCHEDULE						
TVDE	MANUFACTURER	VOLTAGE	LIGHT SOURCE (LED, WATTS, LUMENS,		REMARK		
TYPE	CATALOG NO.	DESCRIPTION	COLOR TEMPERATURE, CRI, R9 IF AVAILABLE)	MOUNTING	NOTE No.		
	LSI INDUSTRIES INC.	UNIV	LED, 48.46W, 4511L,	CEILING			
A1	EG3-4-LED-6L-DA-S-UNV- DIM-40-80-OCSWL	4FT WET LOCATION LED	4000K°, 80CRI MOUNT				
	LUMINAIRE LED	UNIV	LED. 26.7W. 3527L.	SURFACE CEILING MOUNT			
B1	SWP1212-MIN1-25W-40K- MVOLT-OP-BLK-OCC	VANDAL RESISTANT LED	4000K°				
	LSI INDUSTRIES INC.	UNIV	LED, 68W, 6237L,				
C1	SWPM-WB-LED-PL2-40- UE-BRZ-PD	OUTDOOR WALL LED	4000K°, 84CRI	WALL MOUNT	(1)		
	LSI INDUSTRIES INC.	UNIV	LED, 90W, 9191L.		_		
C2	C2 SWPL-WB-LED-PLA-40- OUTDOOR WALL LED 4000K°, 80CRI WALL MOUNT 1						
LUMI	LUMINAIRE SCHEDULE REMARK NOTES:						



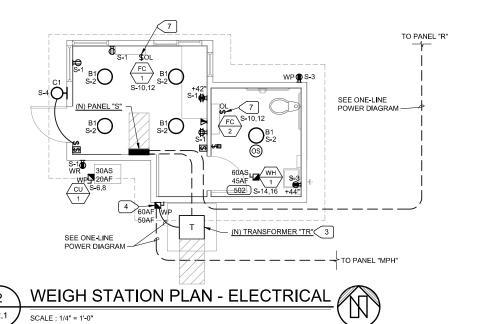

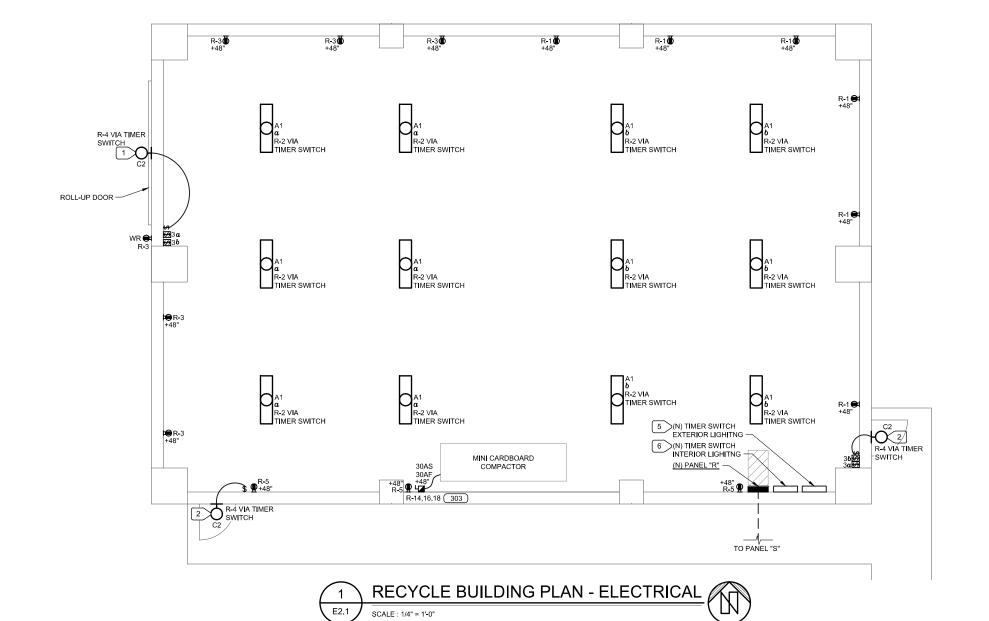

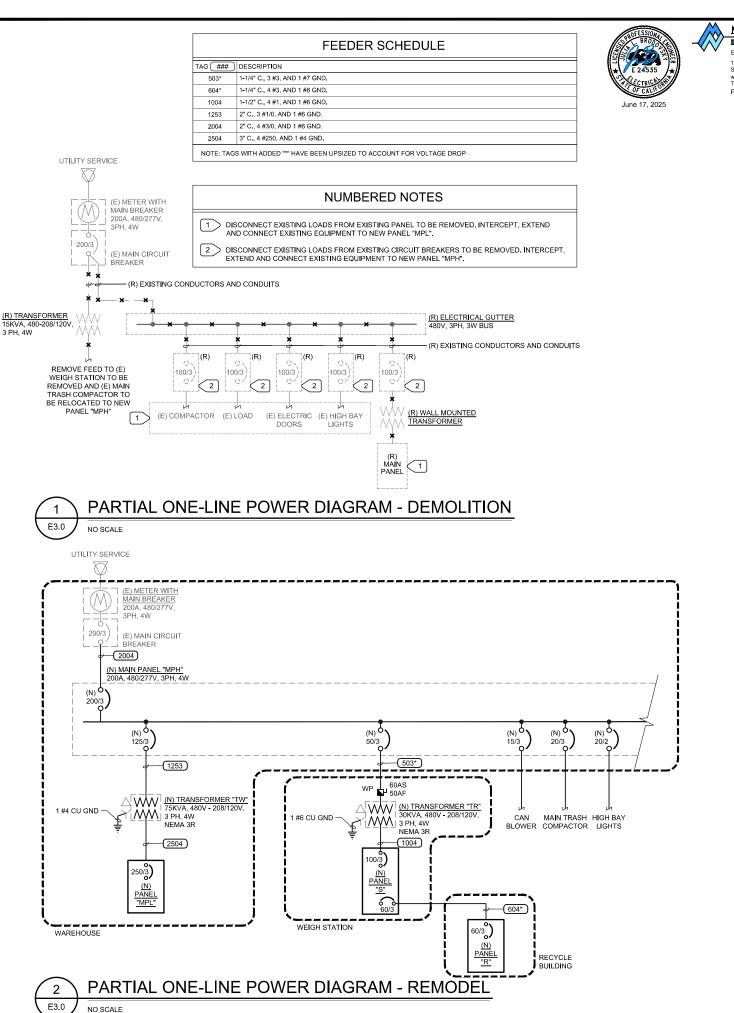

NO SCALE



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IF NOT ONE INCH ON THIS SHEET, ADJUST	DRAWING FILE NAME:		
SCALES ACCORDINGLY	PLOT DATE: 6/17/25	REVISION DATE:	

M.NEILS ENGINEERING

DESIGNED BY: SKL

DRAWN BY: PI

REVIEWED BY: SKL/JLB

APPROVED BY: JLB

ROAD NAME: CONSERVATION CAMP RD

COUNTY OF HUMBOLDT DEPARTMENT OF PUBLIC WORKS REDWAY TRANSFER STATION **ONE-LINE POWER DIAGRAM AND** 58 PANEL SCHEDULE

E3.0


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	BUS 225 AMPS	MAI 2	вкя 73	VOLTAGE 3 FH	AS	2	23	E	OL.			SURFACE L TYPE MA S	REMARKS COORDINATE AIC RATING WITH EXISTING SERVICE
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PL"	ļ		) ) )	110/3	~	1				ŀ	15/3	[1] [1] [1]	CAN BLOWER (2)
"FR			G 2	50/3	,	-	-	-			20/3	(1) [1] [1]	MAIN TRASH COMPACTOR [2]
åΕ) J	OS FING		) ]	우무임		-	-			I	20/2	[1] [1]	HIGH BAY LIGHTS (2)
			<u> </u>		1			ŀ	;L	ŧ.,	PF3		SPACE
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Y IF YO RE	EQUIPMENT ( UNKNOWN E BID NOSUO: AKER SIZED F ENDATIONS :	EXIST E IN E FOR I	G LOV LERIC USEN	AD IS STILL	ON CO		r A E T	Z ::: E	BRA ER:	C	S POWER H CIRCUIT	SEE	LOAD CALCULATION

POWER SOU PASTEM:	ROS FAMEL NORMAL ER	THIPHY VSA XI ANCH	MR	74"				S	CA	TION VYERS	HSH	CK			
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											100	TAL 3		6	Amperes

	SURCE: PASIEL	_					LOCA	TON REC	YOUR BUILDIN	Æ.		
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LOAI	SERVED	KVA	CB	C	7	PHASE	CKT	ca	kVA		OAD	SERVED
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mjest Name	Reduction.	ramafe:	Station				Date:	27 Mar-25	
rojest No.	19086.25					By: M. Neike Er	gineering, inc		
aisting mad	o um dema	d for <u>2</u> 0	00A Main	Matered Se	rvice (base	dion 13 months sead	ngs below).	12 52	kv/A
currier PGI	a diding 1	man-is	alling vs	tory mater #	1009453567				
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Tipital NEV	u service k	ad Ca						16 55	şγA
TOTAL S	ERVICE VO	A (EX	STING +	NEW improve	ments)		=	48.76	kVA
48.76	k (A se	71/4/80	Volt. 3	pihase		2.67 amoeres			
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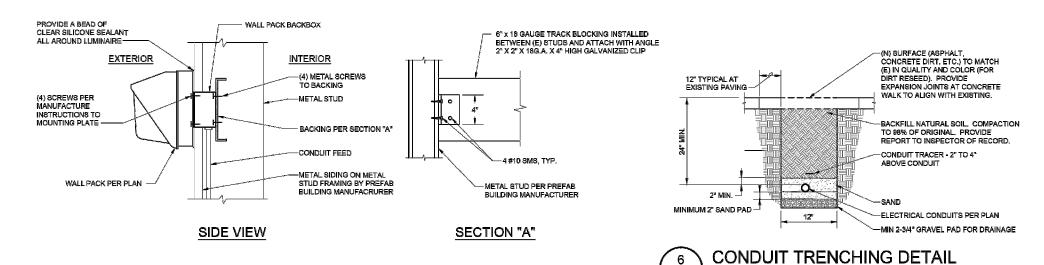
ROAD NAME: CONSERVATION CAMP RD		M.NEILS ENGINEERING	COUNTY OF HUMBOLDT
ROAD NO:	MILE POST:		DEPARTMENT OF PUBLIC WORKS
PROJECT NO.: 438005	EA NO.:	DESIGNED BY: SKIL	REDWAY TRANSFER STATION
CONTRACT NO.:	BRIDGE NO:	DRAWN BY: PI	) <del></del>
DRAWING FILE NAME:		REVIEWED BY: SKL/JLB	FLECTRICAL DETAILS
PLOT DATE: 6/9/25	REVISION DATE:	AFFROVED BY: JLB	LEED II (IO/NE DE I/NIES


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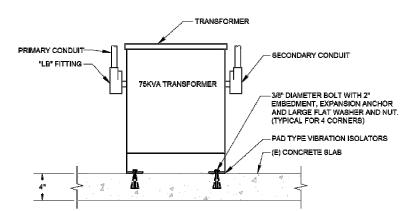
OF

58

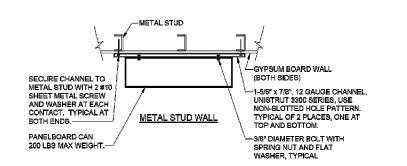




EXTERIOR TRANSFORMER PAD MOUNTING DETAIL

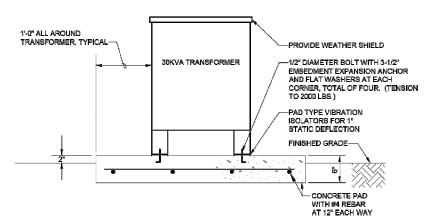




WALL PACK MOUNTING DETAIL

NO SCALE

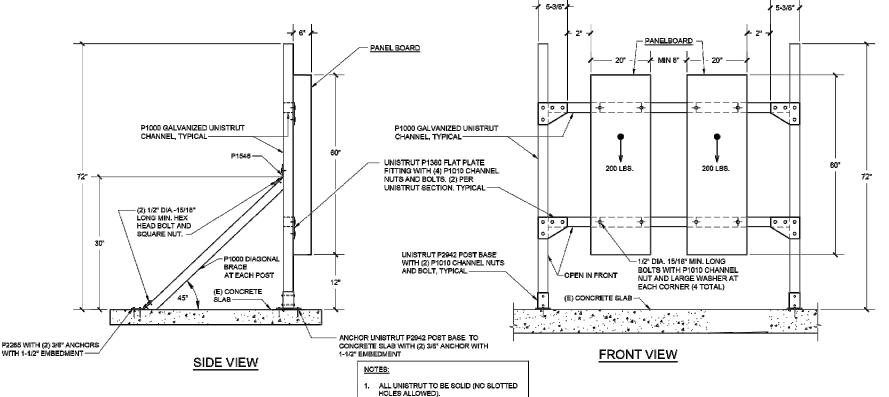

E4.0

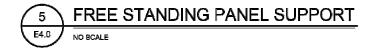

 TORQUE ALL UNISTRUT CONNECTIONS PER MANUFACTURER REQUIREMENTS.

UNAUTHORIZED CHANGES & USES:
M. Neils Engineering, Inc. preparing these

E4.0



Electrical Engineers | Lighting Designers
100 Howe Ave. Suite 235N
Sacramento, CA 95825-8217
Tel: (916) 923-4400 Fax: (916) 923-4410
PROJECT #: 19086.21

	ROAD NAME: CONSERVATION CAMP RD		M.NEILS ENGINEERING	
DRAWING	ROAD NO:	MILE POST:		
	PROJECT NO.: 438005	EA NO.:	DESIGNED BY: SKL	_
INCH ON	CONTRACT NO.:	BRIDGE NO:	DRAWN BY: PI	-
	DRAWING FILE NAME:		REVIEWED BY: SKL/JLB	
CORDINGLY	PLOT DATE: 6/17/25	REVISION DATE:	APPROVED BY: JLB	
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REDWAY TRANSFER STATION

TITLE 24 WEIGH STATION INDOOR LIGHTING

COUNTY OF HUMBOLDT DEPARTMENT OF PUBLIC WORKS

> 58 **E5.1**

53

STATE OF CALIFORNIA			STATE OF CALIFORMIA			STATE OF CALIFORNIA		
Indoor Lighting		CALIFORNIA ENERGY COMMISSION	Indeor Lighting		CALIFORNIA ENERGY COMMISSION	Indoor Lighting		CALIFORNIA ENERGY COMMISSION
CERTIFICATE OF COMPLIANCE		NRCC-LTT-E	CERTIFICATE OF COMPLIANCE		NRCC-LTI-E	CERTIFICATE OF COMPLIANCE	- In	NROC-LTI-E
This document is used to demonstrate compliance with requirements in nonresidential and hotel/motel accupancies, it is also used to documen			Project Name: 19086.21 Reshway Transfer Station - Weigh Station	Report Fage: Cate Frepered:	(Page 2 of 7) 2023-06-06T15:04:32-04:00	Project Name: 19086.21 Redway Transfer Station - Weigh Station	Report Page:  Date Prepared:	(Page 3 of 7) 2025-06-06T15:04:32-04:00
path for multiformily accupancies. Multiformily includes dormitory and se	entar living facilities.	John market ingritting 200/022 training late jare 2011/2014		rome national	E062-00-00   15-04-36-04-00		Louis Profession:	2022-00-00:13:04:52-04:00
Project Name: 19096.21 Rackway Transfer Station - Weigh Station	Report Page:	(Page 1 of 7)						
Project Address:	Date Prepared:	2025-06-06T15:04:32-04:00	C COMPUMNICE DECUTE			F. INDOOR LIGHTING FIXTURE SCHEDULE		
			C. COMPLIANCE RESULTS  # any sail on this table case *FOSE SIGT FOR SIGN OF AN *FOSSE SIGE SIGH.	Planet Parallelana" nafan ya Zohia Fi dan mulakwan		This table includes all planned permanent and portable lighting other than di		
A. GENERAL INFORMATION			If any cell on this table says "DOES NOT COMPLY" or "COMPLIES with Excep	Adjusted Lighting Power or	er 140.6(a) / 170.2(e)	documented in Table T. If using Table T to document lighting in multifamily co not included here.	mmon use areas providing shared provisions for bling, eat	ing, cooking or sanitation, those luminaires are
01 Project Location (city) Radway, CA	04 Total Conditioned Floor Area (ft²)		Allowed Lighting Power per 140.6(b) / 170.	.2(e) (Watts) (Watts		Designed Wattage: Canditioned Spaces		
02 Climate Zone 2	05 Total Unconditioned Floor Area (ft		Lighting in 01 02 03 04 conditioned and	05 06 07	08 09	01 02 03 04	05 06 07 08	09 10
03 Occupancy Types Within Project (select all that apply):	06 # of Stories (Habitable Above Grad	de; V	unconditioned Area	Adjustment		Name or Item Complete Luminaire Modular Small	Watts per How is Wattage Total Number Excluded	
Commercial industrial			spaces must not be Complete Area Category Tailored Complete Category Additional 140.6(c):	d ≥ Total PAF Lighting B / _ Total Page Control Credi	Total Adjusted	Tag Description (Track) Fixture & Color Change 1	luminaire <sup>2</sup> determined of Luminaires 140.6(a)	
			compliance per 140.6(c)2 / 140.6(c)2G / 170.2(e)4		= (Watts) 05 must be >= 08 *Includes 140.6 / 170.2(e)	B1 VANDAL RESISTANT LED No NA	26.7 Mfr. Spec 5 No	
B. PROJECT SCOPE			140.6(b)1 / 170.2(e) 170.2(e)4 170.2(e)4Av (+)	(Watts) 170.2(e)18	Adjustments 140.0 / 170.2(e)		Total Designed Watts: CONDITIONED S	
This table includes any lighting systems that are within the scape of the	permit application and are demanstrating compliance using the	prescriptive poth outlined in 140.6 / 170.2(e) or	(See Table I) (See Table I) (See Table J) (See Table	_       ''		<sup>2</sup> FOOTNOTE: Design Watts for small aperture and color changing luminaires t	which qualify per 140.6(a)48 / 170.2(e)2D is adjusted to be	75% /80% of their rated wattage. Table F
141.0(b)2 / 180.2(b)4 for alterations.	0 191 10		Conditioned 143	= 143 2 133.5	= 133.5 COMPLIES	automatically makes this adjustment, the permit applicant should enter full n		
Scope of Work	Conditioned Spaces	Unconditioned Spaces	Unconditioned	= 2	-	<sup>2</sup> Authority Having Jurisdiction may ask for Luminaire cut sheets to confirm we luminaire, not the lamp.	ttage used for compliance per 130.0(c) / 180.5(b). Wattage	used must be the maximum rated for the
My Project Consists of Johnsk all that apply	02 03  Calculation Method Area (ft <sup>2</sup> )	04 05  Calculation Method Area (ft <sup>2</sup> )		Controls Compliance	(See Table H for Details) COMPLIES	American and the control of the cont		
My Project Consists of (check all that apply):  New Lighting System	Calculation Method Area (ft²)  Area Category Method 220	Calculation Method Area (ft²)		Rated Power Reduction Compliance	(See Table Q for Details)	G MODILI AD LIGHTING SYSTEMS		
New Lighting System - Parking Garage	N/A D	N/A 0				G. MODULAR LIGHTING SYSTEMS		
Total Area of Work (ft <sup>2</sup> )	220	<del>                                     </del>	D. EXCEPTIONAL CONDITIONS			This section does not apply to this project.		
and an example to b	<del></del>	<u> </u>	This table is auto-filled with uneditable comments because of selections ma	de or data entered in tables throughout the form.				
						H. INDOOR LIGHTING CONTROLS (Not including PAFs)		
			E. ADDITIONAL REMARKS			This table includes lighting controls for conditioned and unconditioned spaces	<u> </u>	
			This table includes remarks made by the permit applicant to the Authority i	laving Jurisdiction.		Building Level Controls 01	02	03
				•			32	Field Inspector
						Mandatory Demand Response 110.12(c)	Shut-off controls 130.1(c) / 160.5(b	)4C Pass Fail
						NA < 4,000W subject to multilevel	Sea Ares/Space Level Controls	
ETWIE OF CALIFORNIA IN GOOD LIghting CESTIFICATE OF COMPLIANCE		CALIFURNIA ENERGY COMMISSION NRCC-LTI-E	STOTE OF CALFORMA Indoor Lighting GERTHACATE OF COMPLIANCE		CALIFORNIA ENERGY COMMISSION NRCC-1714	STATE OF CALFURNIA INDOOR LIghting CERTRICATE OF COMPLIANCE		California energy commission RRC(-171-2
Project Name: 19058.21 Redway Transfer Station - Weigh Station	Report Page:	(Page 4 of 7)	Project Name: 19086.21 Reciwey Transfer Station - Weigh Station	Report Page:	(Page 5 of 7)	Project Name: 19986.21 Redway Transfer Station - Weigh Station	Report Page:	(Page 6 of 7)
	Date Prepared:	2025-96-96115:04:32-94:90		Cate Frepared:	2025-06-08T15:04:32-04:00		Date Prepared:	2025-08-06T15:04:32-04:00
H. INDOOR LIGHTING CONTROLS (Not including PAFs)			LABORTIONAL ALLOWANCE, ADEA CATECORY METHOD CHALLENIN	IC LICHTING COGTERA		D 000/ LICHTING DOWER FOR ALL ALTERATIONS. CONTROLS EVERIN	IONE	
Area Level Controls			J. ADDITIONAL ALLOWANCE: AREA CATEGORY METHOD QUALIFYIN	IG LIGHTING SYSTEM		R. 80% LIGHTING POWER FOR ALL ALTERATIONS - CONTROLS EXCEPT	ions	
04 05	06 07 08 09	10 11 12	This section does not apply to this project.			This section does not apply to this project.		
Man	ual Area Multi-Level a primary/Sky Si	econdary Interlocked	W TAN ORDER METHOD CENTER IN DICHTER DOWNER AN OWNER.			C DAVISOR DESIGN DOMES ADMISTRAÇÃO DA FI		
Area Description Complete Building or Area Co	ntrols Controls Shut-Off Controls lit Daylighting	aylighting Systems Field Inspector	K. TAILORED METHOD GENERAL LIGHTING POWER ALLOWANCE			S. DAYLIGHT DESIGN POWER ADJUSTMENT FACTOR (PAF)		
Area	5/b/44 160.5(b)4C 130.1(d) / 160.5(b)4C 130.1(d) / 160.5(b)4C	30.1(d) / 14C.6(a)1/ 50.5(b)4D 170.2(e)2A	This section does not apply to this project.			This section does not apply to this project.		
	160.5[0]4D	Pass Fail	ASSITIONAL ISUTING LIES			T DWGU NG UNIT LIGHTING		
Walgh Station Restroom Per	eth. NA: Enclosed Occupancy Sensor MA: Not daylit zone di		L. ADDITIONAL LIGHTING ALLOWANCE: TAILORED WALL DISPLAY			T. DWELLING UNIT LIGHTING		
Po Po	solinei alea 1000r uayit zone u sadilw NA: Endosad NA: Not	NA. Na.	This section does not apply to this project.			This section does not apply to this project.		
	essible area <100SF Occupancy Sensor daylit zone di							
		13	M. ADDITIONAL LIGHTING ALLOWANCE: TAILORED FLOOR AND TAS	K LIGHTING		U. DECLARATION OF REQUIRED CERTIFICATES OF INSTALLATION	w 10 1 4 1 2 2 2 2	F 10 4 418 x 1 5 5 = 41 =
		Plan Shee: Showing Daylit Zones:	This section does not opply to this project.			Selections have been made based on information provided in this document.  Additional Remarks. These documents must be provided to the building inspe	if any selections have been changed by permit applicant, or ctor during construction and can be found anline	n explanation should be included in Table E.
						- contraction termination accountation times and for estate we say hyperide to be	Form/Title	
			N. ADDITIONAL LIGHTING ALLOWANCE: TAILORED DECORATIVE /SF	PECIAL EFFECTS			Formy little	
I. LIGHTING POWER ALLOWANCE: COMPLETE BUILDING OR ARE			This section does not opply to this project.			NRCI-LTI-E - Must be submitted for all buildings		
Each area complying using the Complete Euliding or Area Category Med 140.6(c) or adjustments per 140.6(a) are being used .	thods per 140.6(b) are included in this table. Column 06 indicates	if additional lighting power allowances per						
240.0(g) or adjustments per 140.0(g) are deing used.  Conditioned Spaces			O. ADDITIONAL LIGHTING ALLOWANCE: TAILORED VERY VALUABLE	MERCHANDISE		V. DECLARATION OF REQUIRED CERTIFICATES OF ACCEPTANCE		
01 02	03 04 05	06	This section does not apply to this project.	-		Selections have been made based on information provided in this document. Additional Remarks. These documents must be provided to the building inspe	if any selections have been changed by the permit applican	it, an explanation should be included in Table E.
Area Description Complete Building or Area Cat	regory Primary Allowed Density Allowed 3	Nattage Additional Allowarce / Adjustment				Additional Remarks. These documents must be provided to the building inspe Test Technician Certification Provider (ATTCP). For more information visits http://		e musc de completed tordugh an Acceptance
Area Description Function Area	(W/ft²) Area (ft²) (Wat		P. POWER ADJUSTMENT: LIGHTING CONTROL CREDIT (POWER ADJU	USTMENT FACTOR (PAF))		Form		Systems/Spaces To Be Field
Restroom Restroom	0.65 140 91		This section does not apply to this project.					
	0.65 80 52					NRCA-LTI-02-A - Must be submitted for occupancy sensors and automatic tim	e switch controls.	Verified
Restroom Restroom						. ,		Verified Weigh Station; Restroom
Restroom Restroom	TOTALS: 220 14		Q. RATED POWER REDUCTION COMPLIANCE FOR ONE-FOR-ONE AL This section does not apply to this project.	TERATIONS				
Restroom Restroom	TOTALS: 220   14			TERATIONS				
Restroom Restroom	TOTALS: 220 14			TERATIONS  Banerated Date/Time:	Documentation Software: Energy Code Aca		Generalisci Dete/Time:	
Restroom Restroom  CA Building Energy Effidency Standards - 2022 Nonreal dential Compliance		See Tables J, or P for detail			Documentation Software: Energy Code Ace Completion ID: 282723-0625-0010 Report Generated: 2025-06-10 A2:04-83	CA Bullding Energy Efficiency Standards - 2022 Nonreddential Compliance		Weigh Station; Restroom





IF NOT ONE INCH ON THIS SHEET, ADJUST SCALES ACCORDINGLY

	ROAD NAME: CONSERVATION CAMP RD		M.NEILS ENGINEERING	
ŅΝ	ROAD NO:	MILE POST:		
	PROJECT NO.: 438005	EA NO.:	DESIGNED BY: SKL	
	CONTRACT NO.:	BRIDGE NO:	DRAWN BY: PI	_
ON ST	DRAWING FILE NAME:		REVIEWED BY: SKL/JLB	
LY	PLOT DATE: 6/17/25	REVISION DATE:	APPROVED BY: JLB	
		-		

REDWAY TRANSFER STATION

TITLE 24 WEIGH STATION INDOOR & OUTDOOR LIGHTING

COUNTY OF HUMBOLDT DEPARTMENT OF PUBLIC WORKS

> 58 **E5.2**

STATE OF CALIFORNIA Indoor Lighting		CALIFORNIA ENERGY COMMISSION						
CERTIFICATE OF COMPLIANCE		MRCC-LTI-E	indoor Lighting Mandatory Measures:			Indoor Lighting Mandatory Measures:		
Project Name: 19086.21 Redwey Transfer Station - Weigh Station	Report Page:	(Page 7 of 7)	110.9 LIGHTING CONTROLS AND COMPONENTS			130.1(f) CONTROL INTERACTIONS		
Project Address:	Date Prepared:	2025-06-06T15:04:32-04:00	ALL LIGHTING CONTROL DEVICES AND SYSTEMS, AND ALL LIGHT SOURCES	SHALL MEET THE APPLICABLE REQUIREMENT	ITS OF 110.9.	EACH LIGHTING CONTROL INSTALLED TO MEET 130.1 REQUIREMENTS	S SHALL INCORPORATE THE FUNCTIONS OF OTHER LIGHT	TING CONTROLS REQUIRED BY THIS
			NOTE: THE EXCEPTED SPACES DO NOT COUNT TOWARDS THE 10,000 FT2 TI	HRESHOLD.		SECTION.		
			130.0 GENERAL LUMINAIRE REQUIREMENTS			1. FOR GENERAL LIGHTING, MANUAL AREA CONTROL SHALL PERMIT	THE LEVEL OF LIGHT PROVIDED WHILE LIGHTING IS ON T	TO BE SET OR ADJUSTED BY CONTROLS
DOCUMENTATION AUTHOR'S DECLARATION STATEMENT			ALL LUMINAIRES SHALL BE FACTORY-LABELLED PER 130.0(c).			SPECIFIED IN 130.1(b), (c), (d) and (e).		
I certify that this Certificate of Compliance documentation is accurat			ENERGY MANAGEMENT CONTROL SYSTEMS (EMCS) SHALL MEET REQUIRE	MENTS OF 130.0(e).		2. MANUAL AREA CONTROL SHALL PERMIT SHUTOFF CONTROL TO TU	IDNI THE LIGHTING DOWNLOD OFF	
Documentation Author Name: Julia L. Brodovsky	Documentation Author Signature:		130.1(a) MANUAL AREA CONTROLS			2. MANDAL AREA CONTROL SHALL PERMIT SHOTOFF CONTROL TO TO	JAN THE DOLLING DOWN ON OFF.	
Frances	Signature Date:		EACH ROOM OR AREA WITH FLOOR-TO-CEILING WALLS IN THIS BUILDING S	SHALL HAVE LIGHTING CONTROLS THAT ALLO	OW LIGHTING TO BE MANUALLY TURNED ON	3. MULTILEVEL CONTROL SHALL PERMIT THE AUTOMATIC DAYLIGHTIN	NG CONTROL TO ADJUST ELECTRIC LIGHTING IN RESPONS	ISE TO DAYLIGHT.
M. Neils Engineering	06/17/2025		AND OFF MANUAL CONTROLS SHALL:			4. MULTILEVEL CONTROL SHALL PERMIT THE DEMAND RESPONSIVE (I	DR) CONTROL TO ADJUST LIGHTING DURING A DR EVENT	IT THEN RETURN IT TO THE LEVEL SET BY
Auktress: 100 HOWE AVE, SUITE 235N	CEA/ HERS Certification Identification (if applicable):		1. BE READILY ACCESSIBLE			THE CONTROL AFTER THE EVENT.	•	
CHy/Ytran/Zip: SACRAMENTO, CA 95825	Phone: (916) 923-4400		2. BE LOCATED IN THE SAME ENCLOSED AREA WITH THE LIGHTING IT CONT			5 SHUTOFF CONTROL SHALL PERMIT THE MANUAL AREA CONTROL TO	O TURN THE LIGHTING ON	
RESPONSIBLE PERSON'S DECLARATION STATEMENT			3. PROVIDE SEPARATE CONTROL OF GENERAL, FLOOR, WALL, WINDOW CA.		ECTS LIGHTING SO EACH TYPE CAN BE TURNED			
I contify the full being under panelty of perjury, under the base of the State of California:  1. The information provided on this Cartificans of Compliance is true and correct.			ON AND OFF SEPARATELY WITHOUT AFFECTING OTHER LIGHTING OR EQUI	PMENI.		6. AUTÓMATIC DAYLIGHTING CONTROL SHALL PERMIT MULTILEVEL LI	IGHTING CONTROL TO ADJUST THE LIGHTING LEVEL.	
2. I am a ligible under Division 8 of the Business and Professions Code to accept respon 8. The energy features and performance accellations, materials, components, and monitorials, components, and monitorials 4, Part 3 and Fart 5 of the California Code of Regulations. 4. The building design features or system design features blend field on this Cartificate.	nanufactured devices for the building design or system design identified on	on this Certificate of Compilance conform to the requirements	130.1(b) MULTILEVEL LIGHTING CONTROLS  GENERAL LIGHTING IN ALL ROOMS AND AREAS 100 FT2 OR GREATER AND CONTROLS THAT ALLOW LIGHT LEVELS TO BE ADJUSTED UP AND DOWN. O			7. FOR LIGHTING CONTROLLED BY MULTILEVEL LIGHTING CONTROLS. SHALL PROVIDE A PARTIAL-ON FUNCTION THAT IS CAPABLE OF AUTOR		
plans and specifications submitted to the enforcement agency for approval with this	s building permit application.		LEVELS PER TABLE 130.1-A.			8. RESERVED		
<ol><li>I will ensure that a completed signed copy of this Certificate of Compilance shall be inspections. I understand that a completed signed copy of this Certificate of Compila</li></ol>	made available with the building permit(s) leaved for the building, and malance is required to be included with the documentation the builder provide	nace available to the entercoment agency for all applicable fides to the building owner at occupancy.	130.1(c): SHUTOFF CONTROLS	A STORAGETICALLY DEDUCE LUCUSTAIN COMM	ED WHIEN EDACE IS TWO/CALLY UNICECUDIES	9. FOR SPACE CONDITIONING SYSTEM ZONES SERVING ONLY SPACES 1	THAT ARE REQUIRED TO HAVE OCCUPANT SENSING CONT	TROLS SHALL BE CONTROLLED BY
Pleassons ikie Designer Herne:	Responsible Designer Signature:		ALL INSTALLED INDOOR LIGHTING SHALL BE EQUIPPED WITH CONTROLS TO	J AUTOMATICALLY REDUCE LIGHTING POWE	IN WHICH SPREE IS TYPICALLY UNDCCUPIED.	OCCUPANCY SENSING CONTROLS.		
Julia L. Brodovsky	ht.		130.1(c)1: CONTROL REQUIREMENTS ALL INSTALLED INDOOR LIGHTING SHALL HAVE ALL OF THE FOLLOWING:					
Company: NJ. Neils Engineering	Date Signed: 06/17/2025		A. CONTROL(S) CAPABLE OF AUTOMATICALLY SHUTTING OFF ALL LIGHTING	IN THE SPACE WHEN TYPICALLY LINGUISH	ED (OCCUPANT SENSING CONTROL ALTOMATIC			
No. Nells Engineering Address: 100 HOWE AVE, SUITE 235N	License: E24535		TIME-SWITCH CONTROL, OR OTHER)		The state of the s			
City/State/Zip: SACRAMENTO, CA 95825	Phone: (916) 923-4400		B. SEPARATE CONTROLS FOR LIGHTING ON EACH FLOOR (OTHER THAN STA	JRWELLS)				
~ 1 F SACHAMENTO, OA 33023	[······ (010) 020 TT00		C. SEPARATE CONTROLS FOR A SPACE ENCLOSED BY CEILING HEIGHT PART					
			130.1(c)@ PARTIAL OR FULL-OFF OCCUPANT SENSORS	initial terral Excessive speed in				
			PROVIDE PARTIAL OR FULL-OFF OCCUPANT SENSORS, IN ADDITION TO SHU  AUSLE WAYS AND OPEN AREAS IN WAREHOUSES  LIBRARY BOOK STACK AISLES  CORRIDORS AND STAIRWELLS  OFFICES GREATER THAN 250 SQ. FT.	ITOFF CONTROLS PER 130.1(e)1 AND 130.1(e	:)2, IN THE FOLLOWING SPACES:			
STATE OF CALIFORNIA  Outdoor Lighting  CERTIFICATE OF CONFILANCE  This document is used to demonstrate compliance with requirements in 110.1 parnesidential and hotel/motel occupancies. It is also used to document compliance to the prescription of the properties of the properties. Authoritisms	upliance with requirements in 160.5, 170.2(e)6, 180.1(a) and		STOTE OF CAUPCINA  Outdoor Lighting  CERTHICATE OF COMPLIANCE  Project Name: 19085-21 Rectivey Transfer Station - Weigh Station	Regort Page: Dato Frapered:	CALIFORNIA ENERGY COMMISSION MRCC-170-E (Page 2 of 7) 2023-06-05TL8:38:53-04:00	STATE OF CALEGRAIA  Outdoor Lighting  CERTHICATE OF COMPLIANCE  Project Russes 19086, 21 Redway Transfer Station - Weigh Station	Report Page: Data Prapared:	CALIFORNIA ENERGY COMMISSION NRCC4170-4 (Page 8 of 7) 2025-05-05718:86:51-04:00
Outdoor Lighting  CERTHICATE OF COMPLIANCE  This document is used to demonstrate compliance with requirements in 110.5	upliance with requirements in 160.5, 170.2(e)6, 180.1(a) and	RECC-LTO-E scapes using the prescriptive path for	Outdoor Lighting CERTIFICATE OF COMPLIANCE		NRCC-LTO-E (Page I of 7)	Outdoor Lighting CERTIFICATE OF COMPLIANCE		NRCC-LTO-E (Page 3 of 7)
Outdoor Lighting CERTERCATE OF COMPLANCE This document is used to demonstrate compliance with requirements in 110. This document is used to demonstrate compliance with requirements in 110, nonresidential and hotel/matel occupencies. It is also used to document compliance prescriptive parts for multiplimity and mitted uses occupencies. Multiplimity	pliance with requirements to 160.5, 170.2(e)6, 180.1(a) and Includes dormitory and senior living facilities.	MECC-LTO-E scapes using the prescriptive path for rd 180.2(b)48v for cutdoor lighting scapes using	Outdoor Lighting CERTIFICATE OF COMPLIANCE		NRCC-LTO-E (Page I of 7)	Outdoor Lighting CERTHICATE OF COMPLIAN CE Project Risme: 19056,21. Redway Transfer Station - Weigh Station		NRCC-LTO-E (Page 3 of 7)
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Outdoor Lighting  CERTIFICATE OF COMPLIANCE  This document is used to demonstrate compliance with requirements in 110.3  nonresidential and hotel/incitel occupancies. It is also used to document compute prescriptive part for multifornily and mitted-use accopancies. Multifornity  Project Nation  1006.11 Redway Tensfer Station - Weigh Station  Project Address:	pliance with requirements in 160.5, 170.2(e)6, 180.1(a) and i includes dormitary and senior living facilities.  Report Page:	NMCC-110-E scapes using the prescriptive path for of 180,2(b)490 for autidox lighting scapes using (Fege 1 of 7)	Outdoor Lighting CERTHICATE OF COMPLIANCE Project Name: 19066.21 Redway Transfer Station - Weigh Station	Daka Frapened:	NRCC-170-E (Page 2 of 7) 2023-06-05T18:38:53-04:00	Outdoor Lighting CERTHICATE OF COMPLIAN CE Project Risme: 19056,21. Redway Transfer Station - Weigh Station	Date Prepared:  170.2(e)5 oil new luminaires being installed and any existing h	NRCC-170-1 (Page 3 of 7) 2025-06-03718-38-531-04-00  uminaires remaining ar being moved within
Outdoor Lighting  CERTIFICATE OF COMPLIANCE  This document is used to demonstrate compliance with requirements in 110.1  This document is used to demonstrate compliance with requirements in 110.1  Oncestification and hotely/motel occupancies. It is also used to document company the prescriptive path for multiformity and mised-use accopancies. Multipliantly Project Name:  15080.11 Redway Transfer Station - Weigh Station  Froject Address:  A. GENERAL INFORMATION	pliance with requirements in 160.5, 170.2(e)6, 180.1(a) and i includes dormitary and senior living facilities.  Report Page:	NMCC-110-E scapes using the prescriptive path for of 180,2(b)49v for autidox lighting scapes using (Fege 1 of 7)	Outdoor Lighting CERRICATE OF COMPLIANCE Project Name: 19066.21 Redway Transfer Station - Weigh Station  C. COMPLIANCE RESULTS Results in this table are outcomatically calculated from data input and calculations to Table D. Exceptional Conditions for guidence or see applicable Table referenced.	Date Prepared:  In Tables F through N. Note: If any cell on this tab below.	NRCC-170-E (Page 2 of 7) 2023-06-05T18:38:53-04:00	Outdoor Lighting CRRITICATE OF COMPLIANCE Project Reme: 19086.21 Redway Transfer Station - Weigh Station  F. OUTDOOR LIGHTING FIXTURE SCHEDULE For new or attered lighting systems demonstrating compliance with 140.7/1 the spaces covered by the permit application are included in the Table below, installed and replacement luminaries being installed as part of the project sc	Date Prepared:  170.2(e)& oil new lumbraires being installed and any existing hy. For altered lighting systems using the Existing Power method open are including or existing.	NRCC-170-1 (Page 3 of 7) 2025-06-05718-28:23-0-6:00  umbraines remaining or being moved within of per 141. (Paj22 only new harmonies being harmonies have harmonies being harmonies have growed are not included).
Outdoor Lighting  CERTIFICATE OF COMPLIANCE This document is used to demonstrate compliance with requirements in 110.  In annexidential and hotel/matel occupancies. It is also used to document compliance of the prescriptive path for multiformity and mbard-use occupancies. Multiformity  Project Nates: 19086.11 Redway Transfer Statlan - Weigh Station  Froject Address:  A. GENERAL INFORMATION  01 Project Location (city) Redway, CA	pliance with requirements in 160.5, 170.2(e)6, 180.1(a) and i includes dormitary and senior living facilities.  Report Page:	scapes using the prescriptive path for vd 180.2(b)49v for outdoor lighting scapes using vd 180.2(b)49v for outdoor lighting scapes using (frage 1 of 7) 2025-98-95T18:38:51-04:00	Outdoor Lighting  CERTHCATE OF COMPLIANCE  Project Name: 19085.21 Redway Transfer Station - Weigh Station  C. COMPLIANCE RESULTS  Results in this table are automatically calculated from data input and calculations to Table D. Exceptional Canditions for guidance or see applicable Table referenced.  Calculations of Total Allowed Lighting Power (Watts) 140.7 / 170.2(e)6 of the contraction of t	Date Prepared:  in Tables F through N. Hote: If any cell on this tab below. or 141.0(b)2L / 180.2(b)48v	NRCC-LTC-E (Page 2 of 7) 2023-06-05TL8:38:53-04:00  ble says "COMPLIES with Exceptional Conditions" refer  Compliance Results	Outdoor Lighting  CRRITICATE OF COMPLIANCE Project Russe: 19086,21 Redway Transfer Station - Weigh Station  F. OUTDOOR LIGHTING FIXTURE SCHEDULE For new or altered lighting systems demonstrating compliance with 140.7 / 3 the spaces covered by the permit application are included in the Table below installed and replacement luminates being installed as port of the project to Courtions (gifting attacked to multifyram) buildings and controlled from the in-	Date Prepared:  170.2(e)& oil new lumbraires being installed and any existing hy. For altered lighting systems using the Existing Power method open are including or existing.	NRCC-170-1 (Page 3 of 7) 2025-06-05718-28:23-0-6:00  umbraines remaining or being moved within of per 141. (Paj22 only new harmonies being harmonies have harmonies being harmonies have growed are not included).
Outdoor Lighting  Contractor of Communication of Section 2. Sectio	pikance with requirements in 160.5, 170.2(e)6, 160.1(a) one includes domitiony and senior living facilities.    Report Pages   Date Prepared:    Date Prepared:	scapes using the prescriptive path for vd 180.2(b)49v for outdoor lighting scapes using vd 180.2(b)49v for outdoor lighting scapes using (frage 1 of 7) 2025-98-95T18:38:51-04:00	Outdoor Lighting CERRICATE OF COMPLIANCE Project Name: 19066.21 Redway Transfer Station - Weigh Station  C. COMPLIANCE RESULTS Results in this table are outcomatically calculated from data input and calculations to Table D. Exceptional Conditions for guidence or see applicable Table referenced.	Date Prepared:  In Tables F through N. Hote: If any cell on this tab below.  05 06 07	NRCC-LTC-E (Page 2 of 7) 2023-06-05TL8:38:53-04:00  ble says "COMPLIES with Exceptional Conditions" refer  Compliance Results	Outdoor Lighting  CRRITICATE OF COMPLIANCE  Project Names 19056.21 Redway Transfer Station - Weigh Station  F. OUTDOOR LIGHTING FIXTURE SCHEDULE  For new or attered highting systems demonstrating compliance with \$40.77 / 3 the spaces covered by the permit application are included in the Table below installed and replacement luminatives being installed as port of the project so Outdoor lighting attached to malitformity buildings and controlled from the in lighting is included heart.	Date Prepared:  170.2(e)& oil new lumbraires being installed and any existing hy. For altered lighting systems using the Existing Power method open are including or existing.	NRCC-170-1 (Page 3 of 7) 2025-06-05/18-28-23-06-00  umbraines remaining or being moved within a per 141. (Paj22 only new harmonies being humbaries to findules), humbaries being moved are not fooded).
Outdoor Lighting  Castificate Or COMMINANCE  This document is used to demonstrate compliance with requirements in 110.3 nonresidential and hotel/incite/ occupancies. It is also used to document compute prescriptive part for multiformity and initiad-use accorpancies. Multiformity Project Name: 15086.11 Redway Transfer Station - Weigh Station  Froject Address:  A. GENERAL INFORMATION  01 Project Location (dity) Redway, CA  02 Clamata Zone 2  03 Outdoor Lighting Zone per Title 24 Part 110.114 or as designated by Au	uplicance with requirements in 160.5, 170.2(rijs, 160.5(ri) one / Includes domitrary and senior living facilities.  Report Page:  Date Prepared:  O4 Total Illuminated Hardscape Area (ft <sup>2</sup> )  uthority Having Jurisdiction [AHI]:	INSCCLTG-E	CERTIFICATE OF COMPLIANCE Project Name: 19066.21 Redwey Transfer Station - Weigh Station  C. COMPLIANCE RESULTS  Results in this table are automatically calculated from data input and calculations to Table D. Exceptional Canditions for guidance or see applicable Table referenced  Calculations of Total Allowed Lighting Power (Watts) 140.7 / 170.2(e)6 ( 0.1 0.2 0.3 0.4 0.4 0.5 0.4 0.5 0.4 0.5 0.5 0.5 0.5 0.5 0.5 0.5 0.5 0.5 0.5	In Tables F through N. Hote: If any cell on this tableton.  or 143.0(b)21. / 180.2(b)48v  05 06 07  Per Snerific Existing	NRCC-LTC-E (Page 2 of 7) 2023-06-05TL8:38:53-04:00  ble says "COMPLIES with Exceptional Conditions" refer  Compliance Results	Outdoor Lighting CRRITICATE OF COMPLIANCE Project Rames 19086.21 Redway Transfer Station - Weigh Station  F. OUTDOOR LIGHTING FIXTURE SCHEDULE For new or attered highting systems demonstrating compliance with 140.7/1 the spaces covered by the permit application are included in the Table below, installed and replacement luminaries being installed as part of the project so Outdoor lighting attached to multiformly buildings and controlled from the in lighting is included here.  Designed Wattages.	Data Proporad:  170. If p 6 oil new kumbrolines being installed and any existing N  For altered lighting systems using the Existing Power method cape are included (le, existing luminaires remaining or existing installed of a dwelling unit are included in Table H. and are not inc	NRCC-170-1 (Page 3 of 7) 2025-08-03718-38:531-04-00  umbioirez remaining or being moved within a per 141,08)21 only new humboires being humboires being humboires being humboires being chudedly.
Outdoor Lighting  CERTIFICATE OF COMPLIANCE This document is used to demonstrate compliance with requirements in 110.  Institute of the control of the contr	uplance with requirements to 160.5, 170.2(e)e, 160.1(e) and includes dormitory and senior living facilities.  Report Page:  Date Prepared:  O4 Total Illuminated Hardscape Area (ft <sup>3</sup> ) uthority Having Jurisdiction [AH]:  Clusters  D24: High - Must be reviewed by CA E	INSCCLTG-E	CERTHICATE OF COMPLIANCE Project Name: 19066.21 Redway Transfer Station - Weigh Station  C. COMPLIANCE RESULTS Results in this table are cutomatically calculated from data input and calculations to Table D. Exceptional Conditions for guidance or see applicable Table referenced.  Calculations of Total Allowed Lighting Power (Watts) 140.7 / 170.2(e)6 d  O1	Disks Frepared:	INCC-LTC-E (Page 2 of 7) 2025-06-05TL8:88:51-04:00  bite says "COMPLES with Exceptional Conditions" refer  Compliance Results 7	Outdoor Lighting  CRRITICATE OF COMPLIANCE  Project Names 19056.21 Redway Transfer Station - Weigh Station  F. OUTDOOR LIGHTING FIXTURE SCHEDULE  For new or attered highting systems demonstrating compliance with \$40.77 / 3 the spaces covered by the permit application are included in the Table below installed and replacement luminatives being installed as port of the project so Outdoor lighting attached to malitformity buildings and controlled from the in lighting is included heart.	Date Prepared:  170.2(e)& oil new lumbraires being installed and any existing hy. For altered lighting systems using the Existing Power method open are including or existing.	NRCC-170-1 (Page 3 of 7) 2025-06-03718-38:53-04-00  uminoires remaining ar being moved within of per 141, (Ne)21 only new hamtonires being hamtonires to troubed), cluded here. All other multifamily outdoor  08 09 10
Cestriscare of Communications	uplance with requirements to 160.5, 170.2(e)e, 160.1(e) and includes dormitory and senior living facilities.  Report Page:    Date Prepared:    O4   Total Illuminated Hardscape Area (ft <sup>2</sup> )   United States   United States	INSCCLTG-E	CERTHCATE OF COMPLIANCE Project Name: 19086.21 Redwey Transfer Station - Weigh Station  C. COMPLIANCE RESULTS Results in this table are outcomatically calculated from data input and calculations to Table D. Exceptional Conditions for guidance or see applicable Table referenced.  Calculations of Total Allowed Lighting Power (Watts) 140.7 (170.2(e) 6 c  General Per Sales Ornamental Hardscape Application + Frontage + 140.7(d) 2 / 140.7(d) 2 / 140.7(d) 2 / 170.7(d) 5 / 170	Date Prepared:	NRCC-LTC-E (Pregs 2 of 7) 2023-06-05TL8:8:53-04:00  ble says "COMPLIES with Exceptional Conditions" refer  Compliance Results 7 08 09  Illowed ≥ Total Actual 07 outs to >= 08	Outdoor Lighting CRRITICATE OF COMPLIANCE Project Russe: 19086,21 Redway Transfer Station - Weigh Station  F. OUTDOOR LIGHTING FIXTURE SCHEDULE For new or altered lighting systems demonstrating compliance with 140.7 / 1 the spaces covered by the permit application are included in the Table below installed and replacement luminaires being installed as port of the project so Outdoor lighting attacked to multiformly buildings and controlled from the in lighting is included here.  Designed Wattage:  01 02 03	Data Proposed:  170.2(e)5 oil new luminaires being installed and any existing har. For altered lighting systems using the Existing Power method cope are included (le, existing luminaires remaining or existing raide of a dwelling unit are included in Table H. and are not inc.  04 05 06 07  How is Evaluated per	NRCC4TO-1 (Page 3 of 7) 2025-08-05718-38-31-04-00  Lyminairee remaining at being moved within at per 141.016)21 only new huminairee being huminairee being moved are not included; studed here. All other multifamily outdoor  08 05 10  Cutoff Req. > Field
Outdoor Lighting  Cestificate of COMPLIANCE This document is used to demonstrate compliance with requirements in 110.1 nonresidential and hately/noted occupancies. It is also used to document compute prescriptive part for multifornily and mibrad-use occupancies. Multifornily Project Name: 19086.11 Redway Transfer Station - Weigh Station Froject Address:  A. GENERAL INFORMATION  3.1 Project Location (dity) Redway. CA  Climate Zone 2  Climate Zone 2  Climate Zone 1  L2-0: Very Low - Undeveloped Parkland 1  L2-2: Moderate - Urban C  L2-1: Low - Rural Areas  □ L2-3: Moderate - Urban C  5. Occupancy Types within Project	uplance with requirements to 160.5, 170.2(e)e, 160.1(e) and includes dormitory and senior living facilities.  Report Page:    Date Prepared:    O4   Total Illuminated Hardscape Area (ft <sup>2</sup> )   United States   United States	INSCCLTG-E	CERTIFICATE OF COMPLIANCE Project Hame: 19080-21 Redwey Transfer Station - Weigh Station  C. COMPLIANCE RESULTS Results in this table are automatically calculated from data input and calculations to Table D. Exceptional Conditions for guidance or see applicable Table referenced.  Calculations of Total Allowed Lighting Power (Watts) 140.7 / 170.2(e) 6 General Per Sales Ornsmettal Frontage Allowance Allowance 140.7(d) 2 / 170.2(e) 6 170.2(e) 6 (see Table I)	Date Prepared:	NRCC-LTC-E (Pregs 2 of 7) 2023-06-05TL8:8:53-04:00  ble says "COMPLIES with Exceptional Conditions" refer  Compliance Results 7 08 09  Illowed ≥ Total Actual 07 outs to >= 08	CARTHEATE OF COMPLIANCE Project Name: 19056.21 Redway Transfer Station - Weigh Station  F. OUTDOOR LIGHTING FIXTURE SCHEDULE For new or aftered lighting systems demonstrating compliance with \$40.7 / 5 the spaces covered by the permit application are included in the Table below insculled and replacement luminatives being installed as part of the project sc Outdoor lighting attached to multiformity buildings and controlled from the in lighting is included here.  Designed Westings:  01 02 03  Name or Item  Complete Luminaire Description  Watts per	Data Prepared:  170 2[e]5 oil new luminaires being installed and any existing in.  It for altered lighting systems using the Existing Power method cape are included [le, existing luminaires remaining or existing inside of a dwelling unit are included in Table H. and are not inc.  O4 05 06 07  How is Total Number Luminaire Excluded per Wattage	NRCC-LTO-t (Page 3 of 7) 2025-06-05718-38-31-04-000  Numinalines remaining at being moved within d per 141.0fb)21 andy new huminalines being huminatires being moved are not included). cluded here. All other multifamily outdoor  0.8 0.9 10  Cutoff Req. > 6,200 initial Design Watts   Iumen output  Design Watts   Iumen output
Outdoor Lighting  CestraticArt Or COMPLANCE This document is used to demonstrate compliance with requirements in 110.1 nonresidential and hatel/matel occupancies. It is also used to document compthe prescriptive parts for multiprofile and mibad-use accupancies. Multiplimity Project Names: 1998.11 fedway Transfer Station - Weigh Station Froject Address:  A. GENERAL INFORMATION  11 Project Location (city) Redwey, CA  22 Charate Zone 2  33 Outdoor Lighting Zone per Title 24 Part 1.10.114 or as designated by Au  1 LZ-2: Lovy Low - Undewloped Parkland 3 LZ-2: Moderate - Urban C LZ-3: Lovy - Rural Areas 1 LZ-3: Moderately High - L	uplance with requirements to 160.5, 170.2(e)e, 160.1(e) and includes dormitory and senior living facilities.  Report Page:    Date Prepared:    O4   Total Illuminated Hardscape Area (ft <sup>2</sup> )   United States   United States	INSCCLTG-E	CERTRICATE OF COMPLIANCE Project Name: 19065.21 Redway Transfer Station - Weigh Station  C. COMPLIANCE RESULTS  Results in this table are outcomatically calculated from data input and calculations to Table D. Exceptional Canditions for guidence or see applicable Table referenced:  Calculations of Total Allowed Lighting Power (Watts) 140.7 / 170.2(e)6  O1	Disks Frepared:	NRCC-LTC-E (Page 2 of 7)  2025-06-05TL8:88:51-04:00  ble says "COMPUES with Exceptional Conditions" refer  Compliance Results 7	CARTHCATE OF COMPLIANCE Project Rismes: 19086.21 Redway Transfer Station - Weigh Station  F. OUTDOOR LIGHTING FIXTURE SCHEDULE For new or attered lighting systems demonstrating compliance with 140.7/1 the spaces covered by the permit application are included in the Toble below installed and replacement luminative being installed as part of the project sc Outdoor lighting attached to multiformly buildings and controlled from the in lighting is included for an.  Designed Wattage:  01 02 03  Name or term	Data Proporad:  1.70.2 (e) 6 oil new kumbnoires being installed and any existing N I. For altered lighting systems using the Existing Power method cape are included (le, existing luminaires remaining or existing installed of a dwelling unit are included in Table H. and are not the  0.4 0.5 0.6 0.7  How is Total Number Luminaire Excluded per	NRCC-170-1 (Page 3 of 7) 2025-08-03718-38:51-04-00  umbinaires remaining or being moved within of per 141,08/21 only new harmonies being humbares of the being humbare
Outdoor Lighting  Cestificate of COMPLIANCE This document is used to demonstrate compliance with requirements in 110.1 nonresidential and hately/noted occupancies. It is also used to document compute prescriptive part for multifornily and mibrad-use occupancies. Multifornily Project Name: 19086.11 Redway Transfer Station - Weigh Station Froject Address:  A. GENERAL INFORMATION  3.1 Project Location (dity) Redway. CA  Climate Zone 2  Climate Zone 2  Climate Zone 1  L2-0: Very Low - Undeveloped Parkland 1  L2-2: Moderate - Urban C  L2-1: Low - Rural Areas  □ L2-3: Moderate - Urban C  5. Occupancy Types within Project	uplance with requirements to 160.5, 170.2(e)e, 160.1(e) and includes dormitory and senior living facilities.  Report Page:    Date Prepared:    O4   Total Illuminated Hardscape Area (ft <sup>2</sup> )   United States   United States	INSCCLTG-E	CERTRICATE OF COMPLIANCE Project Name: 19086-21 Redwey Transfer Station - Weigh Station  C. COMPLIANCE RESULTS  Results in this tobbic are automatically calculated from data input and calculations to Table 2. Exceptional Conditions for guidance or see applicable Table referenced.  Calculations of Total Allowed Lighting Power (Watts) 140.7 (17.0.2(e) 6  General Per Sales Ornamental Hardscape Allowance - Application 4.10.7(d) 2. 170.2(e) 6  Allowance 1.40.7(d) 4. 170.7(e) 6. [See Table 1) [See Table 1) [See Table 1) [See Table 1) [See Table 1] [See Table 2] [See Table 3] [See Table 3] [See Table 4] [See Table 4] [See Table 5] [See Table 6] [See Table 6] [See Table 7] [See Table 7] [See Table 8]	Date Frepared:	NRCC-LTC-E (Page 2 of 7)  2025-06-05TL8:88:51-04:00  ble says "COMPUES with Exceptional Conditions" refer  Compliance Results 7	CARTHEATE OF COMPLIANCE Project Name: 19056.21 Redway Transfer Station - Weigh Station  F. OUTDOOR LIGHTING FIXTURE SCHEDULE For new or aftered lighting systems demonstrating compliance with \$40.7 / 5 the spaces covered by the permit application are included in the Table below insculled and replacement luminatives being installed as part of the project sc Outdoor lighting attached to multiformity buildings and controlled from the in lighting is included here.  Designed Westings:  01 02 03  Name or Item  Complete Luminaire Description  Watts per	Data Prepared:  170 2[e]5 oil new luminaires being installed and any existing in.  It for altered lighting systems using the Existing Power method cape are included [le, existing luminaires remaining or existing inside of a dwelling unit are included in Table H. and are not inc.  O4 05 06 07  How is Total Number Luminaire Excluded per Wattage	NRCC-170-1 (Page 3 of 7) 2025-06-03718-38:53-04-000  Luminolnes remaining or being moved within of per 141, (Rip)21 only new humanoires being humanoires heing naved are not included), cluded kere. All other multifamily outdoor    OB
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Certificate of Commercial Section 1.10.  Certificate Section 1.10.  Certificate Section 1.10.  A. General Information  OI Project Address:  A. General Information  OI Project Location (dity)  Certificate Section 1.10.  Redwey, CA  Commercial Industrial  Discovery Love - Undeveloped Parkiand  Certificate Section 1.10.  Certificate Sect	uplance with requirements in 160.5, 170.2(e)e, 160.1(e) and includes dormitory and senior living facilities.  Report Page:  Date Prepared:  O4 Total Illuminated Hardscape Area (ft <sup>3</sup> )  uthority Having Jurisdiction (AHJ):  Clusters  L2-4: High - Must be reviewed by CA E	INSCCLTO-E scapes using the prescriptive path for rel 180.2(b)489 for outdoor lighting scapes using  (Fage 1 of 7)  2025-98-05/18:38:51-04:00  3) Soo Energy Commission for Approval	CERTRICATE OF COMPLIANCE Project Hame: 19086.21 Redwey Transfer Station - Weigh Station  C. COMPLIANCE RESULTS Results in this table are outcomatically calculated from data input and calculations to Table D. Exceptionari Conditions for guidence or see applicable Table referenced.  Calculations of Total Allowed Lighting Power (Watts) 140.7 / 170.2(e)6 (General Hardscape Allowance Allowance Allowance Allowance 140.7(d)12 / 170.2(e)6 (See Table II) (See Table III) (See Table III) (See Table III) (See Table III) (See Table IIII) (See Table IIII) (See Table IIIIIIIIIIIIIIIIIIIIIIIIIIIIIIIIIIII	Date Frepared:	NRCC-LTC-E   (Preps 2 of 7)	CARTHEATE OF COMPLIANCE Project Name: 19056.21 Redway Transfer Station - Weigh Station  F. OUTDOOR LIGHTING FIXTURE SCHEDULE For new or aftered highting systems demonstrating camplicance with \$40.77 / s. the spaces covered by the permit application are included in the Table below installed and replacement luminaires being installed as port of the project so Outdoor lighting attached to multiformly buildings and controlled from the in lighting is included here.  Designed Whattage:  O1 02 03  Name or Item Tag  Complete Luminaire Description  Watts per uninaire 1-2	Data Prepared:   170_2[e]5 all new luminaires being installed and any existing N. I. For altered lighting systems using the Existing Power method cape are included (le, existing luminoires remaining or existing inside of a diseiling unit are included in Table H. and are not the   04	NRCC-LTO-t (Page 3 of 7) 2025-08-05718-38-30-00000  Naminaires remaining ar being moved within of per 141.0fb/21 cmly new huminaires being thaminaires being moved are not included). cluded here. All other multifamily outdoor  0.8 09 10  Curoff Req. > 6,200 initial Lumen output. 120.2(b) / 160.5(c)14  NA: Illuminate public NA: Illuminate
Cestificate of COMPLIANCE This document is used to demonstrate compliance with requirements in 110.1 nonresidential and hotel/motel occupancies. It is also used to document compthe prescriptive path for multifornity and mibad-use accupancies. Multifornity Project Name: 1998.11 fedway Tensfer Statten - Weigh Station Froject Address:  A. GENERAL INFORMATION  11 Project Location (city) Redwey, CA  22 Charate Zone  2 Charate Zone  2 Charate Zone  12 L2-3: Love - Rural Areas  12 L2-3: Love - Rural Areas  13 Decupancy Types within Project  2 Commercial industrial  B. PROJECT SCOPE  This table Includes outdoor lighting systems that are within the scope of the p	uplance with requirements in 160.5, 170.2(e)e, 160.1(e) and includes dormitory and senior living facilities.  Report Page:  Date Prepared:  O4 Total Illuminated Hardscape Area (ft <sup>3</sup> )  uthority Having Jurisdiction (AHJ):  Clusters  L2-4: High - Must be reviewed by CA E	INSCCLTO-E scapes using the prescriptive path for rel 180.2(b)489 for outdoor lighting scapes using  (Fage 1 of 7)  2025-98-05/18:38:51-04:00  3) Soo Energy Commission for Approval	CERTRICATE OF COMPLIANCE Project Hame: 19086.21 Redwey Transfer Station - Weigh Station  C. COMPLIANCE RESULTS Results in this table are outcomatically calculated from data input and calculations to Table D. Exceptionari Conditions for guidence or see applicable Table referenced.  Calculations of Total Allowed Lighting Power (Watts) 140.7 / 170.2(e)6 (General Hardscape Allowance Allowance Allowance Allowance 140.7(d)12 / 170.2(e)6 (See Table II) (See Table III) (See Table III) (See Table III) (See Table III) (See Table IIII) (See Table IIII) (See Table IIIIIIIIIIIIIIIIIIIIIIIIIIIIIIIIIIII	Date Frepared:	NRCC-LTC-E   (Preps 2 of 7)	CRITICATE OF COMPLIANCE Project Russes: 19056.21 Redway Transfer Station - Weigh Station  F. OUTDOOR LIGHTING FIXTURE SCHEDULE For new or attered lighting systems demonstrating compliance with 140.7 / 3 the spaces covered by the permit application are included in the Table below installed and replacement luminaires being installed as port of the project so Custors lighting attacked to multiformly buildings and controlled from the in lighting is included here.  Designed Wattages:  01 02 03  Name or Item Tag Complete Luminaire Description Watts per uminaire 1.2  C1 OUTDOOR WALL LED Unear 68	Data Prepared:   170_2[e]5 oil new luminaires being installed and any existing N. Ror altered lighting systems using the Existing Power method cape are included (le, existing luminoires remaining or existing inside of a dwelling unit are included in Table H. and are not inc.    04	NRCC-LTO-t (Page 3 of 7) 2025-08-05718-38-30-00000  Naminaires remaining ar being moved within of per 141.0fb/21 cmly new huminaires being thaminaires being moved are not included). cluded here. All other multifamily outdoor  0.8 09 10  Curoff Req. > 6,200 initial Lumen output. 120.2(b) / 160.5(c)14  NA: Illuminate public NA: Illuminate
Centricate Or Communication of Communication Compliance with requirements in 110.1 nonresidential and hotel/motel occupancies. It is also used to document compliance with requirements in 110.1 nonresidential and hotel/motel occupancies. It is also used to document compute prescriptive path for multipornity and mibad-use acceptancies. Multiplimity Project Name: 19086.11 Redway Transfer Station - Weigh Station Froject Address:  A. GENERAL INFORMATION  11 Project Location (city) Redway. CA  22 Charate Zone 23 Ourdoon Lighting Zone per Title 24 Part 1 10.114 or as designated by Au  12 L2-0: Very Low - Undevloped Parthand S L2-2: Moderate - Urban C L2-1: Low - Rural Areas D L2-3: Moderate - Urban C L2-1: Low - Rural Areas D L2-3: Moderately High - L  15 Occupancy Types within Project  2 Commercial Industrial  B. PROJECT SCOPE  This table Includes outdoor lighting systems that are within the scope of the plant of the Project Consists of the Project Consists of	uplance with requirements in 160.5, 170.2(e)e, 160.1(e) and includes dormitory and senior living facilities.  Report Page:  Date Prepared:  O4 Total Illuminated Hardscape Area (ft <sup>3</sup> )  uthority Having Jurisdiction (AHJ):  Clusters  L2-4: High - Must be reviewed by CA E	INSCCLTO-E scapes using the prescriptive path for rel 180.2(b)489 for outdoor lighting scapes using  (Fage 1 of 7)  2025-98-05/18:38:51-04:00  3) Soo Energy Commission for Approval	CERTRICATE OF COMPLIANCE Project Hame: 19066.21 Redwey Transfer Station - Weigh Station  C. COMPLIANCE RESULTS  Results in this table are ounomatically calculated from data input and calculations to Table D. Exceptional Canditions for guidance or see applicable Table referenced  Calculations of Total Allowed Lighting Power (Watts) 140.7 / 170.2(e) 6  General Hardscape Allowance - Application 140.7(d)1 / 140.7(d)2 / 170.2(e) 6 170.2(e) 6 170.2(e) 10.2(e) 6 170.2(e) 10.2(e) 6 170.2(e) 10.2(e) 10.2(e) 6 170.2(e) 10.2(e) 10.	Date Frepared:	NRCC-LTC-E   (Preps 2 of 7)	CARTHEATE OF COMPLIANCE Project Name: 19056.21 Redway Transfer Station - Weigh Station  F. OUTDOOR LIGHTING FIXTURE SCHEDULE For new or attered highting systems demonstrating compliance with \$40.77 / \$ the spaces covered by the permit application are included in the Table below installed and replacement luminaires being installed as port of the project of Outdoor lighting attached to mailtformly buildings and controlled from the in lighting a included here.  Dasligned Whattage:  O1 02 03  Name or Item Tag  Complete Luminaire Description  Watts per uninaire1.2  C1 OUTDOOR WALL LED □ Linear 68  *MOTES: Selections with s * require a note in the space below explaining how complete Luminaire is lighting a station DXCFPRON 2 to 130.2(b)	Data Prepared:  170 2[e]5 oil new luminaires being installed and any existing Nr. For altered lighting systems using the Existing Power method cape are included [le, existing luminaires remaining or existing notice of a dwelling unit are included in Table H. and are not inc.    Q4	NRCC-LTO-t (Page 3 of 7) 2025-08-05718-38-30-00000  Naminaires remaining ar being moved within of per 141.0fb/21 cmly new huminaires being thaminaires being moved are not included). cluded here. All other multifamily outdoor  0.8 09 10  Curoff Req. > 6,200 initial Lumen output. 120.2(b) / 160.5(c)14  NA: Illuminate public NA: Illuminate
Certificate of Communication of Communication Compliance with regular mems in 110.1 nonresidential and hately material compliance with regular mems in 110.1 nonresidential and hately material station - Weigh Station Project Address:  A. GENERAL INFORMATION  11 Project Location (city) Redwey, CA  22 Climate Zone  2 Outdoor Lighting Zone per Title 24 Part 1 10.114 or as designated by Au  12 [2-5]: Low - Rural Areas  13 [2-5]: Very Low - Undeveloped Partial [2-5]: Moderate - Urban C  14 [2-5]: Low - Rural Areas  15 [2-5]: Low - Rural Areas  16 [2-5]: Low - Rural Areas  17 [2-5]: Low - Rural Areas  18 [2-7]: Project Location (city) Redwey, CA  19 [2-7]: Moderately High - U  10 [2-7]: Low - Rural Areas  10 [2-7]: Low - Rural Areas  11 [2-7]: Low - Rural Areas  12 [2-7]: Moderately High - U  13 [2-7]: Moderately High - U  14 [2-7]: Moderately High - U  15 [2-7]: Moderately High - U  17 [2-7]: Moderately High - U  18 [2-7]: Moderately High - U  19 [2-7]: Moderately High - U  19 [2-7]: Moderately High - U  19 [2-7]: Moderately High - U  20 [2-7]: Moderately High - U  21 [2-7]: Moderately High - U  22 [2-7]: Moderately High - U  23 [2-7]: Moderately High - U  24 [2-7]: Moderately High - U  25 [2-7]: Moderately High - U  26 [2-7]: Moderately High - U  27 [2-7]: Moderately High - U  28 [2-7]: Moderately High - U  29 [2-7]: Moderately High - U  20 [2-7]: Moderately High - U  20 [2-7]: Moderately High - U  20 [2-7]: Moderately High - U  21 [2-7]: Moderately High - U  22 [2-7]: Moderately High - U  23 [2-7]: Moderately High - U  24 [2-7]: Moderately High - U  25 [2-7]: Moderately High - U  26 [2-7]: Moderately High - U  27 [2-7]: Moderately High - U  28 [2-7]: Moderately High - U  29 [2-7]: Moderately High - U  20 [2-7]: Moderately High - U  20 [2-7]: Moderately High - U  20 [2-7]: Moderately High - U  21 [2-7]: Moderately High	pplance with requirements in 160.5, 170.2(e)e, 160.1(e) and includes dormitary and senior living facilities.    Repart Pages   Date Prepared:    Date Prepared:    O4   Total Illuminated Hardscape Area (ft <sup>3</sup> )   Uthority Having Jurisdiction (AHJ):   Clusters     12-4: High - Must be reviewed by CA E   Uthan Areas	INSCCLTO-E scapes using the prescriptive path for rel 180.2(b)489 for outdoor lighting scapes using  (Fage 1 of 7)  2025-98-05/18:38:51-04:00  3) Soo Energy Commission for Approval	CERTRICATE OF COMPLIANCE Project Name: 19086-21 Redwey Transfer Station - Weigh Station  C. COMPLIANCE RESULTS  Results in this tobbic are automatically calculated from data input and calculations to Table 2. Exceptional Conditions for guidance or see applicable Table referenced.  Calculations of Total Allowed Lighting Power (Watts) 140.7 (17.0.2(e) 6  O1	Date Frepared:	NRCC-LTC-E   (Preps 2 of 7)	CERTIFICATE OF COMPLIANCE Project Russes: 19086.21 Redway Transfer Station - Weigh Station  F. OUTDOOR LIGHTING FIXTURE SCHEDULE For new or altered lighting systems demonstrating compliance with 140.7 / 3 the spaces covered by the permit application are included in the Table below installed and replacement luminates being installed as port of the project so Outdoor lighting attacked to multiformly buildings and controlled from the in lighting is included here.  Designed Wattagas:  O1	Data Prepared:   170_2[e]6 oil new luminaires being installed and any existing har. For attered lighting systems using the Existing Power method cape are included [le, existing luminaires remaining or existing raide of a dwelling unit are included in Table H. and are not the   O4	NRCC-170-1 (Page 3 of 7) 2025-08-03718-38:51-04-000  uminioires remaining or being moved within of per 141,08)21 only new harmonies being humaniers being humaniers being noved are not includes), cluded here. All other mutifiganity outdoor    OS
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Outdoor Lighting  CERRIFICATE OF COMMUNIANCE This document is used to demonstrate compliance with requirements in 110, nonrestricted compositions, it is also used to document compliance with requirements in 110, nonrestricted compositions, it is also used to document compliance with prescriptive path for multiflomily and mised-use accorpancies. Multipliantly Project Nesses: 1908-31 Redway Tennifer Station - Weigh Station Project Address:  A. GENERAL INFORMATION  01   Project Location (dity)   Redway, CA   02   Câmata Zone   2   03   Outdoor Lighting Zone per Title 24 Pert 1 0.0.14 or as designated by Au	pilance with requirements in 160.5, 170.2(e)e, 160.1(a) and includes dormitary and senior living facilities.    Repart Pages   Deter Prepared:	I scopes using the prescriptive path for extended for the 180.2(b)489 for author lighting scopes using (Fege 1 of 7) 2025-08-05T18:38:51-04:00  Social Scopes (Scopes Scopes Scop	CERTIFICATE OF COMPLIANCE Project Hame: 19080-21 Rodwey Transfer Station - Weigh Station  C. COMPLIANCE RESULTS Results in this table are automatically calculated from data input and calculations to Table D. Exceptional Conditions for guidance or see applicable Table referenced.  Calculations of Total Allowed Lighting Power (Watts) 140.7 / 170.2 (e) 6 General Per Sales Ornamental Hardscape Application Frontage 140.7 (d) 2 170.2 (e) 6 (See Table I) (See Table II) (See Tabl	Date Frepared:	INCC-LTC-E (Page 2 of 7)  2023-06-05TL8:8:53-04:00  ble says "COMPLIES with Exceptional Conditions" refer  Compliance Results 7	CRITICATE OF COMPLIANCE Project Hames 19056.21 Redway Transfer Station - Weigh Station  F. OUTDOOR LIGHTING FIXTURE SCHEDULE For new or attered lighting systems demonstrating compliance with 140.7 / 3 the spaces covered by the permit application are included in the Table below installed and replacement luminaires being installed as part of the project so Cuttor lighting attached to multiformly buildings and controlled from the it lighting is included from the it lighting is footparted to multiformly buildings and controlled from the it lighting is included from the it lighting is footparted to multiformly buildings and controlled from the it lighting is footparted to multiformly buildings and controlled from the it lighting is footparted to multiformly buildings and controlled from the it lighting is footparted to multiformly buildings and controlled from the interest is lighting a statistic DICEPTION 2 to 130.2(b)  **MOTES: Selections with a " require a note in the space below explaining how camping the interest is lighting a statistic DICEPTION 2 to 130.2(b)  **MOTES: Selections with a " require a note in the space below explaining how camping the interest is lighting a statistic DICEPTION 2 to 130.2(b)  **POTINGTES: Almostrate within the project copys that care not belong abund and are run the project scope.  **Compliance with mandatory shelping requirements is required for fundaments with it	Data Prepared:   170_2[e]6 oil new luminaires being installed and any existing for it read of a design systems using the Existing Power method cope are included [le, existing luminaires remaining or existing reside of a dwelling unit are included in Table H. and are not the   0.4	NRCC-LTO-1 (Page 3 of 7) 2025-08-05718-38-30-04000  Uminaries remaining or being moved within of per 141.0(b)21 any new hamboxies being hamboxies being hamboxies being named are not included, cluded here. All other multifamily outdoor    OS
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Outdoor Lighting  CERRIFICATE OF COMMUNIANCE This document is used to demonstrate compliance with requirements in 110, nonrestricted compositions, it is also used to document compliance with requirements in 110, nonrestricted compositions, it is also used to document compliance with prescriptive path for multiflomily and mised-use accorpancies. Multipliantly Project Nesses: 1908-31 Redway Tennifer Station - Weigh Station Project Address:  A. GENERAL INFORMATION  01   Project Location (dity)   Redway, CA   02   Câmata Zone   2   03   Outdoor Lighting Zone per Title 24 Pert 1 0.0.14 or as designated by Au	pulsance with requirements to 160.5, 270.2(e)e, 160.1(a) and includes dormitory and senior living facilities.    Report Pages   Report Pages   Report Pages	Scapes using the prescriptive path for relations (supplementation for Approval  Scapes using the prescriptive path for (frage 1 of 7)  2025-98-95T18:38-51-04:00  Energy Commission for Approval  Significant for Approval  Yes No  OS  Calculation Method  Let Scape of the Permit Application; x 100.  Documentation Software: Energy Code Ace  Compliance ID: 282773-963-5-0008	CERTIFICATE OF COMPLIANCE Project Hame: 19080-21 Rodwey Transfer Station - Weigh Station  C. COMPLIANCE RESULTS Results in this table are automatically calculated from data input and calculations to Table D. Exceptional Conditions for guidance or see applicable Table referenced.  Calculations of Total Allowed Lighting Power (Watts) 140.7 / 170.2 (e) 6 General Per Sales Ornamental Hardscape Application Frontage 140.7 (d) 2 170.2 (e) 6 (See Table I) (See Table II) (See Tabl	Date Frepared:	INCC-LTC-E (Pregs 2 of 7) 2023-06-05TL8:8:53-04:00  bite says "COMPLIES with Exceptional Conditions" refer  Compliance Results 7	CRITICATE OF COMPLIANCE Project Hames 19056.21 Redway Transfer Station - Weigh Station  F. OUTDOOR LIGHTING FIXTURE SCHEDULE For new or attered lighting systems demonstrating compliance with 140.7 / 3 the spaces covered by the permit application are included in the Table below installed and replacement luminaires being installed as part of the project so Cuttor lighting attached to multiformly buildings and controlled from the it lighting is included from the it lighting is footparted to multiformly buildings and controlled from the it lighting is included from the it lighting is footparted to multiformly buildings and controlled from the it lighting is footparted to multiformly buildings and controlled from the it lighting is footparted to multiformly buildings and controlled from the it lighting is footparted to multiformly buildings and controlled from the interest is lighting a statistic DICEPTION 2 to 130.2(b)  **MOTES: Selections with a " require a note in the space below explaining how camping the interest is lighting a statistic DICEPTION 2 to 130.2(b)  **MOTES: Selections with a " require a note in the space below explaining how camping the interest is lighting a statistic DICEPTION 2 to 130.2(b)  **POTINGTES: Almostrate within the project copys that care not belong abund and are run the project scope.  **Compliance with mandatory shelping requirements is required for fundaments with it	Data Prepared:   170_2[e]6 oil new luminaires being installed and any existing for it read of a design systems using the Existing Power method cope are included [le, existing luminaires remaining or existing reside of a dwelling unit are included in Table H. and are not the   0.4	NRCC4TO-1 (Page 3 of 7) 2025-06-05718:38:31-04-000  Naminalizes remaining at being moved within of per 141.0(b)21 anly new luminoires being huminaires being moved are not included; studed here. All other multifamily outdoor  08
Centricate Co-Communication of Communication	pilance with requirements in 160.5, 270.2(e)e, 160.1(a) and includes dormitary and senior living facilities.    Repart Pages   Dete Prepared:	I scopes using the prescriptive path for extraction (ighting scopes using the prescriptive path for [Fege 1 of 7] 2025-06-05T18:38:31-04:00 2025-06-05T18:38:38:38:38:38:38:38:38:38:38:38:38:38	CERTRICATE OF COMPLIANCE Project Name: 19086-21 Redwey Transfer Station - Weigh Station  C. COMPLIANCE RESULTS  Results in this table are outcomatically calculated from data input and calculations to Table 2. Exceptional Conditions for guidence or see applicable Table referenced:  Calculations of Total Allowed Lighting Power (Watts) 140.7 (17.0.2 (e) 6  O1	Date Frepared:	INCC-LTC-E (Page 2 of 7)  2025-06-05TL8:8:53-04:00  Does says "COMPLIES with Exceptional Conditions" refer  Compliance Results  7	CRITICATE OF COMPLIANCE Project Russes 19086.21 Redway Transfer Station - Weigh Station  F. OUTDOOR LIGHTING FIXTURE SCHEDULE For new or altered highting systems demonstrating compliance with 140.7 / 3 the spaces covered by the permit application are included in the Table below installed and replacement luminaires being installed as port of the project so Outdoor lighting attacked to multiformly buildings and controlled from the in lighting is included here.  Designed Waittages:  O1	Data Prepared:   170_2[e]6 oil new luminaires being installed and any existing for it. For attered lighting systems using the Existing Power method cape are included [le, existing luminaires remaining or existing reside of a dwelling unit are included in Table H. and are not the continuous and the continuous continu	NRCC-LTO-1 (Page 3 of 7) 2025-08-05718-38-30-04000  Luminairee remaining or being moved within of per 141.0(b)21 any new hamboxies being hamboxies being named are not included, scluded kere. All other multifamily outdoor  08





PROJECT #: 19086.21

BAR IS ONE INCH ON ORIGINAL DRAWING 100 Howe Ave., Suite 235N Sacramento, CA 95825-8217 www.mneilsengineering.com Tel: (916) 923-4400 Fax: (916) 923-4410 IF NOT ONE INCH ON THIS SHEET, ADJUST SCALES ACCORDINGL

				-
	ROAD NAME: CONSERVATION CAMP RD		M.NEILS ENGINEERING	
ON G	ROAD NO:	MILE POST:		
_	PROJECT NO.: 438005	EA NO.:	DESIGNED BY: SKL	
	CONTRACT NO.:	BRIDGE NO:	DRAWN BY: PI	_
on St	DRAWING FILE NAME:		REVIEWED BY: SKL/JLB	
LY	PLOT DATE: 6/17/25	REVISION DATE:	APPROVED BY: JLB	
				_

### REDWAY TRANSFER STATION TITLE 24 WEIGH STATION -**OUTDOOR LIGHTING**

COUNTY OF HUMBOLDT

DEPARTMENT OF PUBLIC WORKS

58

E5.3

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STATE OF CALIFORNIA  Outdoor Lighting				CALIFORNIA I	ENERGY COMMISSION	STATE OF CALIFORNIA Outdoor Lighting	CALIFORNIA ENERGY COMMISSION
CERTIFICATE OF COMPLIANCE					NRCC-LTQ-E	CERTIFICATE OF COMPLIANCE	NRCC-LTO-E
Project Name: 19086.21 Red	Iway Transfer Station - Weigh Station		te port Pega:	500	(Page 4 of 7)	Project Name: 19066.21 Redway Transfer Station - Weigh Station Report Page:  Data Prepared:	(Page 5 of 7)
		J	Debs Propered:	202	(5-06-05T18:38:51-04:00	Data Psepared:	2025-06-05718:38:51-04:00
H. OUTDOOR LIGHTING CO						I. LIGHTING POWER ALLOWANCE (per 140.7 / 170.2(e))	
			res installed as part of the permit application. For nly) do not need to be included in this table even ij			This table includes areas using allowance calculations per 140.7 / 170.2(e), General Hordscope Allowance is per Table 140.7-A/Table 170.2-R while "Use it or loss it"	01
the permit application.						Allowances are per Table 140.7-8 /Table 170.2-S. Indicate which allowances are being	"Use it or lose it" Allowance (select all that apply) (select all that apply)
	iential buildings, parking garages and strailed from the inside of a dwelling		ruitifornily buildings must be documented separat	ely from autdaar lig.	hting attached to	used to expand sections for user input. Luminoires that qualify for one of the "lise it or lase it" allowances shall not qualify for another "lise it or lase it" allowance.	Per Per Perspecific
	residentisi Occupancies, Parking Gar		Multifamily Buildings			Outdoor lighting attached to multifamily buildings and controlled from the inside of a Allowance	Application Table 7 Table 1 Area
01	02	03	04		05	dwelling unit are included in Table H. and are not included here. All other multifamily authors included here.	Table J Table M
	Shirk Off	A de Cabadada	Marking Consess	Field	d Inspector	Calculated General Hardscape Lighting Power Allowance per Table 140.7-A for Nonresidential & Hotel/Motel	
Area Description	Shut-Off 130.2(c)1 / 150.5(c)	Auto-Schedule 130.2(c)2 / 160.5(c)	Motion Sensor 130.2(c)3 / 160.5(c)			02 03 04 05	06 07 08 09
				Pass	Fail	Area Wattage Allowance (AWA)	Linear Wattage Allowance (LWA) Total General
Front Entrance and Parking Lot: "C1"	Photocontrol	Provided	NA: Industrial Sites Lighting			Area Description Illuminated Area Allowed Density Area Allowance	Perimeter Length Allowed Density Linear Allowance AWA + LWA (W/lf) (Watts) (Watts)
	viated, please refer to Table 160.5-A to c	onfirm compliance with the sp	ecific light source technologies listed.			(ft <sup>2</sup> ) (W/ft <sup>2</sup> ) (Watts)   Front Entrance and Parking Lot 500 0.019 9.5	(lf) (W/lf) (Watts) (Watts) 90 0.15 19.5 29
	y ask for cutskeets ar other documentati					Front Entrance and Parking Lot 500 0.019 9.5	Initial Wattage Allowance for Entire Sits (Watts): 200
-wecessa tumnares martea for	use in pre-rated materianans, one recass	eo summares essañeo is non-i	nzulated cellings are excepted from it and lit.				Instances of initial Wattage Allowance (LZ 0 only) <sup>2</sup>
							Total General Hardscape Allowanes (Watts): 223
						J. LIGHTING ALLOWANCE: PER APPLICATION	
						This section does not apply to this project.	
						K. LIGHTING ALLOWANCE: SALES FRONTAGE	
						This section does not apply to this project.	
						L. LIGHTING ALLOWANCE: ORNAMENTAL	
						This section does not apply to this project.	
		Generate	d Date/Time:	Documentation Soft	tware: Energy Code Ace	Generated Date/Time:	Documentation Software: Energy Code Ace
CA Building Energy Efficiency St	tandarda - 2022 Nonresidential Complian	ce Report Ve	rs'on: 2022.0.000 ersion: rev 20220101	Compliance	: ID: 282723-0625-0006 d: 2025-06-05 15:38:54	CA Building Energy Efficiency Standards - 2022 Nonresidential Compilance Report Version: 2022.9.000 Schema Version: ray 2022010	Compliance D: 282723-0625-0008 11 Report Generated: 2025-06-03 15:38:54
		SUPERIE V	erstern rew zoazototi	Negor L Gerrar Boak	u.202900-03 15.58.54	SUBINA VERZIALLI DV ZIZZAZA	1 respect desiration acceptance 12.52.54
STATE OF CALIFORNIA							
Outdoor Lighting				CALIFORNIA I	ENERGY COMMISSION	0	
CERTIFICATE OF COMPLIANCE	lway Transfer Station - Weigh Station	- I	Secret Descri		NRCC-LTO-E	Outdoor Lighting Mandatory Measures:	
Project Address:	way tarasa zaston - weign scaubii		tepart Pege: Date Prepared:	202	(Page 7 of 7) 5-06-05T18:38:51-04:00	11.0.9 OUTDOOR LIGHTING CONTROLS AND COMPONENTS ALL LIGHTING CONTROL DEVICES AND SYSTEMS, AND ALL LIGHT SOURCES SHALL MEET THE APPLICA	DI E BEOLIDEMENTS OF 110 O
		,				130.0 GENERAL LUMINAIRE REQUIREMENTS	ZEE REQUIREMENTS OF 120.5.
						ALL LUMINAIRES SHALL BE FACTORY-LABELLED PER 130.0(c).	
	R'S DECLARATION STATEMENT					ENERGY MANAGEMENT CONTROL SYSTEMS (EMCS) SHALL MEET REQUIREMENTS OF 130.0(e).	
Documentation Author Name:	te of Compliance documentation	is accurate and complet	B. Focumentation Author Signature: // (/)_			130.2(c) CONTROLS FOR OUTDOOR LIGHTING ALL OUTDOOR LIGHTING SHALL BE INDEPENDENTLY CONTROLLED FROM OTHER ELECTRICAL LOADS A	AND SHALL HAVE THE EAST MARIANS SEATINGS.
Julia L. Brodovsky			ht.			AUTOMATICALLY TURNS OFF OUTDOOR LIGHTING WHEN DAYLIGHT IS AVAILABLE	das single fine i file i occoverad i per ones.
Company: M. Nells Engineering			O6/17/2025			2. AUTOMATIC SCHEDULING CONTROLS	
Address: 100 HOWE AVE, S	SUITE 235N		EA/ HERS Certification Identification (If applicable):			A. AUTOMATIC SCHEDULING CONTROLS SHALL BE INSTALLED FOR ALL OUTDOOR LIGHTING.	
City/State/Zip: SACRAMENTO	D, CA 95825	j	Nume: (916) 923-4400			<ul> <li>B. CAPABLE OF REDUCING LIGHTING POWER AT LEAST 50% AND NO MORE THAN 90% AND SEPAL UNOCCUPIED PERIODS</li> </ul>	ATELY CAPABLE OF TURNING LIGHTING OFF DURING
RESPONSIBLE PERSON'S DE	ECLARATION STATEMENT of perjuly, under the laws of the State of Calif	homia-				C. THAT ALLOW SCHEDULING OF AT LEAST TWO NIGHTTIME PERIODS WITH INDEPENDENT LIGHT	ING LEVELS (MAY INCLUDE OVERRIDE FOR NO MORE THAN 2
The information provides	d on this Certificate of Compliance is true and	DOMES.				HOURS)	
<ol><li>The energy features and</li></ol>	performance specifications, materials, compo		ng derign or system design identified on this Certificate of Con for the building design or system design identified on this Cert				
	er: 6 of the California Code of Regulations. ures or system design features identified on th	nis Cardificate of Compliance are o	insistent with the information provides on other applicable co	maliance decuments, wo	originests, calculations.		
plans and specifications of	submitted to the enforcement agency for app	rowal with this building permit app					
Inspections. I understand	d that a completed signed copy of this Certific	ate of Compilance is required to b	s lackuded with the documentation the builder provides to the	beliding owner at occup	eack.		
Responsible Designer Name: Julia L. Brodovsky			Responsible Designer Signature:				
Company:			Detar Signaed: 06/17/2025				
M. Nells Engineering Address: 100 HOWE AVE, S	NUTE 225N		Jonne: E24535				
City/State/Zip: SACRAMENTO			Mone: (916) 923-4400				
			·	· · · · ·			
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			d Date/Time:		twars: Energy Code Ace		
CA Building Energy Efficiency St	tandarda - 2022 Norresidential Compilan	ce Report Va Scheme V	rsion: 2022.0.000 ersion: rey 20220101		d: 2025-06-05 15:38:54		

Outdoor Lighting CERTIFICATE OF COMPLIANCE NRCC-LTO-E Project Barnek 15086.21 Radway Transfer Station - Weigh Station Report Page: Data Prepared:

M. LIGHTING ALLOWANCE: PER SPECIFIC AREA This section does not apply to this project.

N. EXISTING CONDITIONS POWER ALLOWANCE (alterations only) This section does not apply to this project.

O. DECLARATION OF REQUIRED CERTIFICATES OF INSTALLATION Stlections have been made based on information provided in this document if any selection has been changed by permit applicant, an explanation should be included in Table E. Additional Remarks. These documents must be provided to the building inspector during construction and can be found online NRCI-LTO-E - Must be submitted for all buildings

P. DECLARATION OF REQUIRED CERTIFICATES OF ACCEPTANCE Selections have been made based on information provided in this document. If any selection has been changed by permit applicant, on explanation should be included in Table E. Additional Remarks. These documents must be provided to the building inspector during construction and must be completed through an Acceptance Test Technician Certification Provider (ATTCP). For more information visit: http://www.energy.co.gov/title24/sttcp/providers.html Systems/Spaces To Be Field Verified NRCA-LTO-02-A - Must be submitted for all outdoor lighting controls except for alterations where controls are added to <= 20 luminaires. Front Entrance and Parking Lot: "C1"

Report Version: 2022.0.000 Scheme Version: rev 20220101 Compliance ID: 282723-0625-0008 Report Generated: 2025-06-05 13:38:54 CA Building Energy Efficiency Standards - 2022 Nonresidential Compliance

ROFESSIONAL BROOM



IF NOT ONE INCH ON THIS SHEET, ADJUST SCALES ACCORDINGLY

	ROAD NAME: CONSERVATION CAMP RD	M.NEILS ENGINEERING		
N	ROAD NO:	MILE POST:	M.NEIES ENGINEERING	
	PROJECT NO.: 438005	EA NO.:	DESIGNED BY: SKL	- 
N T	CONTRACT NO.:	BRIDGE NO:	DRAWN BY: PI	٢
	DRAWING FILE NAME:		REVIEWED BY: SKL/JLB	
_Y	PLOT DATE: 6/17/25	REVISION DATE:	APPROVED BY: JLB	

COUNTY OF HUMBOLDT
DEPARTMENT OF PUBLIC WORKS
REDWAY TRANSFER STATION
TITLE 24 RECYCLE BUILDING INDOOR LIGHTING

E5.4

SHEET 56 OF 58

SWEGS CALFORNA Indoor Lighting	CALIFORNIA ENERG			CALIFORNIA ENERGY COMMISSION	STATE OF CALFORNIA Induar Lighting		CALIFORNIA ENERGY COMMISSION
CERTIFICATE OF COMPLIANCE		NRCC-LTI-E CERTIFICATE OF COMPLIANCE	15	NRCC-LTI-E	CERTIFICATE OF COMPLIANCE		NRCC-LTI-E
	9, 210.12(c), 130.0, 130.1, 140.6 and 142.0(b)2 for indear lighting scapes using the prescript. pliance with requirements in 160.5, 270.2(e) and 180.2(b)4 for indear lighting scapes using t		Report Fage: Caps Fagered:	(Page 2 of 7) 2023-06-05T18:14:05-04:00	Project Name: 19086.21 Redway Transfer Station - Recycle Building	Report Page: Date Pressared:	(Page 3 of 7) 2025-06-05T18:14:05-04:00
path for multifamily accupancies. Multifamily includes darmitary and seniar				2010 00 00 120 140 0400		and a separate	2002 00 00/12012-900/0-9900
Project Name: 19096.21 Redway Transfer Station - Recycle Building	Report Page:	(Page 1 of 7)					
Project Address:	Date Prepared: 2025-06-0	18:14:03-04:00  C. COMPLIANCE RESULTS			F. INDOOR LIGHTING FIXTURE SCHEDULE		
		if any cell on this table says "DOES NOT COMPLY" or "COMPLIES with Exce	antineni ferrittene" refer in Trible (1. for mulrianna		This table includes all planned permanent and partable lighting other than		
A. GENERAL INFORMATION			Adjusted Lighting Power per 14	IO.6(a) / 170.2(e)	documented in Table T. if using Table T to document lighting in multifamily not included here.	common use areas provining snarea provisions for aving,	, eating, cooking or sanitation, those luminaires are
01 Project Location (city) Redway, CA	04 Total Conditioned Floor Area (ft²)	Allowed Lighting Power per 140.6(b) / 17	(Watts)	Compliance Results	Designed Wattage: Unconditioned Spaces		
02 Climate Zone 2	05 Total Unconditioned Floor Area (ft²) 2,400	Lighting in 01 02 03 04 conditioned and	05 06 07	08 09	01 02 03 04	05 06 07	08 09 10
03 Occupancy Types Within Project (select all that apply):	06 # of Stories (Habitable Above Grade)	unconditioned Area	Adjustments		Name or Item Complete Luminaire Modular		uded per Field Inspector
• Warehouse		spaces must not be Complete Area Category Tailon compliced for Building Category Additional 140.6(c	c)3 / Total Control Control Control	Total Adjusted	Tag Description (Track) Fixture Color Change	luminaire <sup>2</sup> determined of Luminaires 140	0.6(a)3 / Design Watts Pass Fall
		compliance per 140.6(c)1 140.6(c)2 / 140.6(c)2G / 170.2(e	e)4B Allowed (Watts) 140.6(a)2 /	*Indudes 05 must be >= 08 *Indudes 140.6 / 170.2(e)	A1 4FT WET LOCATION LED No NA		No 581.52
B. PROJECT SCOPE		140.6(b)1 / 170.2(e) 170.2(e)4 170.2(e)4Av (+)	) (Watts) (170.2'e)1B	Adjustments		Total Designed Watts: UNCONDITION	
	nit application and are demanstrating compliance using the prescriptive poth outlined in 140	/ 170.2(e) or (See Table I) (See Table I) (See Table I) (See Table I)			<sup>2</sup> FOOTNOTE: Design Watts for small aperture and color changing luminaire		o he 75% /80% of their rated wattage. Table F
141.0(b)2 / 180.2(b)4 for alterations.	Conditioned Conse	Conditioned	= 2 =		automatically makes this adjustment, the permit applicant should enter ful		
Scope of Work	Conditioned Spaces	OS Unconditioned 1,440	= 1,440 ≥ 581.52 =	- 581.52 COMPLIES	<sup>2</sup> Authority Having Jurisdiction may ask for Luminaire cut sheets to confirm luminaire, not the lamp.	waxuqe usea jar compliance per 130.0(c) / 180.5(b). Wat	nunge used must be the maximum rated for the
My Project Consists of (check all that apply):		Area (ft²i	Controls Compliance (See	e Table H for Details) COMPLIES			
New Lighting System	N/A D Complete Building Method	2400	Rated Power Reduction Compliance (See	e Table Q for Details)	G. MODULAR LIGHTING SYSTEMS		
New Lighting System - Parking Garage	N/A D N/A	0					
Total Area of Work (ft²)	2400	D. EXCEPTIONAL CONDITIONS			This section does not apply to this project.		
	•	This table is auto-filled with uneditable comments because of selections n	nade or data entered in tables throughout the form.		II INDOOR HOUTING CONTROLS (NEAT 1 1 1 2 2 2 2 2		
					H. INDOOR LIGHTING CONTROLS (Not including PAFs)		
		E. ADDITIONAL REMARKS			This take includes lighting controls for conditioned and unconditioned spar	688.	
		This table includes remarks made by the permit applicant to the Authority	y Having Surisdiction.		Building Level Controls 01	C2	03
		· · · · · · · · · · · · · · · · · · ·	-				Field Inspector
					Mandatory Demand Response 110.12(c)	Shut-off controls 130.1(c) / 160	0.5(b)4C Pass Fail
					NA < 4,000W subject to multilevel	See Ares/Space Level Cont	trals 🗆 🗆
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Project Name: 19056.21 Redway Transfer Station - Recycle Building	CALIFORNIA ENERG		Report Pages	CALIFORNIA ENERGY COMMISSION NRCC-171-6 (Page 5 of 7)		Report Page:	
	Report Page:	COMMISSION Indoor Lighting NRCC-LTI-E CERTIFICATE OF COMPLIANCE	Report Page: Date Propered:	NRCC-LTI-E	Indoor Lighting CERTIFICATE OF COMPLIANCE	Report Page: Date Prapared:	CALIFORNIA ENERGY COMMISSION NRCC-171-8
	Report Page:	COMMISSION Indoor Lighting  NRCC-LTI-E CRETIFICATE OF COMPLIANCE  (Page 4 of 7) Project Name: 19088-21 Redwey Transfer Station - Recycle Building		MRCC-LTI-E (Page 9 of 7)	Indoor Lighting CERTIFICATE OF COMPLIANCE		CALIFORNIA ENERGY COMMISSION NRCC-LTI-e (Page 6 of 7)
Project Name: 19089.21 Redwey Transfer Statton - Recycle Building	Report Page:	COMMISSION Indoor Lighting  NRCC-LTI-E CRETIFICATE OF COMPLIANCE  (Page 4 of 7) Project Name: 19088-21 Redwey Transfer Station - Recycle Building		MRCC-LTI-E (Page 9 of 7)	Indoor Lighting CERTIFICATE OF COMPLIANCE		CALIFORNIA ENERGY COMMISSION NRCC-LTI-e (Page 6 of 7)
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ON ST	ROAD NO:	MILE POST:		
	PROJECT NO.: 438005	EA NO.:	DESIGNED BY: SKL	
	CONTRACT NO.:	BRIDGE NO:	DRAWN BY: PI	-
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	PLOT DATE: 6/17/25	REVISION DATE:	APPROVED BY: JLB	
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REDWAY TRANSFER STATION

TITLE 24 RECYCLE BUILDING INDOOR & OUTDOOR LIGHTING

COUNTY OF HUMBOLDT DEPARTMENT OF PUBLIC WORKS

STATE OF CALIFORNIA Indoor Lighting		CALIFORNIA ENERGY COMMISSION						
CERTIFICATE OF COMPLIANCE	[5 · · · ·	NRCC-LTI-E	Indoor Lighting Mandatory Measures:			Indoor Lighting Mandatory Measures:		
Project Name: 19086.21 Redwey Transfer Station - Recycle Building Project Address:	Report Page: Date Prepared:	(Page 7 of 7) 2025-06-05T18:14:05-04:00	110.9 LIGHTING CONTROLS AND COMPONENTS ALL LIGHTING CONTROL DEVICES AND SYSTEMS, AND ALL LIGHT SOUR	ICES SHALL MEET THE APPLICABLE RECULIR	MENTS OF 110 9	130.1(f) CONTROL INTERACTIONS  EACH LIGHTING CONTROL INSTALLED TO MEET 130.1 REQUIREMEN	IT'S SHALL INCORPORATE THE FUNCTIONS OF OTH	HER LIGHTING CONTROLS REQUIRED BY THIS
	•		NOTE: THE EXCEPTED SPACES DO NOT COUNT TOWARDS THE 10,000 F			SECTION.		
DOCUMENTATION AUTHOR'S DECLARATION STATEMENT		1	130.0 GENERAL LUMINAIRE REQUIREMENTS ALL LUMINAIRES SHALL BE FACTORY-LABELLED PER 150.0(c).			1. FOR GENERAL LIGHTING, MANUAL AREA CONTROL SHALL PERMI	T THE LEVEL OF LIGHT PROVIDED WHILE LIGHTIN	NG IS ON TO BE SET OR ADJUSTED BY CONTROLS
I certify that this Certificate of Compliance documentation is accurat	te and complete.		ENERGY MANAGEMENT CONTROL SYSTEMS (EMCS) SHALL MEET REQ.	UIREMENTS OF 130.0(e).		SPECIFIED IN 130.1(b), (c), (d) and (e).		
Documentation Author Name:	Documentation Author Signature:		130.1(a) MANUAL AREA CONTROLS			2. MANUAL AREA CONTROL SHALL PERMIT SHUTOFF CONTROL TO		
Julia L. Brodovsky Company:	Signature Date:		EACH ROOM OR AREA WITH FLOOR-TO-CEILING WALLS IN THIS BUILD AND OFF MANUAL CONTROLS SHALL:	ING SHALL HAVE LIGHTING CONTROLS THA	ALLOW LIGHTING TO BE MANUALLY TURNED ON	3. MULTILEVEL CONTROL SHALL PERMIT THE AUTOMATIC DAYLIGH		
M. Neils Engineering Address: 100 HOWE AVE SUITE 235N	06/17/2025 CEA/ HERS Certification Identification (if applicable)	:	1. BE READILY ACCESSIBLE			4. MULTILEVEL CONTROL SHALL PERMIT THE DEMAND RESPONSIVE THE CONTROL AFTER THE EVENT.	(DR) CONTROL TO ADJUST LIGHTING DURING A	DR EVENT THEN RETURN IT TO THE LEVEL SET BY
Ethy/Status/Zips: SACRAMENTO, CA 95825	Phone: (916) 923-4400		2. BE LOCATED IN THE SAME ENCLOSED AREA WITH THE LIGHTING IT			5 SHUTOFF CONTROL SHALL PERMIT THE MANUAL AREA CONTROL	TO THEN THE HIGHTING ON	
RESPONSIBLE PERSON'S DECLARATION STATEMENT I cartify the following under passity of perjury, under the base of the State of California:			3. PROVIDE SEPARATE CONTROL OF GENERAL, FLOOR, WALL, WINDON ON AND OFF SEPARATELY WITHOUT AFFECTING OTHER LIGHTING OR I		L EFFECTS LIGHTING SO EACH TYPE CAN BE TURNED	6. AUTOMATIC DAYLIGHTING CONTROL SHALL PERMIT MULTILEVEL		EVEL
<ol> <li>The Information provided as this Certificate of Complained in trus and context.</li> <li>In an eligible under Driving of the Burlines or Provides on the October Concept region.</li> <li>The surray features and performance excitations, materials, components, and mortified April 1 and 5 of the Certificate Code of Regulation Code of the Section.</li> <li>The building being in features or system design features benefited on this Certificate pain and appeal design the submitted on the Certificate pain.</li> </ol>	manufactured devices for the building design or system design identified of ori Compilance are consistent; with the information provided on other ap is building parmit application.	on this Certificate of Compliance conform to the requirements optionals compliance documents, worksheets, calculations,	130.1(b) MULTILEVEL LIGHTING CONTROLS GENERAL LIGHTING IN ALL ROOMS AND AREAS 100 FT2 OR GREATER I CONTROLS THAT ALLOW LIGHT LEVELS TO BE ADJUSTED UP AND DOW LEVELS PER TABLE 130.1-A.	AND WITH MORE THAN 0.5 WATTS PER FT2		7. FOR LIGHTING CONTROLLED BY MULTILEVEL LIGHTING CONTROL SHALL PROVIDE A PARTIAL-ON FUNCTION THAT IS CAPABLE OF AUT 8. RESERVED	S AND OCCUPANT SENSING CONTROLS THAT PRO	OVIDE AUTOMATIC-ON FUNCTION, CONTROLS
<ol> <li>I will ensure that a completed signed copy of this Certificate of Compliance shall be inspections. I understand that a completed signed copy of this Certificate of Compliance.</li> </ol>	e made available with the building permit(s) issued for the building, and n liance is required to be included with the documentation the builder prov	made available to the enforcement agency for all applicable vides to the building owner at occupancy.	130.1(c): SHUTOFF CONTROLS  ALL INSTALLED INDOOR LIGHTING SHALL BE EQUIPPED WITH CONTRO	ISTO AUTOMATICALLY REDUCE LIGHTING I	OWER WHEN SPACE IS TYPICALLY UNDOCUPIED.	9. FOR SPACE CONDITIONING SYSTEM ZONES SERVING ONLY SPACE	S THAT ARE REQUIRED TO HAVE OCCUPANT SENS	SING CONTROLS SHALL BE CONTROLLED BY
Responsifike Designer Name: Julia L. Brodovsky	Responsible Designer Signature:		130.1(c)1: CONTROL REQUIREMENTS	ES TO NOTONE INC. LES TES COL ENTINO	OTTER THE TOTAL IS THE TOTAL OF THE STATE OF	OCCUPANCY SENSING CONTROLS.		
Company:	Date Signed: 06/17/2025		ALL INSTALLED INDOOR LIGHTING SHALL HAVE ALL OF THE FOLLOWIN  A. CONTROL(S) CAPABLE OF AUTOMATICALLY SHUTTING OFF ALL LIGH		CLIDIED (OCCUDANT SENSING CONTROL ALTORASTIC			
M. Neils Engineering Asidresz: 100 HOWE AVE, SUITE 235N	Ucense: E24535		TIME-SWITCH CONTROL, OR OTHER)		ENTITE (OCCUPANT SENSING CONTINUE) ANTONIA IIC			
Elty/Stata/Zip: SACRAMENTO, CA 95825	Phone: (916) 923-4400		B. SEPARATE CONTROLS FOR LIGHTING ON EACH FLOOR (OTHER THAN	· · · · · · · · · · · · · · · · · · ·				
			C. SEPARATE CONTROLS FOR A SPACE ENCLOSED BY CEILING HEIGHT  130.1(c)3,4 OVERRIDE FOR BUILDING LIGHTING SHUT-OFF	PARTITIONS NOT EXCEEDING 5,000 FTZ				
			AREAS SERVED BY SHUT-OFF CONTROLS (OTHER THAN OCCUPANT SET 130.1(c)3. INCLUDE MANUAL OVERRIDE CONTROL THAT COMPLIES W 130.1(c)4. PROVIDE AUTOMATIC HOLIDAY "SHUTOFF".		MAIN ON FOR UP TO 2 HOURS; AND			
			190.1(c)s Partial or full-off occupant sensors, in addition to  a juse ways and open areas in warehouses  Library Book Stack Ausles  Companyor Ausles	SHUTOFF CONTROLS PER 130.1(c)1 AND 1	90.1(c)2, IN THE FOLLOWING SPACES:			
			CORRIDORS AND STAIRWELLS     OFFICES GREATER THAN 250 SQ, FT.					
	Generated Date/Time:	Documentation Software: Energy Code Ace						
CA Building Energy Efficiency Standards - 2022 Nonresidential Compliance	Report Version: 2022.0.000	Compilanca ID: 281838-0625-0006						
	Scheme Version: rev 20220101	Report Generated: 2025-06-05 15:14:09						
STATE OF CALIFORNIA Outdoor Lighting		CALIFORNIA ENERGY COMMISSION	STATE OF CAUPOISMA Outdoor Lighting		CALIFORNIA ENERGY COMMISSION	STATE OF CALIFORNIA Outdoor Lighting		CALIFORNIA ENERGY COMMISSION
CERTIFICATE OF COMPLIANCE		NRCC-LTO-E	CERTIFICATE OF COMPLIANCE		NRCC-LTG-B	CERTIFICATE OF COMPLIANCE		NRCC-LTO-E
This document is used to demonstrate compliance with requirements in 110. nonresidential and hatel/matel accupancies. It is also used to document com			Project Name: 19066.21 Reckway Transfer Station - Recycle Building	Report Page: Data Propered:	(Page 2 of 8) 2023-06-05T18:15:33-04:00	Project Name: 19086.21 Redway Transfer Station - Recycle Building	Report Page: Date Presered:	(Page 3 of 8) 2025-06-03T18:15:83-04:00
the prescriptive path for multifamily and mixed-use accupancies. Multifamily  Project Name: 19085.21 Redway Transfer Station - Recycle Building	y includes dormitory and senior living facilities.  Resort Page:	(Page 1 of 5)		· ·			· ·	
Project Address:	Data Prepared:	2025-06-05T18:15:33-04:00				F. OUTDOOR LIGHTING FIXTURE SCHEDULE		
	·		C. COMPLIANCE RESULTS			For new or altered lighting systems demonstrating compliance with 140.7	/ 170.2(e)8 all new iuminaires being installed and any	existing luminaires remaining ar being moved within
A. GENERAL INFORMATION			Results in this table are automatically calculated from data input and calculated to Table D. Exceptional Conditions for guidance or see applicable Table refere		his table says "COMPLIES with Exceptional Conditions" refer	the spaces covered by the permit application are included in the Table beli installed and replacement luminaires being installed as part of the project	w. For altered lighting systems using the Existing Pow	ver method per 141.0(b)2L only new luminaires being
01 Project Location (city) Redway, CA	04 Total Illuminated Hardscape Area (ft	<sup>2</sup> ) 5400	Calculations of Total Allowed Lighting Power (Watts) 140.7 / 170.2		Compliance Results	Outdoor lighting attached to multiformly buildings and controlled from the		
02 Climate Zone 2. 03 Outdoor Lighting Zone per Title 24 Part 1 10.114 or as designated by Ar	uthority Heving Jurisdiction (AHJ):		01 02 03 04	05 06	07 08 09	lighting is included here.  Dasigned Wattage:		
☐ LZ-0: Very Low - Undeveloped Parkland ☐ LZ-2: Moderate - Urban 6		k Energy Commission for Approval	General Per Sales Ornamental	Per Specific Existing Power		C1 02 03	04 05 06	07 08 09 10
LZ-1: Low - Rural Areas LZ-3: Moderately High - U	Urban Arees		Allowance - Application   Frontage   140.7(d)2 / 140.7(d)2 / 170.2(e)6	Area 140.7(d)2 / OR Allowance = Ti	rtal Allowed   >   Total Actual   07 must be >= 08			Cutoff Req. > Field
05 Cccupancy Types within Project			17C.2(e)6 (See Table I) (See Table K) (See Table L)	(See Table M) 180.2(b)48v	(watts)	Name or Item Complete Luminaire Description Watts per	. Wattage lotal Number Luminaire 1	cluded per 6,200 initial Inspector 40.7(a) / Design Watts lumen output
Warehouse			(See lable I)	(See Table N)	\$77.6 ≥ 270 COMPLIES	Tag uminaire <sup>1.</sup>	determined Luminaires 2 Status 3 17	70.2(e)6A 130.2(b) / Pass Fail
			Shielding Compliance (5		N/A			NA: Exception
B. PROJECT SCOPE  This table bedudes autology lighting systems that are within the scope of the	normit avallantian and are domentization countinues with	ng the prescriptive path outlined in 140.7/	Controls Compliance (S		COMPLIES	C2 OUTDOOR WALL LED Linear 90	Mfr. Spac 3 New	270 In Section
170.2(e)5 or 141.9(b)2L / 180.2(b)48v for alterations.	because additional contract on a restrict on the contract of t	ing the prescriptore parts outlined to 240.7					Total Des	sign Watts: 270
My Project Canalists of:	02		D. EXCEPTIONAL CONDITIONS			NOTES: Selections with a " require a note in the space below explaining how cose: EX: Lumbaire is lighting a status; EXCEPTION 2 to 130.2(b)	npilance is achieved.	
01  New Lighting System Must Comply v	02 with Allowances from 140.7 / 170.2(e)8		This table is auto-filled with uneditable comments because of selections made	s or data entered in tables throughout the form		*FOOTNOTES: Authority Having Jurisdiction may ask for Luminaire cut skeets to co	girm wattage used far compliance per 130.0(c) / 160.5(b)	
☐ Altered Lighting System is your alterati	ion increasing the connected lighting load (Watts)?	Yes No	E. ADDITIONAL REMARKS			<sup>2</sup> For Hnear iuminaires, wattage should be indicated as Wiff instead of Watts/lumin <sup>3</sup> Select "New" for new luminaires in a new autibor lighting project, or for added it		
03	04	05	This table includes remarks made by the permit applicant to the Authority Ha	ving Eurisdiction.		for existing luminaires within the project scope that are not being altered and are t	emoining. Select "Existing Reinstalled" for existing luminaire	er which are being removed and reinstalled as part of
% of Existing Luminaires Being Altared 1 Sum 1	Total of Luminaires Being Added or Altered	Calculation Method				the project scope: <sup>5</sup> Compliance with mandatory stilefoling requirements is required for huminaires with	h initial lumen output >= 6,200 unless exempted by 130.2(b)	V 160.5(c)
Please proceed to Table F. Outdoor Lighting Fixture Schedule to define the	project's kuminaires.							
<sup>2</sup> FOOTNOTES: % of Existing Luminoires Being Altered = (Sum Total of Lumina)	aires Being Added ar Altered / Existing Luminaires within th	he Scape of the Permit Application) x 100:				G. SHIELDING REQUIREMENTS (BUG)		
						This section does not apply to this project.		
	Generated Date/Time:	Documentation Software: Energy Code Ace		Generated Date/Time:	Documentation Software: Energy Code Ace		Generated Date/Time:	Documentation Software: Energy Code Ace
CA Building Energy Efficiency Standards - 2022 Nonrealdential Compliance	Report Version: 2022.0.000	Compliance ID: 251836-0825-0008	CA Building Energy Efficiency Standards - 2022 Nonresidential Compliance	Report Version: 2022.0.008	Compiliance ID: 281838-0625-0008	CA But ding Energy Efficiency Standards - 2022 Normesidential Compilance	Report Version: 2022.0.000	Compliance ID: 281838-0625-0008
	Scheme Version: 2022.0.000 Scheme Version: rev 2022.01.01	Report Generated: 2023-06-05 13:15:36		Schema Version: 2022/0000 Schema Version: rev 2022/01001	Compilance It: 2015-06-05 15:15:36 Report Generated: 2015-06-05 15:15:36	- comming congressions and sense receipt the companies	Schema Version: nev 20220101.	Report Generated: 2025-06-05 15:15:56
			1			1		





www.mneilsengineering.com Tel: (916) 923-4400 Fax: (916) 923-4410

PROJECT #: 19086.21

IF NOT ONE INCH ON THIS SHEET, ADJUST SCALES ACCORDINGLY

	ROAD NAME: CONSERVATION CAMP RD	M.NEILS ENGINEERING	
N	ROAD NO:	MILE POST:	
	PROJECT NO.: 438005	EA NO.:	DESIGNED BY: SKL
N T Y	CONTRACT NO.:	BRIDGE NO:	DRAWN BY: PI
	DRAWING FILE NAME:		REVIEWED BY: SKL/JLB
	PLOT DATE: 6/17/25	REVISION DATE:	APPROVED BY: JLB
		-	-

COUNTY OF HUMBOLDT DEPARTMENT OF PUBLIC WORKS 58 REDWAY TRANSFER STATION 58

E5.6

TITLE 24 RECYCLE BUILDING **OUTDOOR LIGHTING** 

Outdoor Lighting **Outdoor Lighting Outdoor Lighting** CERTIFICATE OF COMPLIANCE NRCC-LTO-CERTIFICATE OF COMPLIANCE NRCC-LTQ-CERTIFICATE OF COMPLIANCE Project Name: 19086.21 Radway Transfer Station - Recycle Building ct Name: 19086.21 Redway Transfer Station - Racycle Building Project Name: 19066.21 Redway Transfer Station - Recycle Building 2025-06-05T18:15:33-04:00 2025-06-05T18:15:33-04:00 H. OUTDOOR LIGHTING CONTROLS I. LIGHTING POWER ALLOWANCE (per 140.7 / 170.2(e)) J. LIGHTING ALLOWANCE: PER APPLICATION This table demonstrates compliance with controls requirements for all new or altered luminoires installed as part of the permit application. For alteration projects, luminaires which are existing to remain (is untauched) and luminaires which are removed and reinstalled (wiring only) do not need to be included in this table even if they are within the spaces covered by the permit application. This table includes areas using allowance calculations per 140.7 / 170.2(e). General Mordscape Allowance is per Table 140.7 A/Table 170.2.R while "Use it ar leas it" Allowances are per Table 140.7-8 / Table 170.2.S. Indicate which allowances ore being used to expand sections for user input. Luminoires that quolify for one of the "Use it or lose it" allowances shell not qualify for orather "Use it or lease it" allowance. Cutdoor lighting attacked to multiformity buildings and controlled from the inside of a dwelling unit are included to Table H. and are not included here. All other multiformity This table includes areas using the wattage allowance per application from Table 140.7-8 / Table 170.2-5. "Use it or lose it" Allowance (select all that apply) (select all that apply) 06 07 08 09 une permu upprocuum.
Dutdoor lighting for nanresidential buildings, parking garages and common service areas in multifamily buildings must be documented separately from autoboar lighting attached to multifamily buildings and controlled from the inside of a diselling unit ⊠ Genera # of Watts per esign Wa Application Table J Mandatory Controls for Nonresidential Occupancies, Parking Garages & Common Areas in Multifamily Buildings Luminaire (Watts) Item Tag lighting is included here. 15 90 270 Building Entrance/Exit 45 C2 3 45 Werehouse Entrances Calculated General Hardscape Lighting Power Allowance per Table 140.7-A for Nonres Field Inspector Area Description 130.2(c)1 / 160.5(c) 130.2(c)2 / 160.5(c) 130.2(c)3 / 160.5(c) Total Allowance (Watts) All Areas: Pass Warehouse Entrances: "C2" NA: Industrial Sites Lightin Other Control Area Description AWA + LWA <sup>5</sup> FOCTNOTES: Primary entronce applications are aniy available for seniar care facilities, healthcare facilities, valice stations, hassitais, fire <sup>2</sup>FOOTNOTE: Text has been abbreviousd, alease refer to Table 150.5-A to confi ompliance with the specific light. (Watts) ation for ATMs is SGGW for the first ATM and 35W for each additional per Table 140.7-8 /Table 170.2-5. 132.6 Around Recycle Warehouse Initial Wattees Allowance for Entire Site (Watts): Instances of Initial Wattage Allowance (LZ 0 only)<sup>1</sup>
Total General Hardscape Allowance (Watts): K. LIGHTING ALLOWANCE: SALES FRONTAGE 332.6 This section does not apply to this project. L. LIGHTING ALLOWANCE: ORNAMENTAL This section does not apply to this project M. LIGHTING ALLOWANCE: PER SPECIFIC AREA This section does not apply to this project. N. EXISTING CONDITIONS POWER ALLOWANCE (alterations only) This section does not apply to this project. Ocumentation Softwere: Energy Code Ac Compliance ID: 281838-0625-0008 Report Generated: 2025-06-05 15:13:36 Compilance ID: 281838-0625-0008 Report Generated: 2023-06-03 15:15:36 Compliance ID: 281838-0625-0008 Report Generated: 2025-06-05 13:15:36 Report Version: 2022.0.000 Schema Version: rev 2022010 CA Building Energy Efficiency Standards - 2022 Monresidential Compilance CA Building Energy Efficiency Standards - 2022 Nonresidential Compliance CA Building Energy Efficiency Standards - 2022 Nonresidential Compilance STATE OF CALIFORNIA STATE OF CALIFORNIA **Outdoor Lighting Outdoor Lighting** CALIFORNIA ENERGY COMMISSION CALIFORNIA ENERGY COMMISSION Outdoor Lighting Mandatory Measures: CENTIFICATE OF COMPLIANCE NRCC-LTO-E CERTIFICATE OF COMPLIANCE NRCC-LTO-E 110.9 OUTDOOR LIGHTING CONTROLS AND COMPONENTS
ALL LIGHTING CONTROL DEVICES AND SYSTEMS, AND ALL LIGHT SOURCES SHALL MEET THE APPLICABLE REQUIREMENTS OF 110.9. 130.0 GENERAL LUMINAIRE REQUIREMENTS ALL LUMINAIRES SHALL BE FACTORY-LABELLED PER 130.0(c). DOCUMENTATION AUTHOR'S DECLARATION STATEMENT ENERGY MANAGEMENT CONTROL SYSTEMS (EMCS) SHALL MEET REQUIREMENTS OF 130.0(e). O. DECLARATION OF REQUIRED CERTIFICATES OF INSTALLATION I certify that this Certificate of Compliance documentation is accurate and complete 130.2(c) CONTROLS FOR OUTDOOR LIGHTING ctions have been made based on information provided in this document. If any selection has been changed by permit applicant, an explanation should be included in Table E. tional Remarks. These documents must be provided to the building inspector during construction and can be found online ALL OUTDOOR LIGHTING SHALL BE INDEPENDENTLY CONTROLLED FROM OTHER ELECTRICAL LOADS AND SHALL HAVE THE FOLLOWING FEATURES: 2. AUTOMATIC SCHEDULING CONTROLS Form/Title AUTOMATIC SCHEDULING CONTROLS SHALL BE INSTALLED FOR ALL OUTDOOR LIGHTING. Company: M. Neils Engineering 06/17/2025 B. CAPABLE OF REDUCING LIGHTING POWER AT LEAST 50% AND NO MORE THAN 90% AND SEPARATELY CAPABLE OF TURNING LIGHTING OFF DURING NRCI-LTC-E - Must be submitted for all buildings C. THAT ALLOW SCHEDULING OF AT LEAST TWO NIGHTTIME PERIODS WITH INDEPENDENT LIGHTING LEVELS (MAY INCLUDE OVERRIDE FOR NO MORE THAN 2 RESPONSIBLE PERSON'S DECLARATION STATEMEN P. DECLARATION OF REQUIRED CERTIFICATES OF ACCEPTANCE HOURS) The information provided any this carries and control to serve an extension of the following of the following provided any this carries are Compliance to use and consent.

I am eligible under Division 3 of the Business and Professions Code to accept responsibility for the building design or system design blendfled on this Certificate of Compliance (responsible designer). The energy features and performance specifications, materials, components, and manufactured devices for the building design or system design identified on this Certificate of Compliance conform to the responsibility of the building design or system design identified on this Certificate of Compliance conform to the responsibility of the building design or system design identified on this Certificate of Compliance Certificate of Compliance conform to the responsibility of the building design or system design identified on this Certificate of Compliance (responsible design or system). Selections have been made based on information provided in this document. If any selection has been changed by permit applicant, an explanation should be included in Table E. Additional Remorks. These documents must be provided to the building inspector during construction and must be completed through on Acceptance Test Technician Certification Provider (ATTCP). For more information visit: http://www.energy.ca.gov/btle24/attcp/providers.html of This 24, Part 1 and Part 5 of the California Code of Regulations.

The building depth Restureor wystem design Pateurs building on this Certificate of Compliance are consistent with the Information provided on other applicable compliance documents, worksheets, calculations, plans and specifications such intention to the enforcement approxy for approach with this building parmet application.

Full immune that is compliated applicated of Compliance shall be made to enable with the building parmet(s) leaved for the building, and made wall believe the westforcement approxy for all applicable impactions. I understand these complianced signed copy of this Certificate of Compliance shall be included with the documentation the building provides to the building owners of compliance for Compliance shall be included with the documentation the building provides to the building owners of compliance for Compliance for required to the included with the documentation the building provides to the building owners of compliance for Compliance for required to the sound of the compliance of the Systems/Spaces To Be Field Form/Title NRCA-LTC-02-A - Must be submitted for all outdoor lighting controls except for alterations where controls are added to <= 20 luminaires. Indiad with the community of the Designer Signature: Onto Signed: 06/17/2025 Company: IVI. Neils Engineering an Saftware: Energy Code Ace ion Software: Energy Code Ace CA Building Energy Efficiency Standards - 2022 Nonresidential Compilance Raport Varsion: 2022.0.000 Schema Version: rev 202201) Compliance ID: 201938-0625-0009 Report Generated: 2025-06-05 15:15:36 CA Building Energy Efficiency Standards - 2022 Nonresidential Compilance Compliance ID: 281838-0625-0008 Report Generated: 2025-06-05 15:15:36