GHD Inc. 718 Third Street Eureka California 95501 USA T 1 707 443 8326 F 1 707 444 8330 W www.ghd.com

BAR IS ONE INCH ON ORIGINAL DRAWING
IF NOT ONE INCH ON THIS SHEET, ADJUST SCALES ACCORDINGLY

ROAD NAME: MONUMENT ROAD	■ DESIGN SECTION	COUNTY OF HUMBOL
ROAD NO: 3F020	ENGINEERING	DEPARTMENT OF PUBLIC
MILE POST: 0.00	DESIGNED BY: C.PROVO	STORM DAMAGE REPAIR MONUMENT
PROJECT NO.: 4308-CA-DR PW#1276	DRAWN BY: C.PROVO	
CONTRACT NO.: 217356	REVIEWED BY: J.WOLF	TITLE SHEET
D. AT D. TE. At (0.3 (0.00)	ADDDONED BY LINOLE	1

WORKS 1 OF

# COUNTY OF HUMBOLDT DEPARTMENT OF PUBLIC WORKS

#### NOTES

- THE CONTRACTOR SHALL HAVE A CLASS "A" LICENSE FOR THIS PROJECT.
- 2. STANDARD PLAN LIST APPLICABLE TO THIS CONTRACT INCLUDED IN THE SPECIAL PROVISIONS.
- GEOTECHNICAL REPORT: CRAWFORD AND ASSOCIATES, MARCH 19, 2021.
- 4. PROJECT LOCATION; LAT:40°29'27.02"N, LONG:124°6'40.04"W

# PR

ABBREVIATIONS (TO SUPPLEMENT CALTRANS STANDARD PLANS A3A, A3B & A3C)

APN ASSESSORS PARCEL NUMBER

CL CENTERLINE

CT CALTRANS
(E) EXISTING

EL ELEVATION

ICL IMPLIED COMMON LAW DEDICATION

K K-VALUE

LT LEFT

PVI POINT OF VERTICAL INTERSECTION

RT RIGHT

S SLOPE



VICINITY MAP




# PROJECT PLANS FOR CONSTRUCTION OF STORM DAMAGE REPAIRS MONUMENT ROAD (3F020) AT P.M. 0.00 PROJECT NO. 4308-CA-DR PW#1276 CONTRACT NO. 217356

TO BE SUPPLEMENTED BY STATE OF CALIFORNIA DEPARTMENT OF TRANSPORTATION 2018 STANDARD PLANS, 2018 STANDARD SPECIFICATIONS, AND LATEST REVISED STANDARD PLANS AND SPECIFICATIONS.



#### SHEET LIST TABLE

SHEET	SHEET TITLE
1	TITLE SHEET
2	CONSTRUCTION AREA SIGNS AND QUANTITIES
3	STAGE CONSTRUCTION PLAN
4	SURVEY CONTROL PLAN
5	TYPICAL ROADWAY SECTIONS
6	LAYOUT - 1 OF 2
7	LAYOUT — 2 OF 2
8	PROFILE AND SUPERELEVATION
9	DRAINAGE AND UTILITIES
10	DRAINAGE PROFILE
11	EROSION CONTROL
12	SIGNING AND STRIPING
13	CONSTRUCTION DETAILS
14	ROADWAY CROSS SECTIONS - 1 OF 3
15	ROADWAY CROSS SECTIONS — 2 OF 3
16	ROADWAY CROSS SECTIONS — 3 OF 3
17	RETAINING WALL GENERAL PLAN
18	STRUCTURAL GENERAL NOTES & ABBREVIATIONS
19	RETAINING WALL LAYOUT NO. 1
20	RETAINING WALL LAYOUT NO. 2
21	SOLDIER PILE WALL DETAILS NO. 1
22	SOLDIER PILE WALL DETAILS NO. 2
23	SOLDIER PILE WALL DETAILS NO. 3
24	GROUND ANCHOR DETAILS

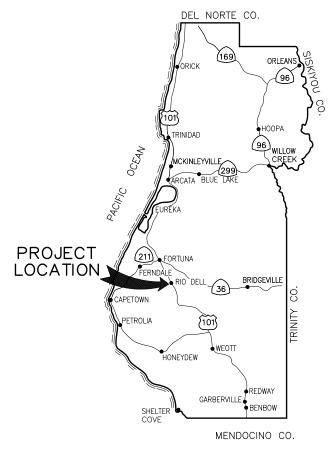

NOT TO SCALE

1/23/2023



APPROVED

JOSH A. WOLF RCE 70358
CIVIL ENGINEER
GHD INC.

TONY R. SEGHETTI
RCE 63714

2/16/2023

DATE

DEPUTY DIRECTOR OF ENGINEERING

### QUANTITIES

ltem No.	Item Code		Item Description	Unit	Quantity
1	120090		Construction Area Signs	EA	16
2	120100		Traffic Control System	LS	1
3	120202		Portable Signal System	LS	1
4	129000		Temporary Railing (Type K)	LF	420
5	130100		Job Site Management	LS	1
6	130200		Prepare Water Pollution Control Program	LS	1
7	130620		Temporary Drainage Inlet Protection	EA	4
8	130680		Temporary Silt Fence	LF	440
9	130900		Temporary Concrete Washout	EA	1
10	170103		Clearing and Grubbing (LS)	LS	1
11	190101		Roadway Excavation	CY	705
12	192049	F	Structure Excavation (Soldier Pile Wall)	CY	1238
13	193029	F	Structure Backfill (Soldier Pile Wall)	CY	741
14	193116	F	Concrete Backfill (Soldier Pile Wall)	CY	134
15	193119	F	Lean Concrete Backfill	CY	132
16	198050		Embankment	CY	34
17	210212		Dry Seed (SQFT)	SQFT	6500
18	210280		Rolled Erosion Control Product (Blanket)	SQFT	6500
19	210350		Fiber Rolls	LF	460
20	260203		Class 2 Aggregate Base (CY)	CY	275
21	390132		Hot Mix Asphalt (Type A)	TON	179
22	394073		Place Hot Mix Asphalt Dike (Type A)	LF	70
23	394077		Place Hot Mix Asphalt Dike (Type F)	LF	246
24	460210		Ground Anchor (Subhorizontal)	EA	32
25	490325A		Steel Soldier Piling (W18x106)	LF	1518
26	490403		30" Drilled Hole	LF	1555
27	510060A	F	Structural Concrete, Retaining Wall (Waler)	CY	51
28	510094A		Minor Concrete, Drainage Inlet (Type GO)	EA	2
29	520103A	F	Bar Reinforcing (Retaining Wall - Waler)	LB	25700
30	575004	F	Timber Lagging	MFBM	32
31	641107A		18" Plastic Pipe (Heat-Fused HDPE)	LF	248
32	680902		6" Perforated Plastic Pipe Underdrain	LF	243
33	680903		6" Non-Perforated Plastic Pipe Underdrain	LF	97
34	692381		Concrete Anchor and Cable Assembly	EA	1
35	700638		36" Corrugated Steel Pipe Inlet (.079" Thick)	LF	11.5
36	710132		Remove Culvert (LF)	LF	57
37	723080		Rock Slope Protection (60 lb, Class II, Method B) (CY)	CY	13
38	723095		Rock Slope Protection (20 lb, Class I, Method B) (CY)	CY	1
39	729011		Rock Slope Protection Fabric (Class 8)	SQYD	40
40	750500A	F	Miscellaneous Metal (Inlet Grate, Galvanized Type 24-12X)	LB	478
41	780230		Survey Monument (Type D)	EA	1
42	820110		Milepost Marker	EA	1
43	820170		Delineator (Class 1)	EA	8
44	832006		Midwest Guardrail System (Steel Post)	LF	250
45	839580		End Anchor Assembly (Type SFT-M)	EA	1
46	839585		Alternative Flared Terminal System	EA	1
47	839521	F	Cable Railing	LF	269
48	840505A		4" Thermoplastic Traffic Stripe	LF	580
49	999990		Mobilization	LS	1

STOP HERE ON RED

(LOCATE AS NEEDED)

W20-4

LIMITS OF WORK



GHD Inc.
718 Third Street
Eureka California 95501 USA
T 1707 443 8326 F 1707 444 8330 W www.ghd.cor

IF NOT ONE INCH ON THIS SHEET, ADJUST SCALES ACCORDINGLY

TYPICAL STATIONARY CONSTRUCTION AREA SIGNS

 ROAD NO:
 3F020
 ENGINEERING

 MILE POST:
 0.00
 DESIGNED BY: C.PROVO

 PROJECT NO.:
 4308-CA-DR PW#1276
 DRAWN BY:
 C.PROVO

 CONTRACT NO.:
 217356
 REVIEWED BY:
 J.WOLF

 PLOT DATE:
 01/27/2023
 APPROVED BY: J.WOLF

DESIGN SECTION

STORM DAMAGE REPAIR MONUMENT ROAD PM 0.00

CONSTRUCTION AREA SIGNS AND QUANTITIES

COUNTY OF HUMBOLDT DEPARTMENT OF PUBLIC WORKS

SHEET


2


#### STATIONARY MOUNTED CONSTRUCTION AREA SIGNS

#### TEMPORARY TRAFFIC CONTROL NOTES:

- ALL TRAFFIC CONTROL SHALL BE IN ACCORDANCE WITH THE LATEST EDITION OF THE CALIFORNIA MANUAL ON UNIFORM TRAFFIC CONTROLS DEVICES (CAMUTCD) AND CALTRANS 2018 STANDARD PLANS.
- 2. EXACT SIGN LOCATIONS AND POSITIONS TO BE APPROVED BY THE ENGINEER.
- 3. ALL WARNING SIGNS SHALL HAVE A BLACK LEGEND AND BORDER ON ORANGE BACKGROUND.
- 4. ALTERNATIVE POST CONFIGURATION TO BE APPROVED BY COLINTY ENGINEER
- REFER TO CAMUTCD FIGURE 6H-12 FOR LANE CLOSURE ON A TWO-LANE ROAD USING TRAFFIC CONTROL SIGNALS (TA-12).
- 6. MAINTAIN ALL SIGNS THROUGHOUT DURATION OF
- 7. MAINTAIN ONE TRAVEL LANE AT ALL TIMES.
- PROVIDE FLAGGERS AS REQUIRED TO ACCOMMODATE

  CONSTRUCTION

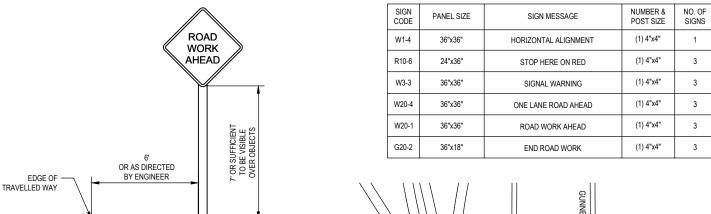

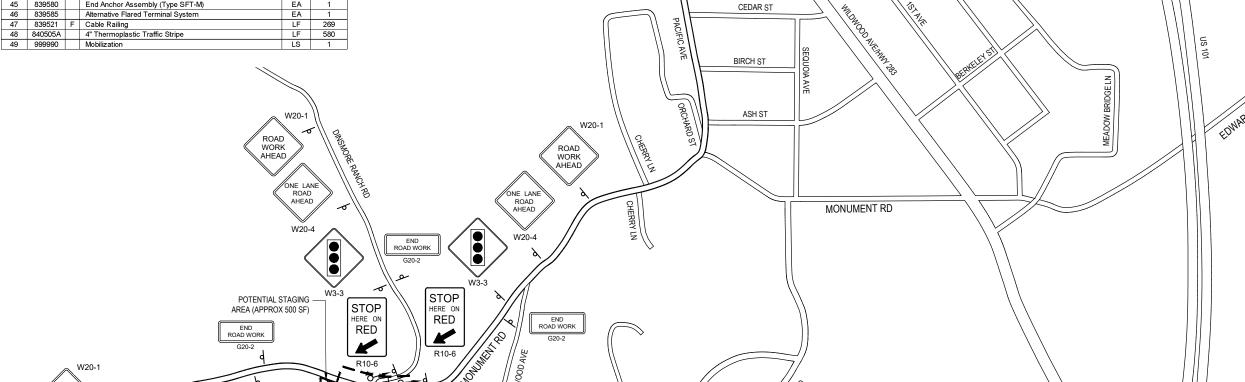

**CONSTRUCTION AREA SIGNS** 

NOT TO SCALE

DOUGLAS ST

# STOCKPILE NOTES:


 STOCKPILE SHALL HAVE FIBER ROLL, HAY BALES, SILT FENCE, OR OTHER APPROVED LINEAR BARRIER AROUND STOCKPILE.

HILLTOP DR

- STOCKPILE SHALL BE COVERED WITH PLASTIC WHEN NOT IN USE AND BE WEIGHTED DOWN WITH SANDBAGS OR EQUIVALENT (AS PER STANDARD PLAN T53).
- IF STOCKPILE AREA IS IN A TURNOUT THE TURNOUT SHALL BE REESTABLISHED TO PRE-CONSTRUCTION CONDITIONS.
- IF TEMPORARY CULVERTS ARE INSTALLED IN THE DITCH LINE DITCH LINE SHALL BE RECONSTRUCTED AT END OF PROJECT.

LEGEND

SIGN
TRAFFIC SIGNAL

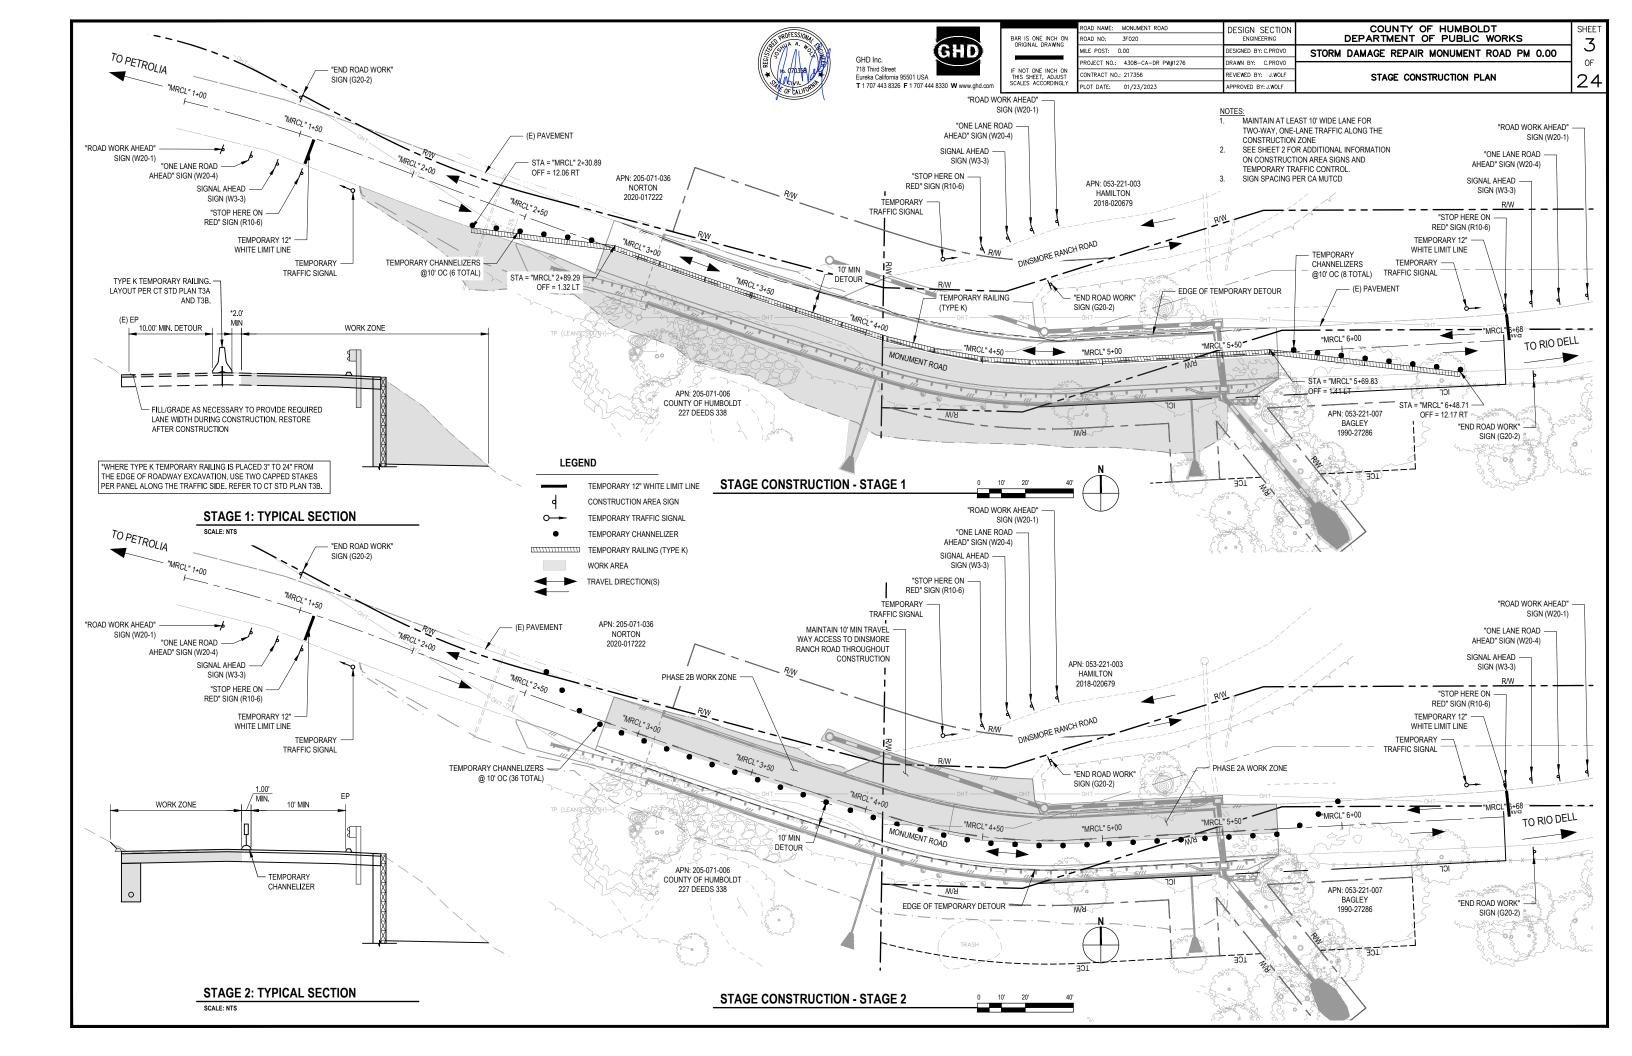



718 Third Street ureka California 95501 USA T 1 707 443 8326 F 1 707 444 8330 W www.ahd.com

IF NOT ONE INCH ON THIS SHEET, ADJUST SCALES ACCORDINGLY

3F020 LE POST: 0.00 SIGNED BY: C.PROVO OJECT NO.: 4308-CA-DR PW#1276 NTRACT NO.: 217356 EVIEWED BY: J.WOLF OT DATE: 01/23/2023 PPROVED BY: J.WOLF

STORM DAMAGE REPAIR MONUMENT ROAD PM 0.00

COUNTY OF HUMBOLDT DEPARTMENT OF PUBLIC WORKS


SURVEY CONTROL PLAN

MONUMENT ROAD CONSTRUCTION CENTERLINE GEOMETRY - "MRCL" ALIGNMENT							
Segment Type Length Radius Direction Start End Station Station							
C1	CURVE	89.26	663.00		"MRCL" 1+00.00	"MRCL" 1+89.26	
C2	CURVE	220.73	3211.00		"MRCL" 1+89.26	"MRCL" 4+09.99	
C3	CURVE	79.26	223.00		"MRCL" 4+09.99	"MRCL" 4+89.25	
L1	LINE	178.28	-	N86° 55' 34.59"E	"MRCL" 4+89.25	"MRCL" 6+67.52	

RETAINING WALL CONSTRUCTION CENTERLINE GEOMETRY - "RWLOL" ALIGNMENT							
Segment Type Length Radius Direction Start End Station Station							
C4	CURVE	110.56	3227.58		"RWLOL" 3+00.00	"RWLOL" 4+10.56	
C5	CURVE	85.15	239.58		"RWLOL" 4+10.56	"RWLOL" 4+95.71	
L2	LINE	58.79	-	N86° 55' 48.81"E	"RWLOL" 4+95.71	"RWLOL" 5+54.50	

TO PETROLIA

'MRCL" 1+00

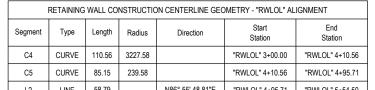

## **SURVEY CONTROL NOTES**

- 1. THE PURPOSE OF THIS SURVEY IS TO DETERMINE TOPOGRAPHY FOR A STORM DAMAGE REPAIR SITE AT PM 0.00 ON MONUMENT ROAD IN THE RIO DELL AREA. THE SITE HAS A ROADWAY FAILURE AND EVIDENCE OF PREVIOUS FAILURES AND PREVIOUS WOODEN RETAINING WALL/PILE CONSTRUCTION. THIS SURVEY REFLECTS CONDITIONS ON THE SITE AT TIME OF SURVEY; FIELD WORK PERFORMED ON 10/4/18, 11/19/18, AND 12/3/18.
- 2. UNDERGROUND UTILITIES RESEARCH WAS NOT PERFORMED. NO EVIDENCE OF UNDERGROUND UTILITIES WAS ENCOUNTERED IN THIS AREA OTHER THAN THE
- 3. COORDINATES FOR THIS SURVEY ARE CALIFORNIA COORDINATE SYSTEM OF 1983 (CCS83) ZONE 1, NAD 83, EPOCH 2010,00, US SURVEY FEET, BASED ON A RTK GPS CONTROL SURVEY PERFORMED ON 10/4/2018. THE MAPPING ANGLE IS 1 DEGREE 22 MINUTES 42 SECONDS- ROTATE BEARINGS COUNTERCLOCKWISE BY THIS ANGLE TO OBTAIN "TRUE" OR GEODETIC BEARINGS. GRID DISTANCES SHOWN SHOULD BE DIVIDED BY THE COMBINED SCALE FACTOR OF 0.99990976 TO OBTAIN GROUND DISTANCES. MAPPING ANGLE AND GRID SCALE FACTOR TAKEN AT NGS CONTROL POINT "101 HUM 53.32", PID "DH6338", WHICH IS THE BASIS OF THE HORIZONTAL CONTROL FOR THIS SITE, A HPGN CONTROL POINT LOCATED AT THE NORTHERLY RIO DELL OFFRAMP ON SOUTHBOUND US HIGHWAY 101
- 4. VERTICAL DATUM IS NAVD88 ELEVATIONS, IN FEET, BASED ON A TIE TO NGS CONTROL POINT "Q 1086", PID "LV0395", WHICH IS A BRASS DISC LOCATED AT THE NORTH END OF THE EAGLE PRAIRIE BRIDGE IN THE CITY OF RIO DELL, HELD AT THE PUBLISHED ELEVATION OF 137.60 FEET.
- 5. BOUNDARY LINES SHOWN HEREON ARE BASED ON BOOK 38 OF SURVEYS, PAGE 12 PER TIES TO RECORD MONUMENTS SHOWN THEREON. THE WITNESS CORNER TO THE QUARTER CORNER BETWEEN SECTIONS 6 & 7, TOWNSHIP 1 NORTH, RANGE 1 EAST FALLS WITHIN THE PROJECT AREA AS SHOWN HEREON. NO RIGHT OF WAY IS SHOWN FOR MONUMENT ROAD WEST OF THE QUARTER SECTION LINE SHOWN HEREON AS THE COUNTY OWNS THIS PROPERTY. THE PORTION OF MONUMENT ROAD EAST OF THE QUARTER SECTION LINE FALLS WITHIN THE CITY OF RIQ DELL. PROPERTY TO THE NORTH OF THIS PORTION OF MONUMENT ROAD ENDS AT THE NORTH LINE OF MONUMENT ROAD PER BOOK 153 OF DEEDS, PAGE 22; PROPERTY TO THE SOUTH OF THIS PORTION OF MONUMENT ROAD ENDS AT THE CENTERLINE OF MONUMENT ROAD PER BOOK 23 OF OFFICIAL RECORDS, PAGE 299, MEANING MONUMENT ROAD IS CONTAINED WITHIN A 25 FOOT FEE STRIP AND 25 FOOT EASEMENT. THE POSITION FOR THE 25 FEE STRIP AND 25 FOOT RIGHT OF WAY SHOWN HEREON DOES NOT MATCH THE POSITION SHOWN ON BOOK 53 OF SURVEYS, PAGES 98-101: THIS SURVEY HOLDS A COMMON POINT FOR THE NORTH LINE OF MONUMENT ROAD.
- 6. THE PILES/CUT OFF POLES SHOWN HEREON APPEAR TO BE REMNANTS OF A PREVIOUS WOODEN RETAINING WALL; ONLY A COUPLE HORIZONTAL MEMBERS REMAIN AND WERE VISIBLE. DEPTH OF THESE POLES AND ANY WALL UNDER THE GROUND SURFACE IS UNKNOWN
- 7. THIS SITE, ESPECIALLY THE PORTION FALLING WITHIN THE CITY OF RIO DELL, APPEARS TO BE THE SITE OF AN INFORMAL LANDFILL. LARGE AMOUNTS OF TRASH WERE FOUND ONSITE, AND ADDITIONAL TRASH WAS DUMPED DURING THE COURSE OF THE SURVEY
- 8. THE BRASS CAP LOCATED IN THE ROADWAY ON THE PROJECT SITE, POINT #101, IS A WITNESS CORNER TO THE QUARTER CORNER BETWEEN SECTIONS 6 & 7. TOWNSHIP 1 NORTH, RANGE 1 EAST. A PRE- AND POST-CONSTRUCTION CORNER RECORD SHOULD BE PREPARED BEFORE ANY DISTURBANCE TO THIS
- 9. TREES 12" AND LARGER LOCATED WITHIN THE PROJECT SITE ARE SHOWN HEREON. SMALLER TREES AND LARGE QUANTITIES OF POISON OAK EXIST ONSITE.

#### UNDERGROUND UTILITY NOTE


**GENERAL NOTES** 


DESIGN SECTION

- CONTRACTOR MUST COMPLY WITH BUSINESS AND PROFESSIONS CODE SECTION 8771 (b) REGARDING REFERENCING, PRESERVING AND RECONSTRUCTING MONUMENTS, WHETHER OR NOT MONUMENTS ARE SHOWN IN THESE PLANS
- IF MONUMENT IS DAMAGED BY CONTRACTORS OPERATIONS, CONTRACTOR SHALL REPLACE MONUMENT AT CONTRACTORS EXPENSE.

#### **LEGEND**




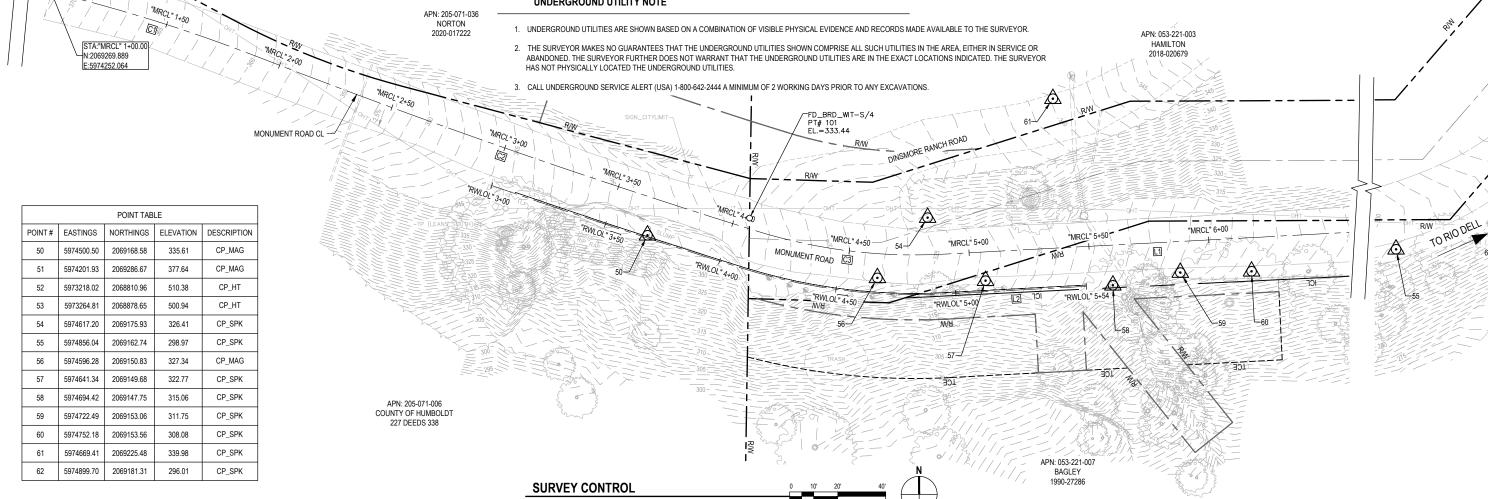


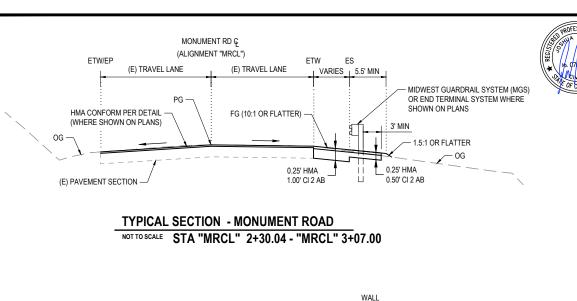



718 Third Street


Eureka California 95501 USA T 1 707 443 8326 F 1 707 444 8330 W www.ghd.cor

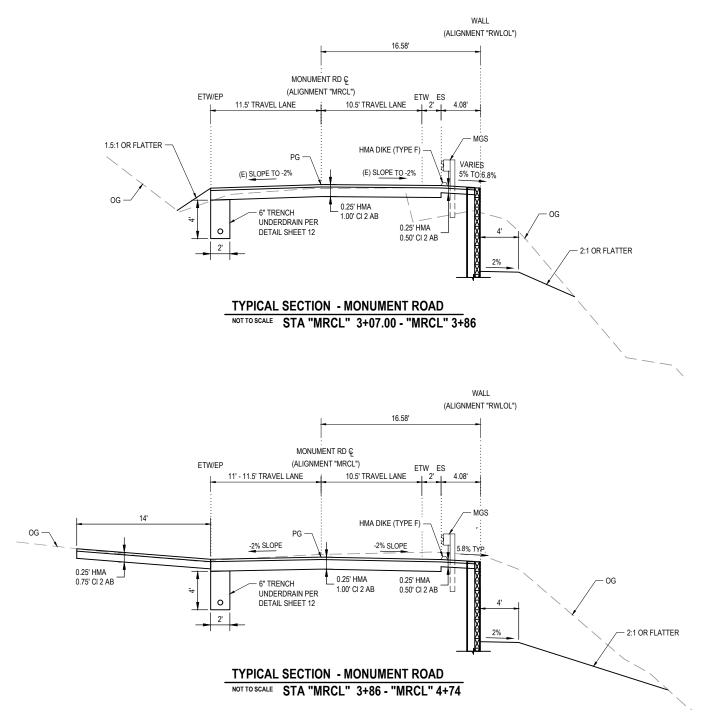

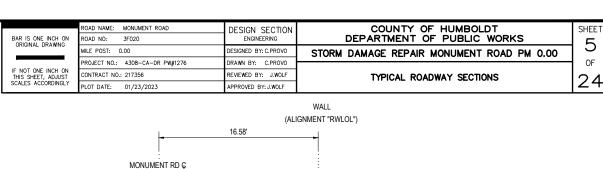

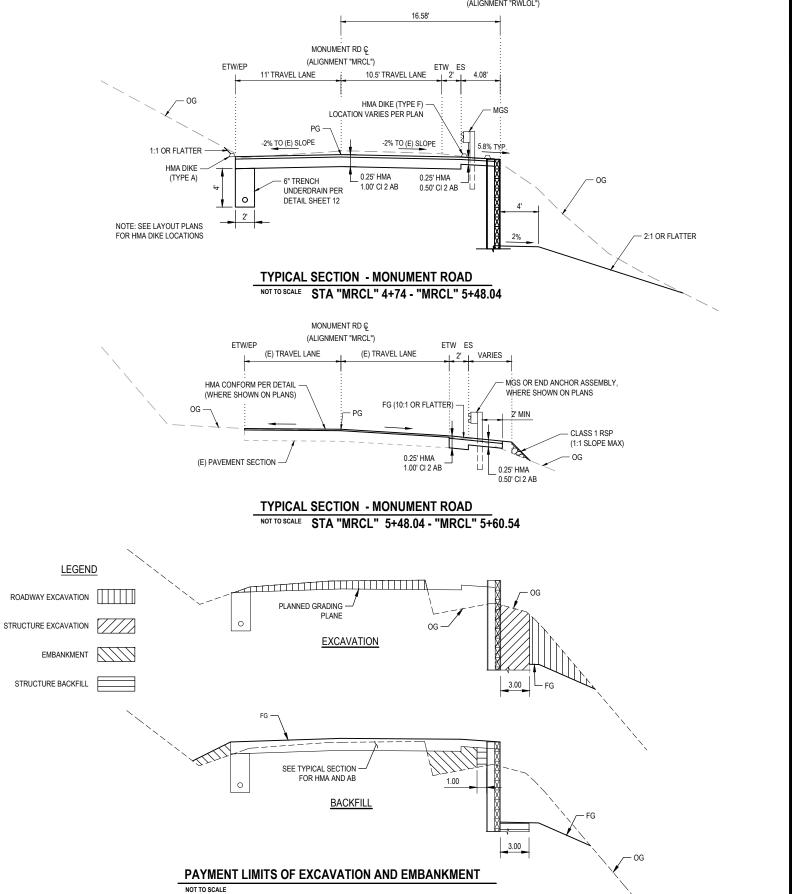

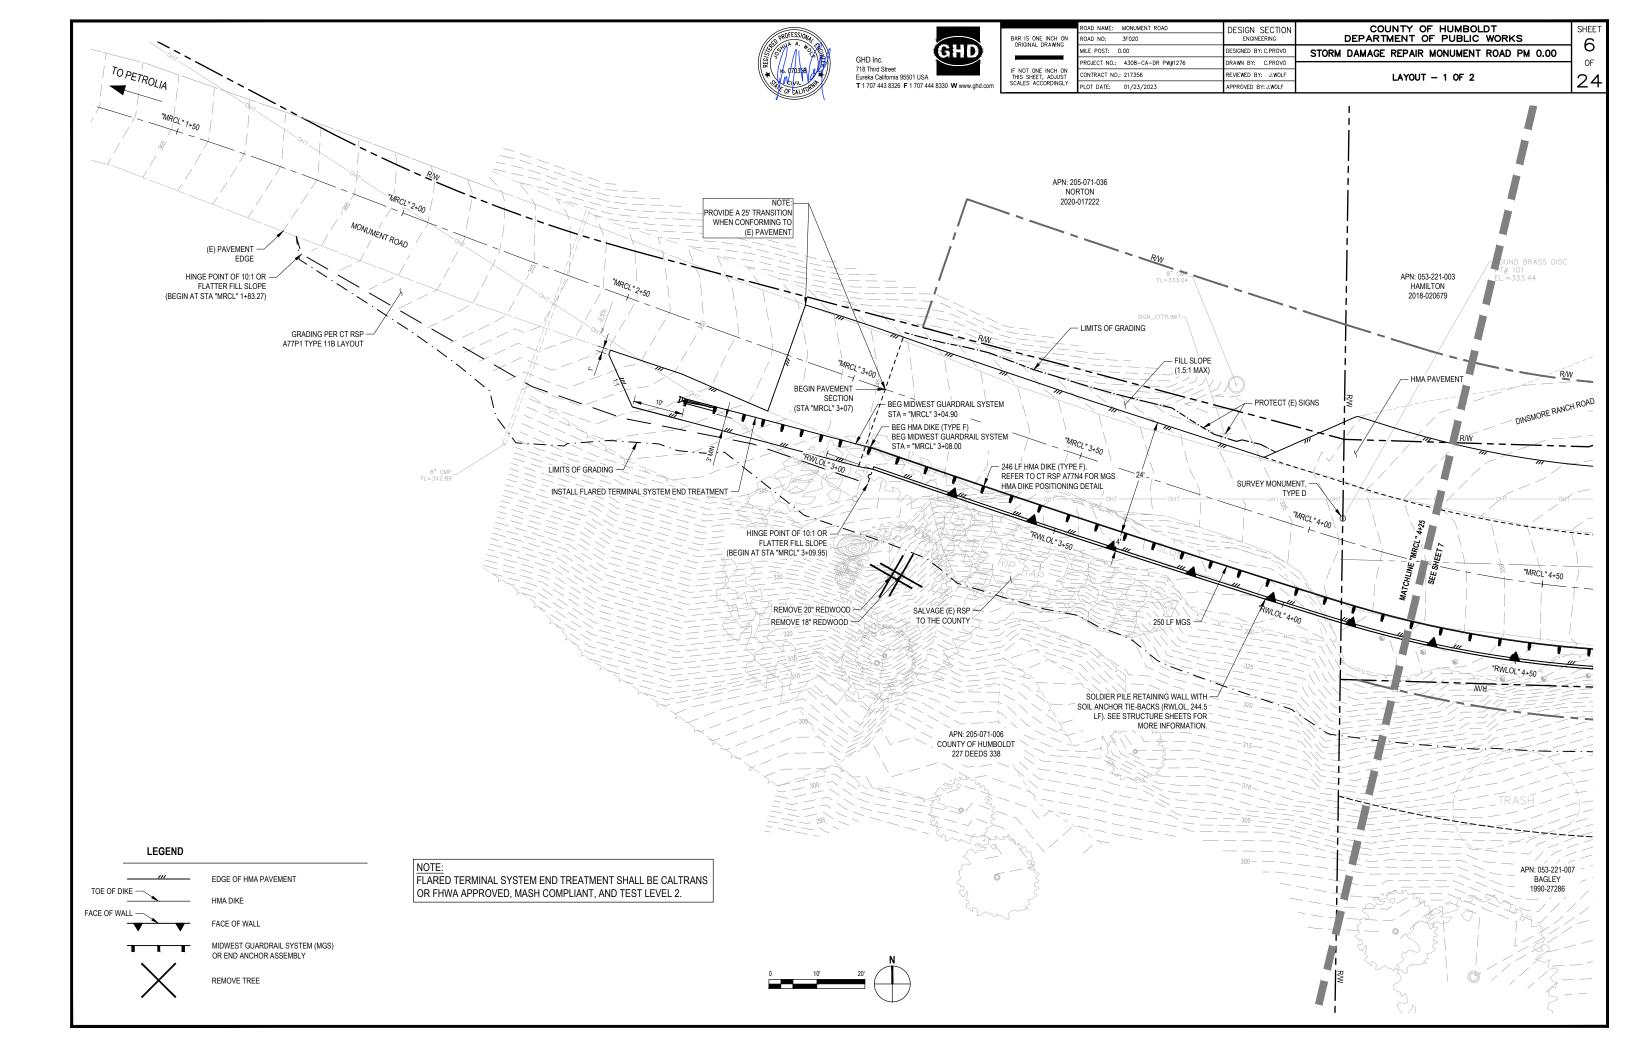

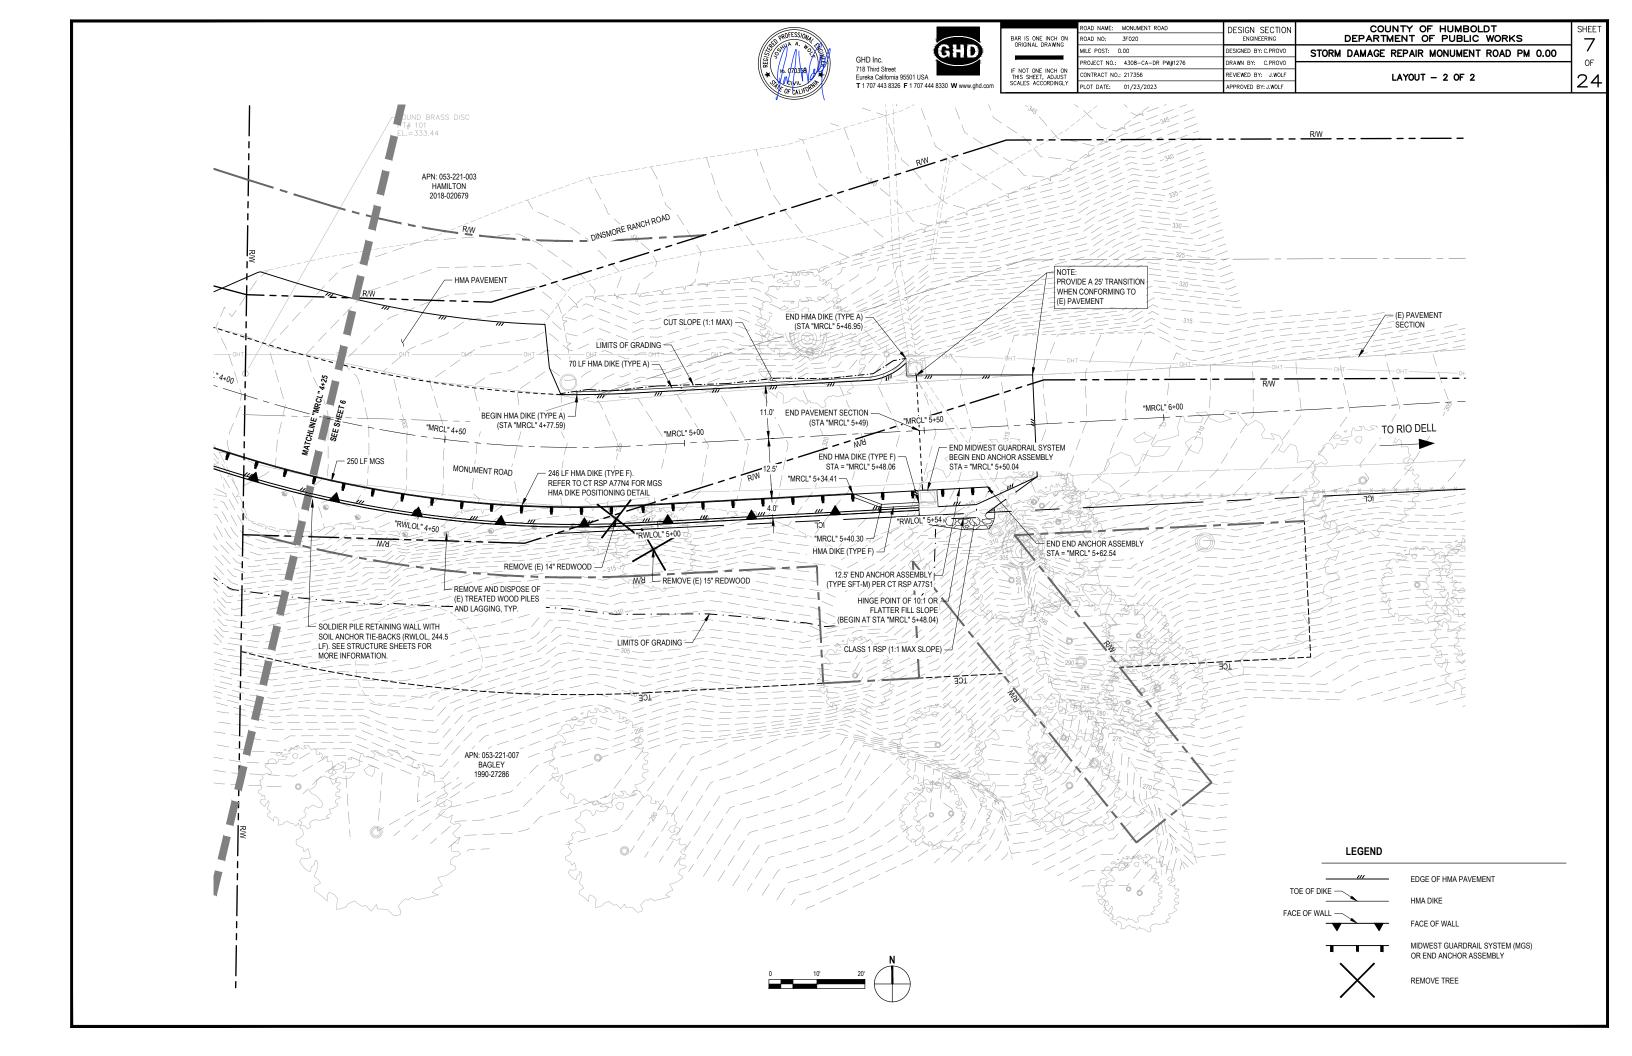



GHD 718 Third Street
Eureka California 95501 USA
T 1 707 443 8326 F 1 707 444 8330 W www.ghd.com

ORIGINAL DRAWING	ROAD NO: 3F020	ENGINEERING
	MILE POST: 0.00	DESIGNED BY: C.PROVO
	PROJECT NO.: 4308-CA-DR PW#1276	DRAWN BY: C.PROVO
IF NOT ONE INCH ON THIS SHEET, ADJUST	CONTRACT NO.: 217356	REVIEWED BY: J.WOLF
SCALES ACCORDINGLY	PLOT DATE: 01/23/2023	APPROVED BY: J.WOLF

DESIGN SECTION

ROAD NAME: MONUMENT ROAD

COUNTY OF HUMBOLDT DEPARTMENT OF PUBLIC WORKS 8 STORM DAMAGE REPAIR MONUMENT ROAD PM 0.00 OF 24

SHEET

PROFILE AND SUPERELEVATION

END PAVEMENT SECTION

- UNDERDRAIN VERTICAL RISER, STA = "MRCL" 5+47.00 OFF = 9.50 LT; INV = 312.92

"MRCL" 5+80

AND UNDERDRAIN (STA "MRCL" 5+49)

"MRCL" 5+60

OG=318.60 FG=318.67

"MRCL" 5+40

	ROADWAY GEOMETRY						
STATION	LEFT TRAVEL LANE CROSS SLOPE	LEFT ETW/EP ELEVATION	CROWN ELEVATION	RIGHT ES ELEVATION	RIGHT TRAVEL LANE CROSS SLOPE		
"MRCL" 3+07	-6.40%	344.27	345.01	345.30	2.30%		
"MRCL" 3+81	-2.00%	336.42	344.22	336.40	-2.00%		
"MRCL" 4+99	-2.00%	323.08	338.01	323.06	-2.00%		
"MRCL" 5+49	-1.00%	317.55	317.66	317.04	-5.00%		
Note: Negativ	Note: Negative cross slopes indicate downwards sloping away from centerline						

BOTTOM OF WALL -(SEE STRUCTURAL

"MRCL" 3+20

OG=340.82 FG=341.28

"MRCL" 3+40

"MRCL" 3+60

"MRCL" 3+80

"MRCL" 4+00


"MRCL" 4+20


SHEETS FOR DETAILS)

"MRCL" 3+00

"MRCL" 2+80

# **ROADWAY ELEVATIONS**

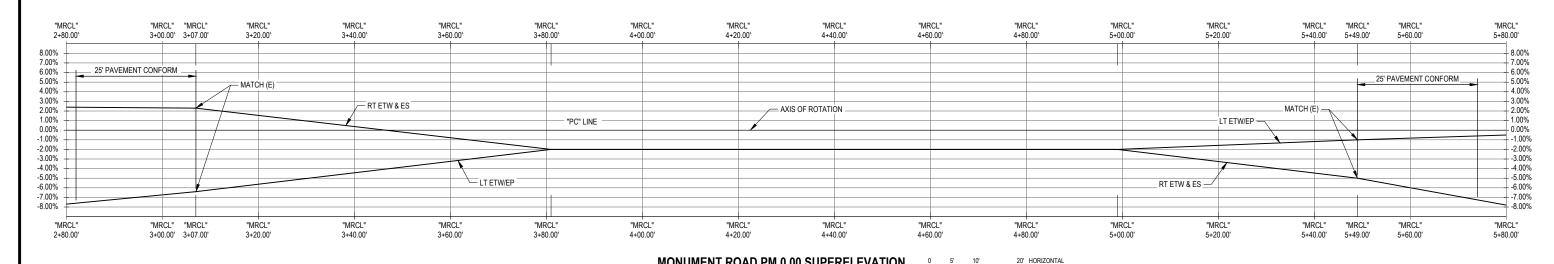

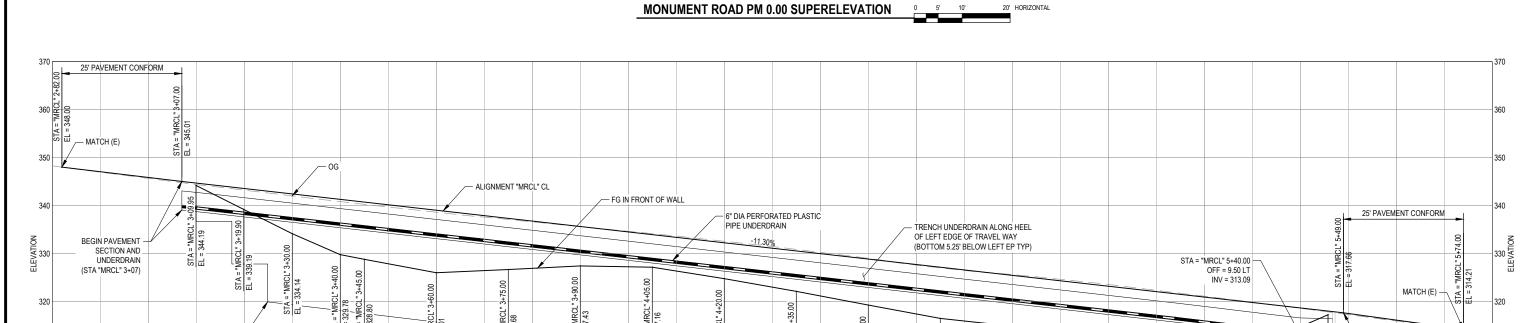

20' HORIZONTAL MONUMENT ROAD PM 0.00 PROFILE VIEW 20' VERTICAL

"MRCL" 4+60

-325.64 -325.46


"MRCL" 4+80

"MRCL" 5+00

"MRCL" 5+20

OG=330.26 FG=329.98

"MRCL" 4+40

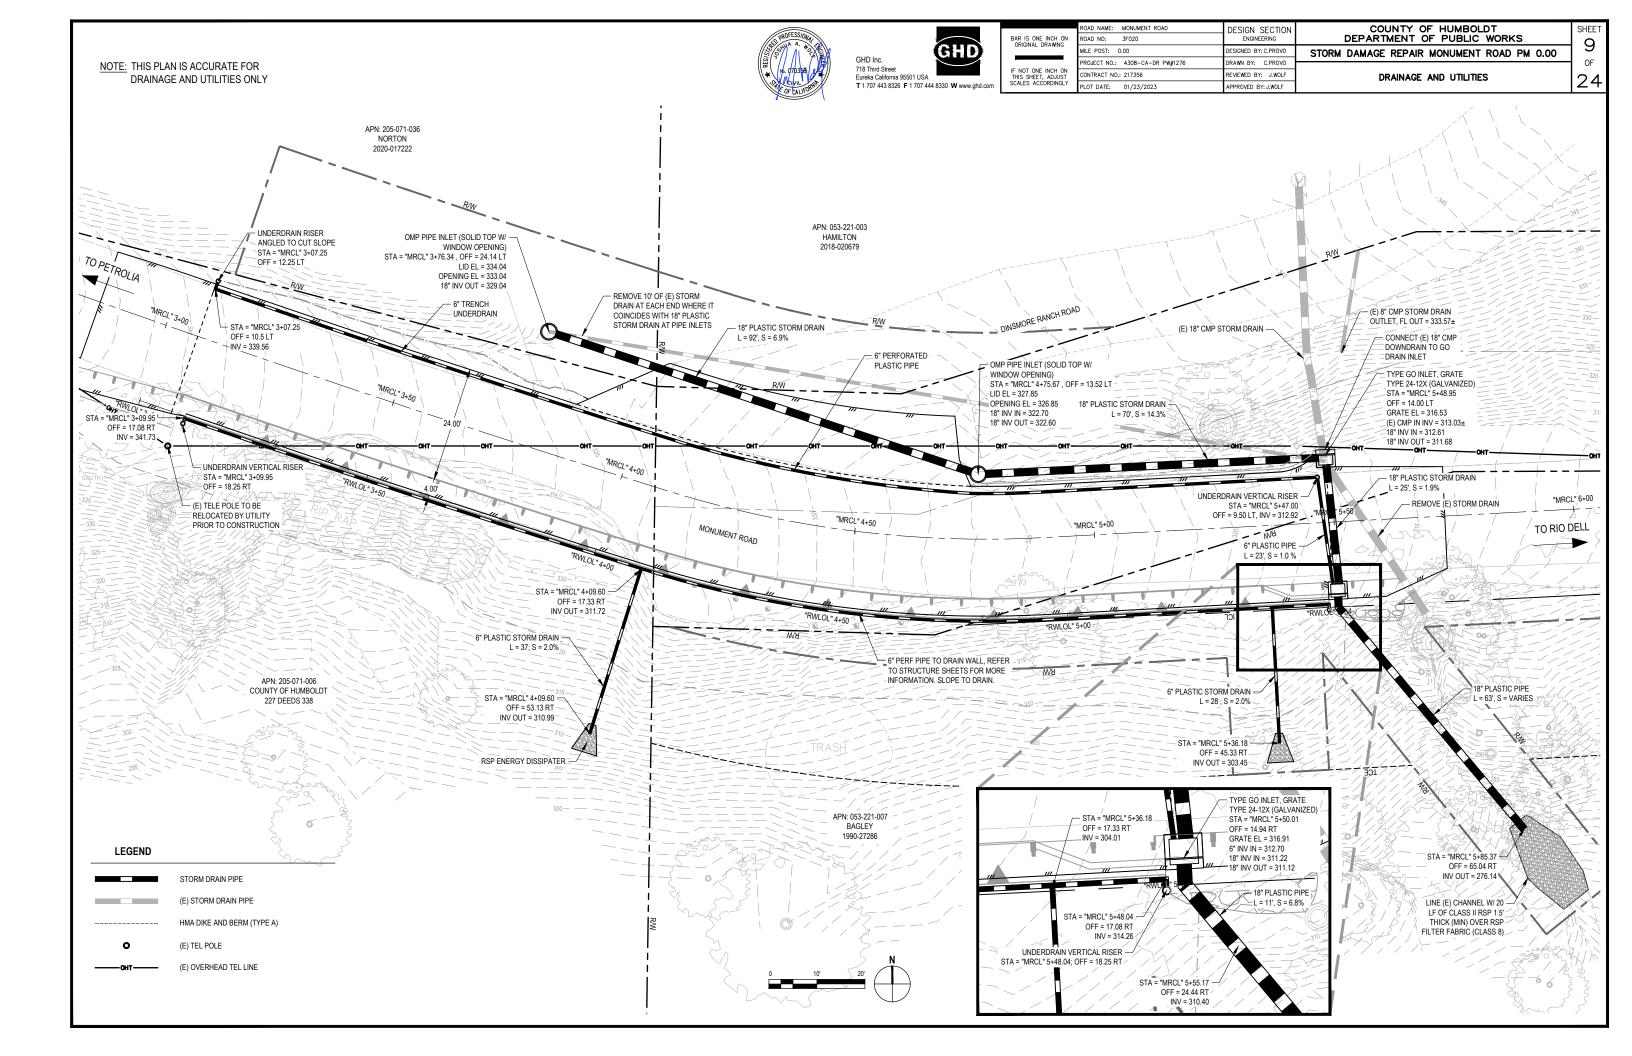




R IS ONE INCH ON RIGINAL DRAWING	ROAD NO:	3F02
RIGINAL DRAWING	MILE POST: 0.	00
	PROJECT NO.:	4308
	CONTRACT NO.:	2173
ALES ACCORDINGLY	PLOT DATE:	01/2

ROAD NAME: MONUMENT ROAD	DESIGN SECTION	COUNTY OF HUMBOLDT
ROAD NO: 3F020	ENGINEERING	DEPARTMENT OF PUBLIC WORKS
MILE POST: 0.00	DESIGNED BY: C.PROVO	STORM DAMAGE REPAIR MONUMENT ROAD PM 0.00
PROJECT NO.: 4308-CA-DR PW#1276	DRAWN BY: C.PROVO	
CONTRACT NO.: 217356	REVIEWED BY: J.WOLF	DRAINAGE PROFILE
PLOT DATE: 01/23/2023	APPROVED BY: J.WOLF	


SHEET


10

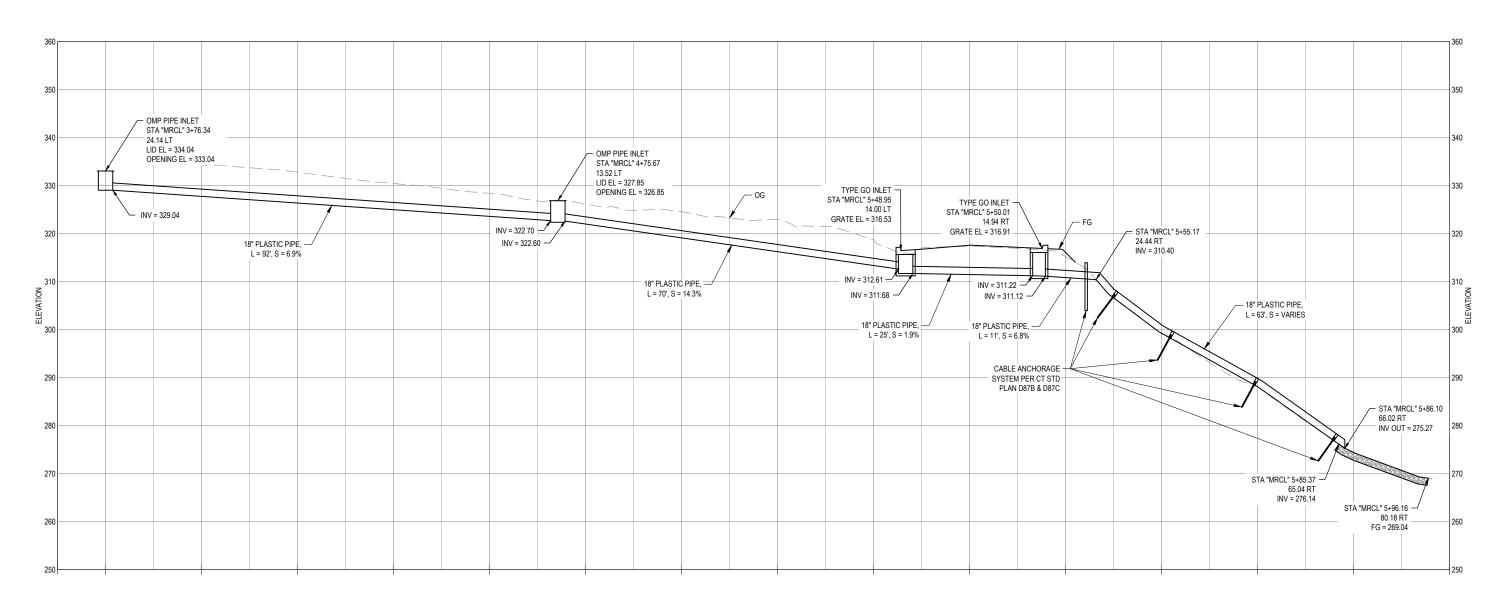

 18" STORM DRAIN SYSTEM PROFILE
 0
 5'
 10'
 20'
 HORIZONTAL

 0
 5'
 10'
 20'
 VERTICAL

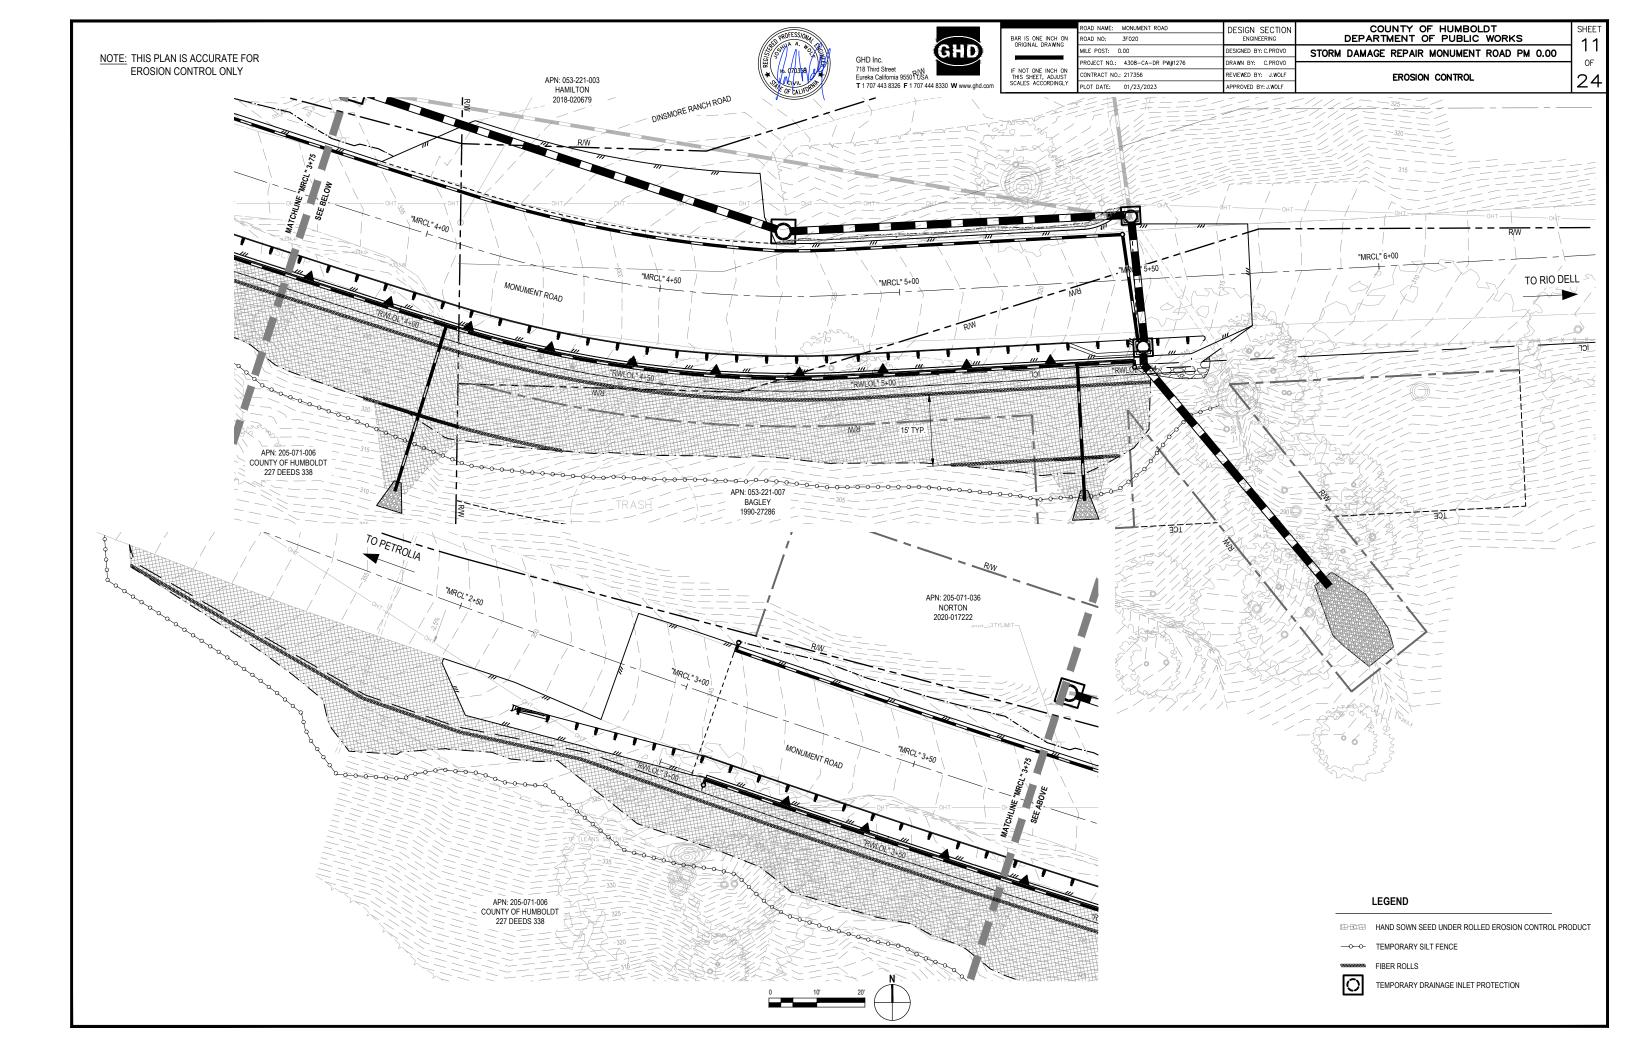

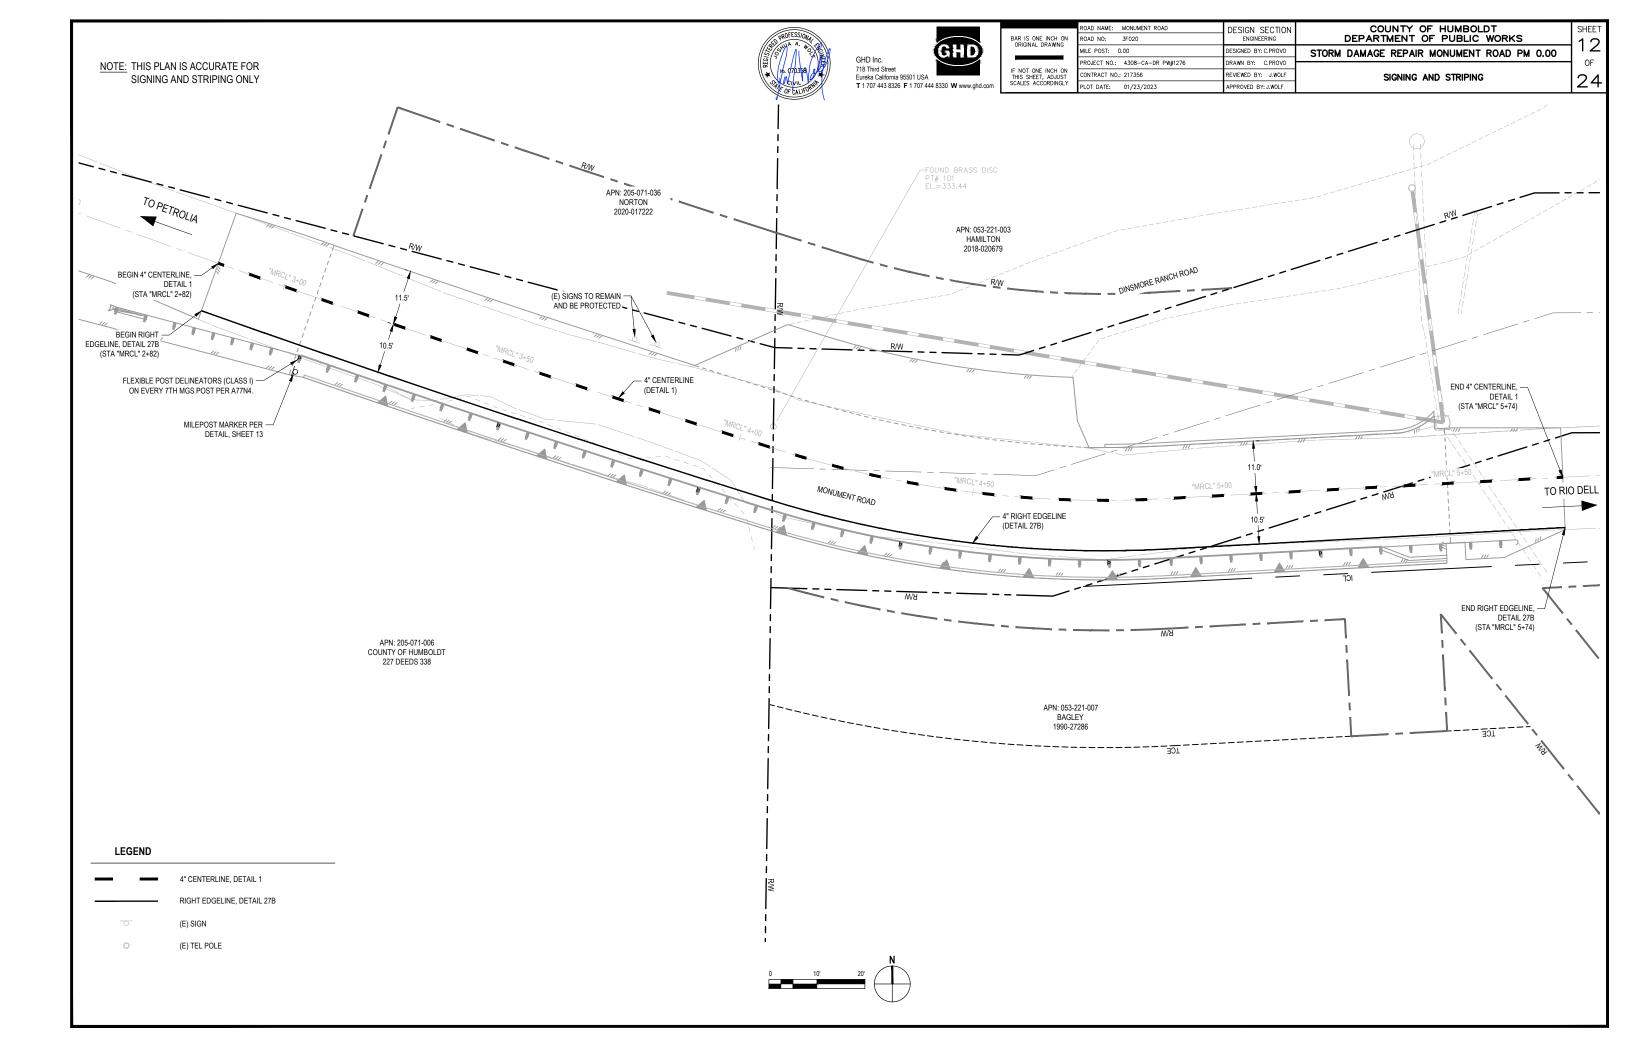










ROAD NO: 3F020	ENGINEERING		
MILE POST: 0.00	DESIGNED BY: C.PROVO		
PROJECT NO.: 4308-CA-DR PW#1276	DRAWN BY: C.PROVO		
CONTRACT NO.: 217356	REVIEWED BY: J.WOLF		
PLOT DATE: 01/23/2023	APPROVED BY: J.WOLF		

ECTION RING	COUNTY OF HUMBOLDT DEPARTMENT OF PUBLIC WORKS	SHE
C.PROVO	STORM DAMAGE REPAIR MONUMENT ROAD PM 0.00	1 -
.PROVO		0
J.WOLF	CONSTRUCTION DETAILS	

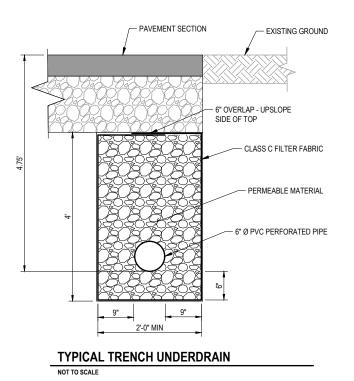

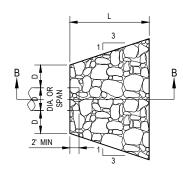

CULVERT SIZE D (inches)	RSP CLASS	LENGTH OF APRON L (feet)	DEPTH OF APRON H (feet)
6	2	6	1.5

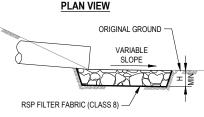


NOTE:

 EXCAVATION FOR PLACEMENT OF RSP WILL NOT BE MEASURED FOR PAYMENT.

SECTION B-B

# **RSP ENERGY DISSIPATOR**

NOT TO SCALE

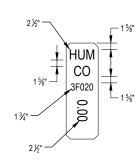



#### NOTES:

- MILEPOST MARKER SIZE PER CALTRANS A73B.
- 2. METAL POST PER CALTRANS A73B.

# HIGHWAY MILEPOST MARKER LETTERING DETAIL


NOT TO SCAL

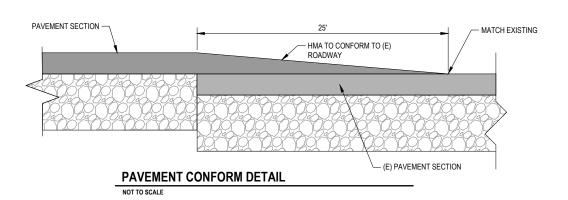

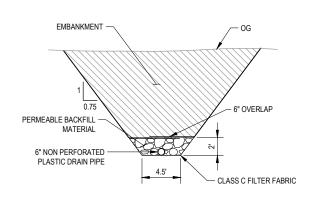

# SUBDRAIN OUTLET DETAIL

NOT TO SCALE

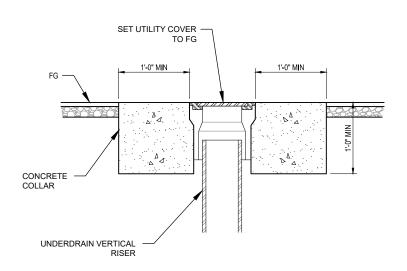

# UNDERDRAIN RISER COVER AND CONCRETE COLLAR DETAIL

NOT TO SCALE




	ROAD NAME:	MONUMENT ROAD
BAR IS ONE INCH ON ORIGINAL DRAWING	ROAD NO:	3F020
ORIGINAL DRAWING	MILE POST: 0	.00
	PROJECT NO.:	4308-CA-DR PW#12
IF NOT ONE INCH ON THIS SHEET, ADJUST	CONTRACT NO.:	217356
SCALES ACCORDINGLY	PLOT DATE:	01/23/2023


UMENT ROAD	DESIGN SECTION	COUNTY OF HUMBOI
20	ENGINEERING	DEPARTMENT OF PUBLIC
	DESIGNED BY: C.PROVO	STORM DAMAGE REPAIR MONUMENT
8-CA-DR PW#1276	DRAWN BY: C.PROVO	
356	REVIEWED BY: J.WOLF	ROADWAY CROSS SECTIONS -
23 /2023	APPROVED BY I WOLF	


COUNTY OF HUMBOLDT
DEPARTMENT OF PUBLIC WORKS


RM DAMAGE REPAIR MONUMENT ROAD PM 0.00

ROADWAY CROSS SECTIONS - 1 OF 3

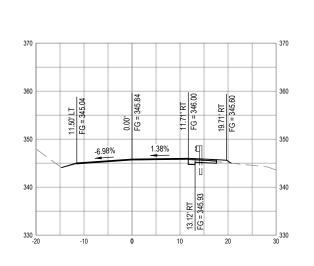

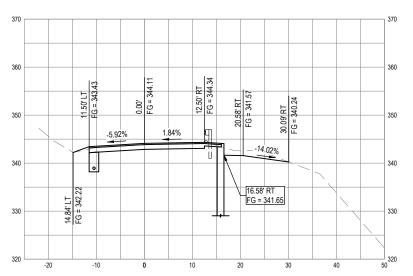

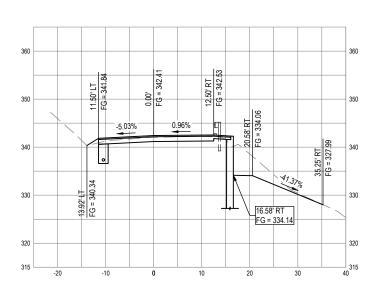

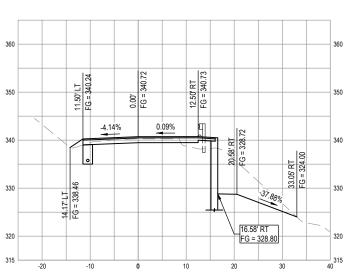



SECTION - STA "MRCL" 3+00


SECTION - STA "MRCL" 3+15

SECTION - STA "MRCL" 3+30

SECTION - STA "MRCL" 3+45

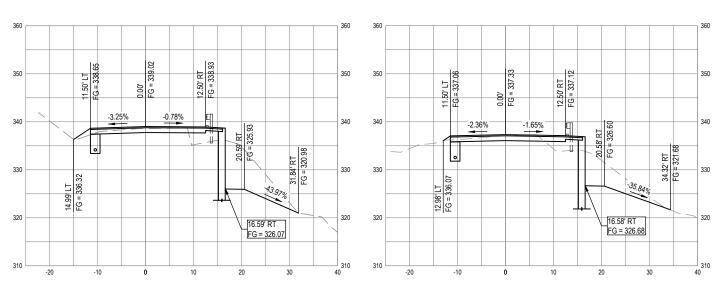

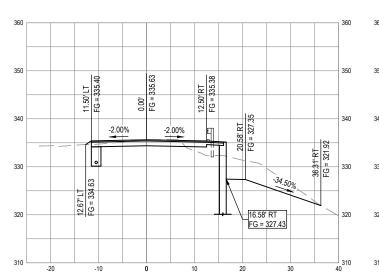

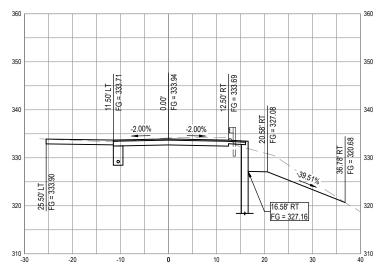

SECTION - STA "MRCL" 3+60

SECTION - STA "MRCL" 3+75

SECTION - STA "MRCL" 3+90

SECTION - STA "MRCL" 4+05





SECTION - STA "MRCL" 4+50


ROAD NAME: MONUMENT ROAD	DESIGN SECTION
ROAD NO: 3F020	ENGINEERING
MILE POST: 0.00	DESIGNED BY: C.PROVO
PROJECT NO.: 4308-CA-DR PW#1276	DRAWN BY: C.PROVO
CONTRACT NO.: 217356	REVIEWED BY: J.WOLF
PLOT DATE: 01/23/2023	APPROVED BY: J.WOLF

COUNTY OF HUMBOLDT DEPARTMENT OF PUBLIC WORKS 15 STORM DAMAGE REPAIR MONUMENT ROAD PM 0.00 24

SHEET


ROADWAY CROSS SECTIONS - 2 OF 3

SECTION - STA "MRCL" 4+65

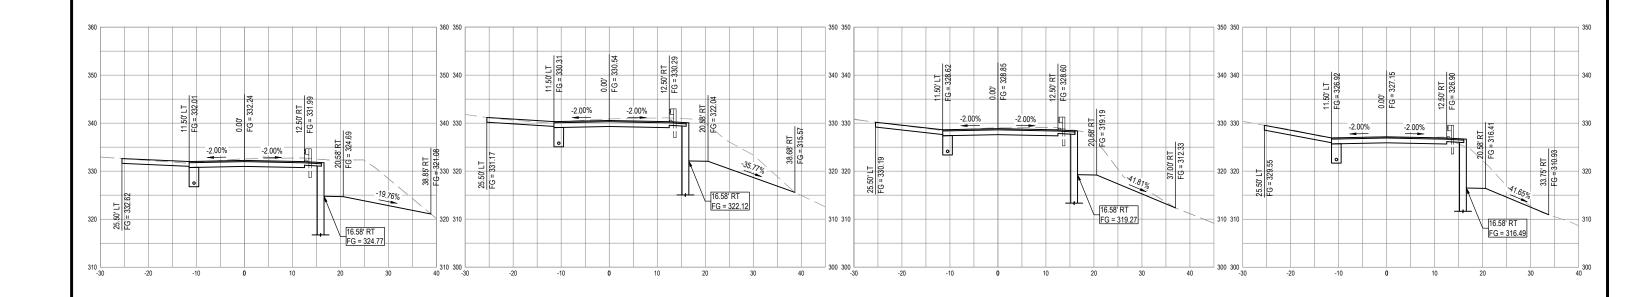

SECTION - STA "MRCL" 4+35

SECTION - STA "MRCL" 4+20

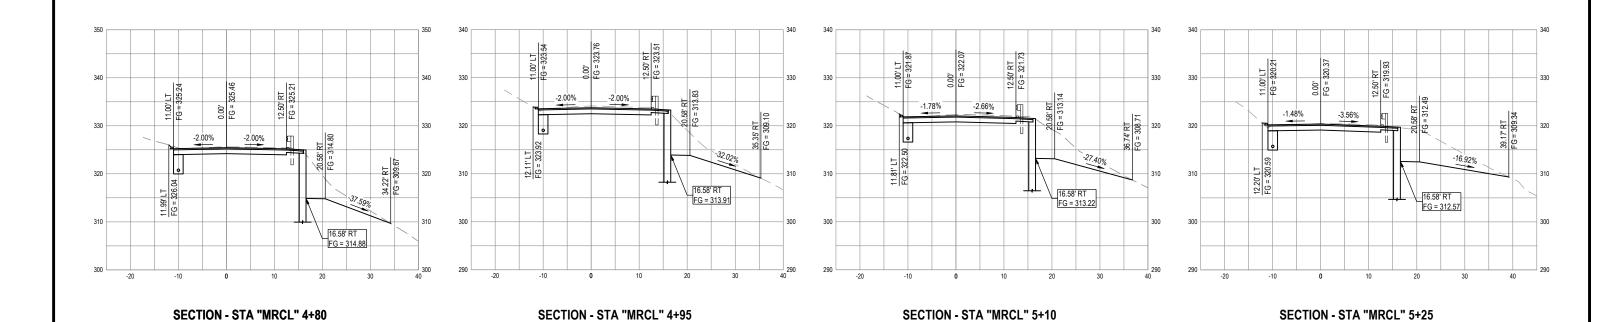



GHD Inc. 718 Third Street Eureka California 95501 USA T 1 707 443 8326 F 1 707 444 8330 W www.ghd.com


IF NOT ONE INCH ON THIS SHEET, ADJUST SCALES ACCORDINGLY


	ROAD NAME: MONUMENT ROAD	DESIGN SECTION	
I ON ING	ROAD NO: 3F020	ENGINEERING	
	MILE POST: 0.00	DESIGNED BY: C.PROVO	
I ON	PROJECT NO.: 4308-CA-DR PW#1276	DRAWN BY: C.PROVO	
	CONTRACT NO.: 217356	REVIEWED BY: J.WOLF	
NGLY	PLOT DATE: 01/23/2023	APPROVED BY: J.WOLF	

STORM DAMAGE REPAIR MONUMENT ROAD PM 0.00

ROADWAY CROSS SECTIONS - 3 OF 3

COUNTY OF HUMBOLDT DEPARTMENT OF PUBLIC WORKS SHEET **16** 

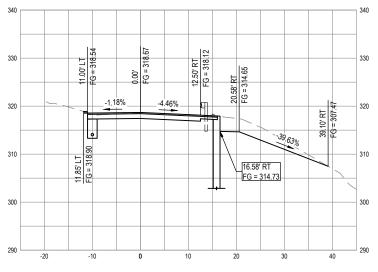

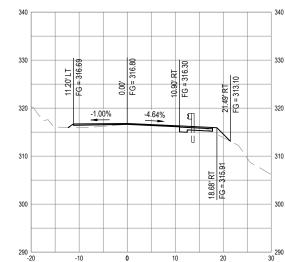

SECTION - STA "MRCL" 5+40

SECTION - STA "MRCL" 5+55



268'-6" CABLE RAILING

RWLOL

© SOLDIER PILE -

-BEGIN SOLDIER

utility, drainage, roadway and layout information not noted.

FG AT ROADWAY

PILE WALL

BEGIN RWLOL 3+12.25 TOW Elev 344.47

BEGIN RWLOL 3+12.25 BOW Elev 336.46

TOP OF WALER~

240'-0" MEASURED ALONG RWLOL

TOP OF WALL

BEYOND

-CABLE RAILING

ORIGINAL DRAWING	
	МІ
	PF
IF NOT ONE INCH ON THIS SHEET, ADJUST	CC
SCALES ACCORDINGLY	PI

- € SOLDIER PILE

END RWLOL 5+52.25 TOW Elev 317.25

ı	ROAD NO: 3F020	ENGINEER	ING
	MILE POST: 0.00	DESIGNED BY:	AWR
	PROJECT NO.: 4308-CA-DR PW#1276	DRAWN BY:	AR
	CONTRACT NO.: 217356	REVIEWED BY:	GJT
1	PLOT DATE: 02/24/2021	APPROVED BY:	AWR

□ DESIGN SECTION

DEPARTMENT OF PUBLIC WORKS

STORM DAMAGE REPAIR MONUMENT ROAD PM 0.00

17


24

RETAINING WALL GENERAL PLAN

	LINE	TABLE
LINE #	LENGTH	DIRECTION
(L2)	58.79′	N 86°55′35" E

				(	CURVE TABL	_E		
CURVE #	BC TA	ANGENT	BEARING	RADIUS	DELTA	TANGENT	LENGTH	EC TANGENT BEARING
(C4)	S 7	0°52′24	l'' E	3227.58′	01°50′12"	51.73′	103.46′	S 72°42′36" E
(C5)	S 7	2°42′36	6" E	239.58′	20°21′50"	43.03′	85.15′	N 86°55′35" E

SOLDIER PILE WALL
TYPICAL SECTION

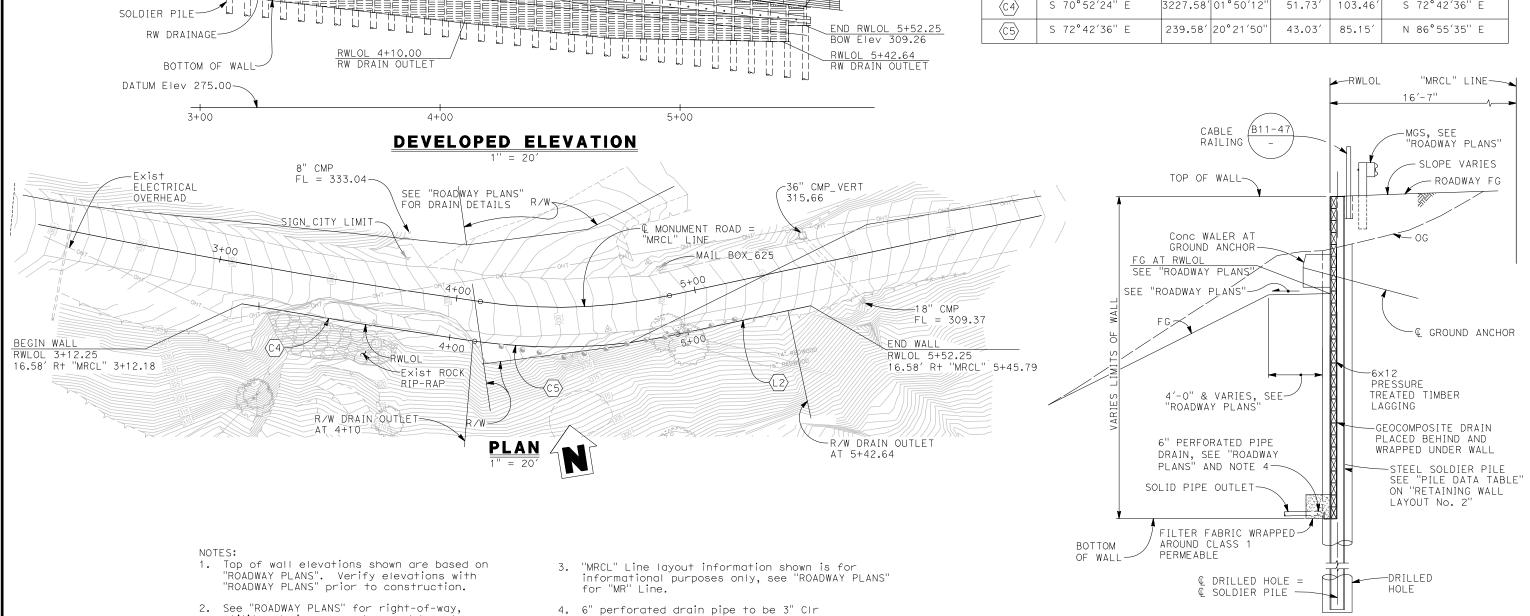

of RWLOL. Slope drain at Min 2%.

END SOLDIER -

FG BEHIND WALL

PILE WALL

AT RWLOL



ORIGINAL DRAWING
IF NOT ONE INCH ON THIS SHEET, ADJUST SCALES ACCORDINGLY

ROAD NO: 3F020	ENGINEER	ING
MILE POST: 0.00	DESIGNED BY:	AWR
PROJECT NO.: 4308-CA-DR PW#1276	DRAWN BY:	AR
CONTRACT NO.: 217356	REVIEWED BY:	GJT
PLOT DATE: 02/24/2021	APPROVED BY:	AWR

DESIGN SECTION

ROAD NAME: MONUMENT ROAD

STORM DAMAGE REPAIR MONUMENT ROAD PM 0.00

18

STRUCTURAL GENERAL NOTES & ABBREVIATIONS 24

COUNTY OF HUMBOLDT

DEPARTMENT OF PUBLIC WORKS

# **GENERAL NOTES** LOAD AND RESISTANCE FACTOR DESIGN

AASHTO LRFD Bridge Design Specifications 8th Edition with Caltrans Amendments, preface dated September 2017

Geotechnical Report by Crawford & Associates, Inc., dated March 19, 2021

REINFORCED

CONCRETE & Reinf:

ASTM Designation:

fy = 60,000 psif'c = 3,600 psi

STRUCTURAL STEEL:

Steel Piles Steel Plates

ASTM Designation: A572/A, A572M Grade 50 Min or A992/A992M GRADE 50 ASTM Designation: ASTM A572/A572M Grade 50

= 500Z psf "INTACT" Material

Welded Concrete Anchors ASTM Designation: A108, AASHTO/AWS D1.1

= 124 pcf

= 40H psf

= 18H psf

= 10,000 psf

= 3.0

AWS D1.1

SOIL PARAMETERS:

UNIT WEIGHT ( )

Active Earth Pressure

Passive Earth Pressure Passive Arching Capability

Seismic Earth Pressure

Max Passive Pressure

LIVE LOAD TIMBER LAGGING: Live Load Surcharge = 250 psf PRESSURE TREATED DOUGLAS FIR No. 1, TIMBER TO BE FULL SAWN

#### PRESTRESSING STEEL:

Bars - ASTM Designation: A722 Type II (150 ksi)

Strand Tendons-ASTM Designation: A416

(270 Ksi Low Relaxation steel)

FDL = Factored Design Load on Ground Anchor (kips)

FTL = Factored Test Load per anchor (Kips) = 1.0 FDL

LL = Lock-off Load (Kips) = 0.55 FDL

fpu = Minimum tensile strength of prestressing steel


= Minimum cross sectional area of prestressing

steel in ground anchor (square inch)


(Strands) As(Min) =0.75 fpu

1.0 FTL (Bars)

For FDL, see "GROUND ANCHOR DATA TABLE" on "RETAINING WALL LAYOUT No. 2" sheet

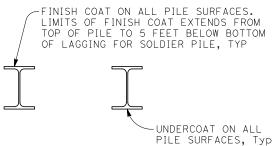

LIMITS OF CLEAN AND PAINT STEEL SOLDIER PILE

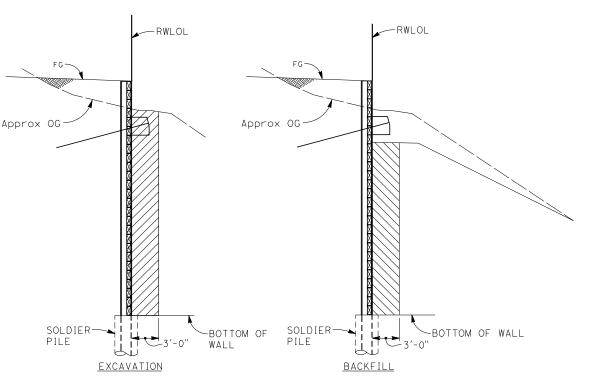

STRUCTURE EXCAVATION (RETAINING WALL) STRUCTURE BACKFILL (SOLDIER PILE WALL)

# SOLDIER PILE WALL

LIMITS OF PAYMENT FOR STRUCTURE **EXCAVATION AND BACKFILL (SOLDIER PILE WALL)** 

# INDEX TO SOLDIER PILE WALL PLANS

SHEET NO.	TITLE
1 7	RETAINING WALL GENERAL PLAN
18	STRUCTURAL GENERAL NOTES & ABBREVIATIONS
19	RETAINING WALL LAYOUT No. 1
20	RETAINING WALL LAYOUT No. 2
21	SOLDIER PILE WALL DETAILS No. 1
22	SOLDIER PILE WALL DETAILS No. 2
23	SOLDIER PILE WALL DETAILS No. 3
24	GROUND ANCHOR DETAILS

# **2022 STANDARD PLANS**

АЗА	ABBREVIATIONS (SHEET 1 OF 3)
АЗВ	ABBREVIATIONS (SHEET 2 OF 3)
A3C	ABBREVIATIONS (SHEET 3 OF 3)
A10A	LEGEND - LINES AND SYMBOLS (SHEET 1 OF 5)
A10B	LEGEND - LINES AND SYMBOLS (SHEET 2 OF 5)
A10C	LEGEND - LINES AND SYMBOLS (SHEET 3 OF 5)
A10D	LEGEND - LINES AND SYMBOLS (SHEET 4 OF 5)
A10E	LEGEND - LINES AND SYMBOLS (SHEET 5 OF 5)
B11-47	CABLE RAILING

# **LEGEND**



# **ABBREVIATIONS**

<u>C</u>	CENTER LINE
BOW	BOTTOM OF WALL
D/S	DOWN STATION
RWLOL	RETAINING WALL LAYOUT LINE
TOW	TOP OF WALL
U/S	UP STATION



ORIGINAL DRAWING	
IF NOT ONE INCH ON THIS SHEET, ADJUST SCALES ACCORDINGLY	

ROAD NAME: MONUMENT ROAD ROAD NO: 3F020	DESIGN SECTION ENGINEERING
MILE POST: 0.00	DESIGNED BY: AWR
PROJECT NO.: 4308-CA-DR PW#1276	DRAWN BY: AR
CONTRACT NO.: 217356	REVIEWED BY: GJT
PLOT DATE: 02/24/2021	APPROVED BY: AWR

COUNTY OF HUMBOLDT DEPARTMENT OF PUBLIC WORKS

19 STORM DAMAGE REPAIR MONUMENT ROAD PM 0.00 24


RETAINING WALL LAYOUT No. 1

## LEGEND:

- ① Indicates Soldier Pile No., see "PILE DATA TABLE" on "RETAINING WALL LAYOUT No. 2" sheet.
- A Indicates GROUND ANCHOR TYPE, SEE "GROUND ANCHOR DATA TABLE" on "RETAINING WALL LAYOUT No. 2" sheet.

#### NOTE:

1. Top of wall elevations shown are based on "ROADWAY PLANS", verify elevations with "ROADWAY PLANS" prior to construction.

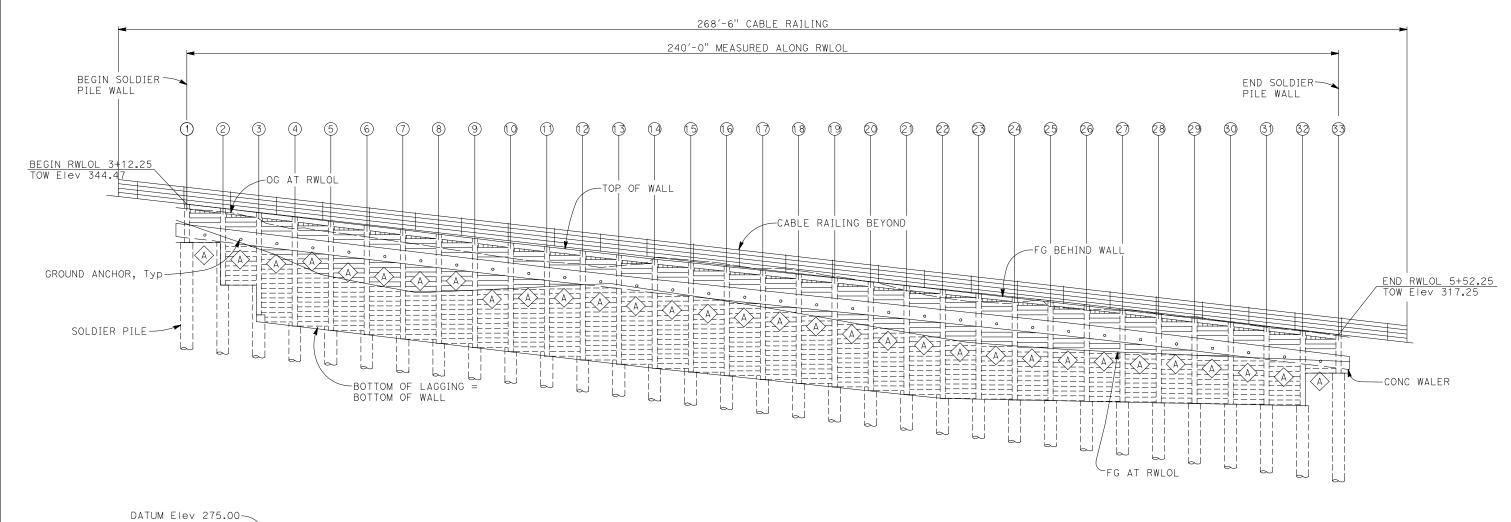



# **DEVELOPED ELEVATION - PILE LAYOUT**



BIGGS CARDOSA ASSOCIATES INC STRUCTURAL ENGINEERS 1111 Broadway, Ste. 1510 Oakland, California 94607 510–625–9900

BAR IS ONE INCH ON ORIGINAL DRAWING	ROAD NO: 3F020
ORIGINAL DRAWING	MILE POST: 0.00
	PROJECT NO.: 4308-CA-DR
F NOT ONE INCH ON THIS SHEET, ADJUST	CONTRACT NO.: 217356
CALES ACCORDINGLY	PLOT DATE: 02/24/2021

ROAD NAME: MONUMENT ROAD

DESIGN SECTION ENGINEERING DESIGNED BY: AWR -CA-DR PW#1276 DRAWN BY: AR REVIEWED BY: GJT

APPROVED BY: AWR

STORM DAMAGE REPAIR MONUMENT ROAD PM 0.00

COUNTY OF HUMBOLDT DEPARTMENT OF PUBLIC WORKS

20 24

RETAINING	WALL	LAYOUT	No.	2	

				PILE DAT	TA TABLE				
PILE #	RWLOL STATION (FT)	PILE SECTION (FT)	TOP OF WALL ELEVATION (FT), SEE NOTE 1	DRILLED HOLE SIZE (IN)	PILE CUTOFF ELEVATION (FT)	BOTTOM OF WALL ELEVATION (FT), SEE  D/S	BOTTOM OF WALL ELEVATION (FT), SEE U/S	PILE LENGTH (FT)	PILE TIP ELEVATION (FT)
(1)	3+12.25	W18×106	344.47	30.00	344.47	-	336.21	46.0	298.47
2	3+19.75	W18×106	343.62	30.00	343.62	336.21	329.62	46.0	297.62
3	3+27.25	W18×106	342.77	30.00	342.77	329.62	319.77	46.0	296.77
4	3+34.75	W18×106	341.92	30.00	341.92	319.77	318.92	46.0	295.92
5	3+42.25	W18×106	341.07	30.00	341.07	318.92	318.07	46.0	295.07
6	3+49.75	W18×106	340.22	30.00	340.22	318.07	317.22	46.0	294.22
7	3+57.25	W18×106	339.37	30.00	339.37	317.22	316.37	46.0	293.37
8	3+64.75	W18×106	338.52	30.00	338.52	316.37	315.52	46.0	292.52
9	3+72.25	W18×106	337.67	30.00	337.67	315.52	314.67	46.0	291.67
0	3+79.75	W18×106	336.82	30.00	336.82	314.67	313.82	46.0	290.82
(1)	3+87.25	W18×106	335.97	30.00	335.97	313.82	312.97	46.0	289.97
(2)	3+94.75	W18×106	335.12	30.00	335.12	312.97	312.12	46.0	289.12
(3)	4+02.25	W18×106	334.27	30.00	334.27	312.12	311.27	46.0	288.27
(4)	4+09.75	W18×106	333.41	30.00	333.41	311.27	310.41	46.0	287.41
15	4+17.25	W18×106	332.56	30.00	332.56	310.41	309.56	46.0	286.56
16	4+24.75	W18×106	331.71	30.00	331.71	309.56	308.71	46.0	285.71
0	4+32.25	W18×106	330.86	30.00	330.86	308.71	307.86	46.0	284.86
13	4+39.75	W18×106	330.01	30.00	330.01	307.86	307.01	46.0	284.01
19	4+47.25	W18×106	329.16	30.00	329.16	307.01	306.16	46.0	283.16
20	4+54.75	W18×106	328.31	30.00	328.31	306.16	305.31	46.0	282.31
2	4+62.25	W18×106	327.46	30.00	327.46	305.31	304.46	46.0	281.46
23	4+69.75	W18×106	326.61	30.00	326.61	304.46	304.46	46.0	280.61
<b>3</b>	4+77.25	W18×106	325.76	30.00	325.76	304.46	304.46	46.0	279.76
29	4+84.75	W18×106	324.91	30.00	324.91	304.46	304.46	46.0	278.91
29	4+92.25	W18×106	324.06	30.00	324.06	304.46	304.46	46.0	278.06
26	4+99.75	W18×106	323.20	30.00	323.20	304.46	304.46	46.0	277.20
2	5+07.25	W18×106	322.35	30.00	322.35	304.46	304.46	46.0	276.35
28	5+14.75	W18×106	321.50	30.00	321.50	304.46	304.46	46.0	275.50
29	5+22.25	W18×106	320.65	30.00	320.65	304.46	304.46	46.0	274.65
30	5+29.75	W18×106	319.80	30.00	319.80	304.46	304.46	46.0	273.80
3)	5+37.25	W18×106	318.95	30.00	318.95	304.46	304.46	46.0	272.95
33	5+44.75	W18×106	318.10	30.00	318.10	304.46	309.26	46.0	272.10
(3)	5+52.25	W18×106	317.25	30.00	317.25	309.26	_	46.0	271.25

.50	
.65	FG AT RWLOL, SEE "ROADWAY PLANS"
.80	PLANS"
.95	<b></b>
.10	
.25	
	F SOLDIER PILE  BOTTOM OF WALL  U/S
	<b>DETAIL</b> 1/2" = 1'-0"

# **GROUND ANCHOR** DATA TABLE

<b>–</b>	AIA IADI	<b></b>
GROUND ANCHOR TYPE	FACTORED DESIGN LOAD, FDL (kips)	MINIMUM UNBONDED LENGTH (FT) SEE NOTE 2
Á	214	26'-0"

1. Top of Wall elevations shown are based on "ROADWAY PLANS", verify elevations with "ROADWAY PLANS" prior to construction. Notify Engineer if top of wall elevations are higher than shown on plans.

2. Per the Geotechnical report by Crawford & Associates, Inc., dated March 19, 2021, the ground anchor unbonded length shall extend at least 5 feet or H/5, whichever is greater (H = wall Height) beyond the "intact" material.

PILE CUTOFF ELEVATION = TOP OF LAGGING

-TOP OF WALL = ROADWAY FG

LEGEND:

Indicates Soldier Pile No., see "PILE DATA TABLE"



ROAD NAME: MONUMENT ROAD DESIGN SECTION ENGINEERING ROAD NO: 3F020 MILE POST: 0.00 DESIGNED BY: AWR PROJECT NO.: 4308-CA-DR PW#1276 DRAWN BY: AR CONTRACT NO.: 217356 REVIEWED BY: GJT PLOT DATE: 02/24/2021 APPROVED BY: AWR


COUNTY OF HUMBOLDT DEPARTMENT OF PUBLIC WORKS STORM DAMAGE REPAIR MONUMENT ROAD PM 0.00

SOLDIER PILE WALL DETAILS No.1

21 24

SHEET


1. For "PILE DATA TABLE", see "RETAINING WALL LAYOUT No. 2" sheet.

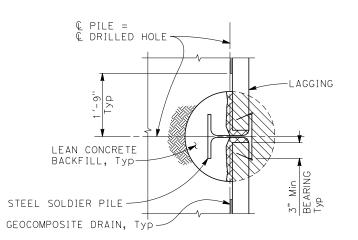


# SECTION AT LAGGING

LEAN CONCRETE TO BE CHIPPED AWAY AS REQUIRED FOR LAGGING INSTALLATION

LIMITS OF FILL WITH STRUCTURAL BACKFILL AFTER LAGGING INSTALLATION

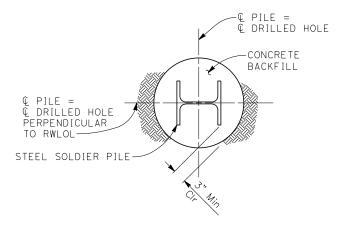

SECTION AT DRILLED HOLE

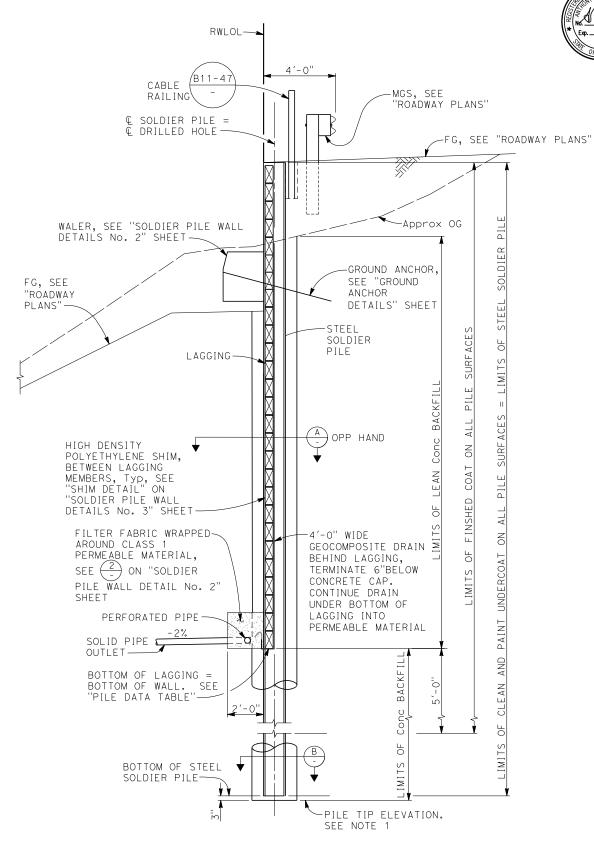

SOLDIER PILE WALL

TYPICAL SECTION



ORIGINAL DRAWING	ŀ
IF NOT ONE INCH ON	
THIS SHEET, ADJUST	ŀ

ROAD NAME: MONUMENT ROAD	DESIGN SECTION
ROAD NO: 3F020	ENGINEERING
MILE POST: 0.00	DESIGNED BY: AWR
PROJECT NO.: 4308-CA-DR PW#1276	DRAWN BY: AR
CONTRACT NO.: 217356	REVIEWED BY: GJT
PLOT DATE: 02/24/2021	APPROVED BY: AWR

NOTES:

STORM DAMAGE REPAIR MONUMENT ROAD PM 0.00


SOLDIER PILE WALL DETAILS No. 2

COUNTY OF HUMBOLDT DEPARTMENT OF PUBLIC WORKS


SHEET

22

24

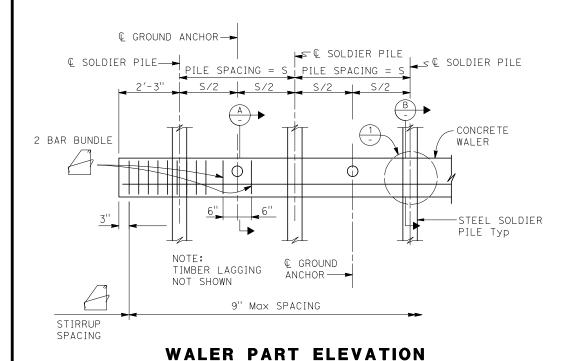

NO SCALE

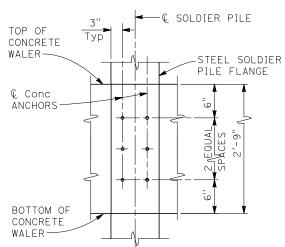



 $1 \ 1/2'' = 1'-0''$ 


2. Concrete walers may be poured to face of lagging.


1. For concrete water location, see "DEVELOPED ELEVATION"

- 3. Bearing plates may be recessed or on face of concrete waler.
- 4. No clipping of timber lagging corners allowed.
- 5. Use 40d Galv wire spikes for 6x12 lagging.

shown on "GENERAL PLAN" sheet.

- 6. Spikes shall not be bent.
- 7. Place stirrups  $1\frac{1}{2}$ " clear of anchorage tube.

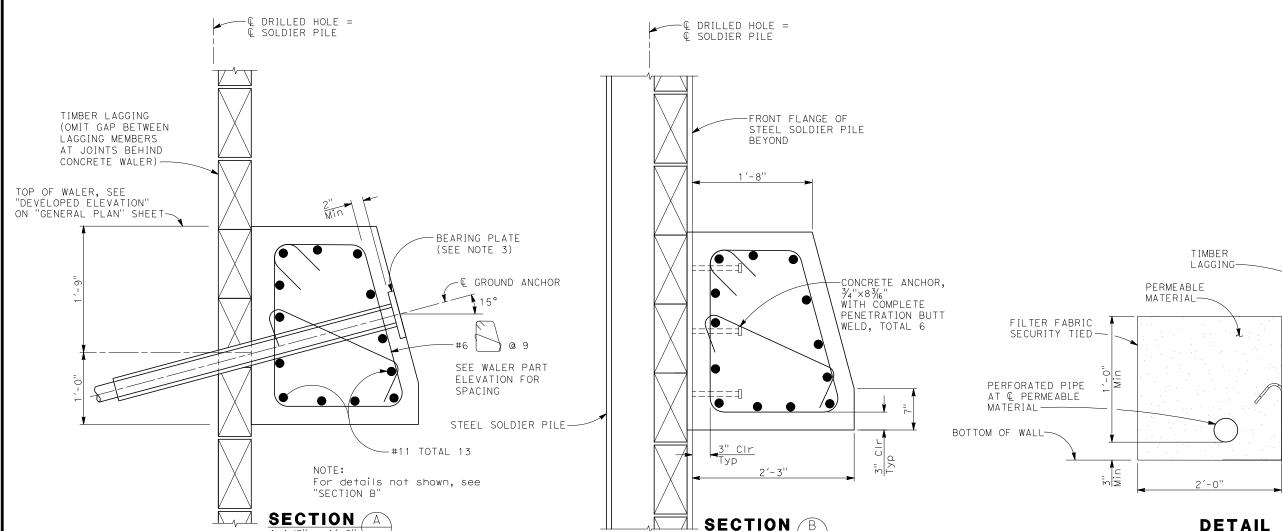

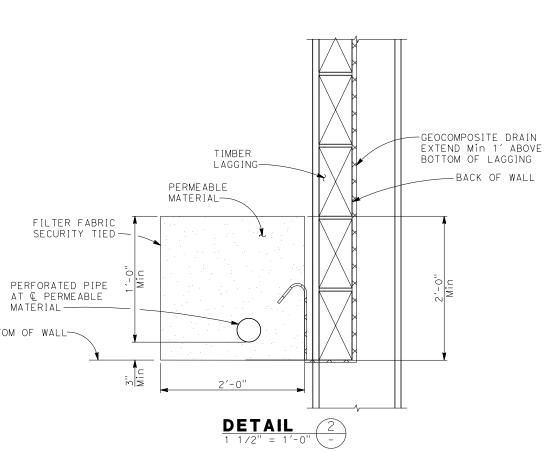



PLACE TOP LEVEL OF LAGGING PARALLEL TO TOP OF WALL

GALVANIZED SPIKES, Typ-

- & SOLDIER PILE

BAR IS ONE INCH ON ORIGINAL DRAWING
IF NOT ONE INCH ON THIS SHEET, ADJUST SCALES ACCORDINGLY

SECTION (A

ı	ROAD NO: 3F020	ENGINEERING	
	MILE POST: 0.00	DESIGNED BY: AWR	
	PROJECT NO.: 4308-CA-DR PW#1276	DRAWN BY: SMH	
	CONTRACT NO.: 217356	REVIEWED BY: GJT	
1	PLOT DATE: 02/24/2021	APPROVED BY: AWR	

-----

DESIGN SECTION

— € SOLDIER PILE


- VERTICAL LAGGING

ROAD NAME: MONUMENT ROAD

STORM DAMAGE REPAIR MONUMENT ROAD PM 0.00 SOLDIER PILE WALL DETAILS No. 3

COUNTY OF HUMBOLDT DEPARTMENT OF PUBLIC WORKS


SHEET 23 24

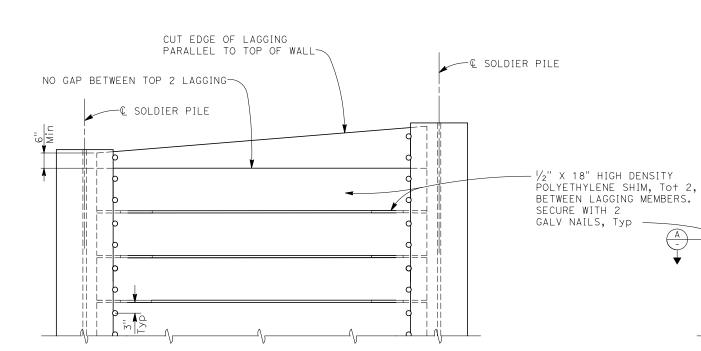

# PART ELEVATION

# LAGGING DETAILS (ALTERNATIVE 1)

NO SCALE

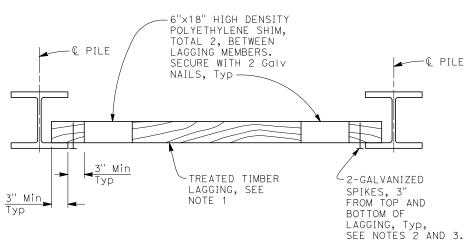

# PART PLAN NO SCALE

NOTES:

- No clipping of timber lagging corners allowed
   Use 16d Galv wire spikes for 4 x 12 lagging, and 40d Galv wire spikes for 6 x 12 lagging
- 3. Spikes shall not be bent

