
FUNDING SOURCE

THIS PROJECT IS FUNDED BY THE US DEPARTMENT OF TRANSPORTATION, FEDERAL HIGHWAY ADMINISTRATION EMERGENCY RELIEF PROGRAM



COUNTY OF HUMB DEPARTMENT WORKS PUR CONSTRUCTION OF PROJECT PLANS FØR STORM DAMAGE REPAIRS ON **BELL SPRINGS ROAD (8A010)** at P.M. 2.20 & 4.96 ER-32L0[127] & ER-32L0[128] **CONTRACT NO. 217267 & 217268**

SITE	CONTRACT No.	LAT & LONG
PM 2.20	217267	40.02534, -123.6315
PM 4.96	217268	40.05891, -123.64080

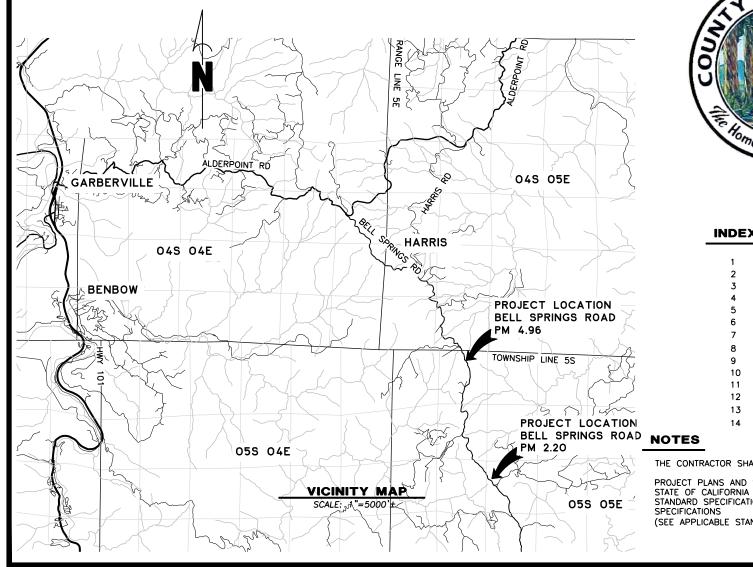



NAME: BELL SPRINGS ROAD

ITRACT NO.: 217267 & 217268

2/26/2025

OAD NO: 8A010

BAR IS ONE INCH ON

IF NOT ONE INCH O THIS SHEET, ADJUS SCALES ACCORDING




1	COVER SHEET, SHEET INDEX, AND MAPS
2	CONSTRUCTION AREA SIGNS & QUANTITIES
3	PM 2.20 SURVEY CONTROL
4	PM 2.20 TYPICAL SECTION AND DETAILS
5	PM 2.20 PLAN AND PROFILE
6	PM 2.20 EROSION CONTROL
7	PM 2.20 SECTION VIEWS (1 OF 2)
8	PM 2.20 SECTION VIEWS (2 OF 2)
9	PM 4.96 SURVEY CONTROL
10	PM 4.96 TYPICAL SECTION AND DETAILS
11	PM 4.96 PLAN AND PROFILE
12	PM 4.96 EROSION CONTROL
13	PM 4.96 SECTION VIEWS (1 OF 2)
14	PM 4.96 SECTION VIEWS (2 OF 2)




PROJECT PLANS AND SPECIAL PROVISIONS TO BE SUPPLEMENTED BY THE STATE OF CALIFORNIA DEPARTMENT OF TRANSPORTATION STANDARD PLANS, STANDARD SPECIFICATIONS, AND THE LATEST REVISED 2024 STANDARD

(SEE APPLICABLE STANDARD PLAN LIST IN SPECIAL PROVISIONS)

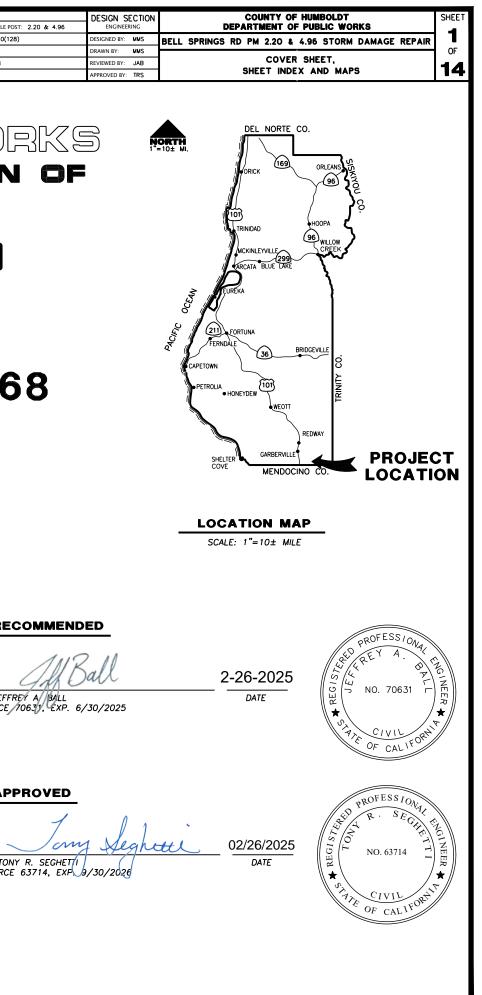

APPROVED



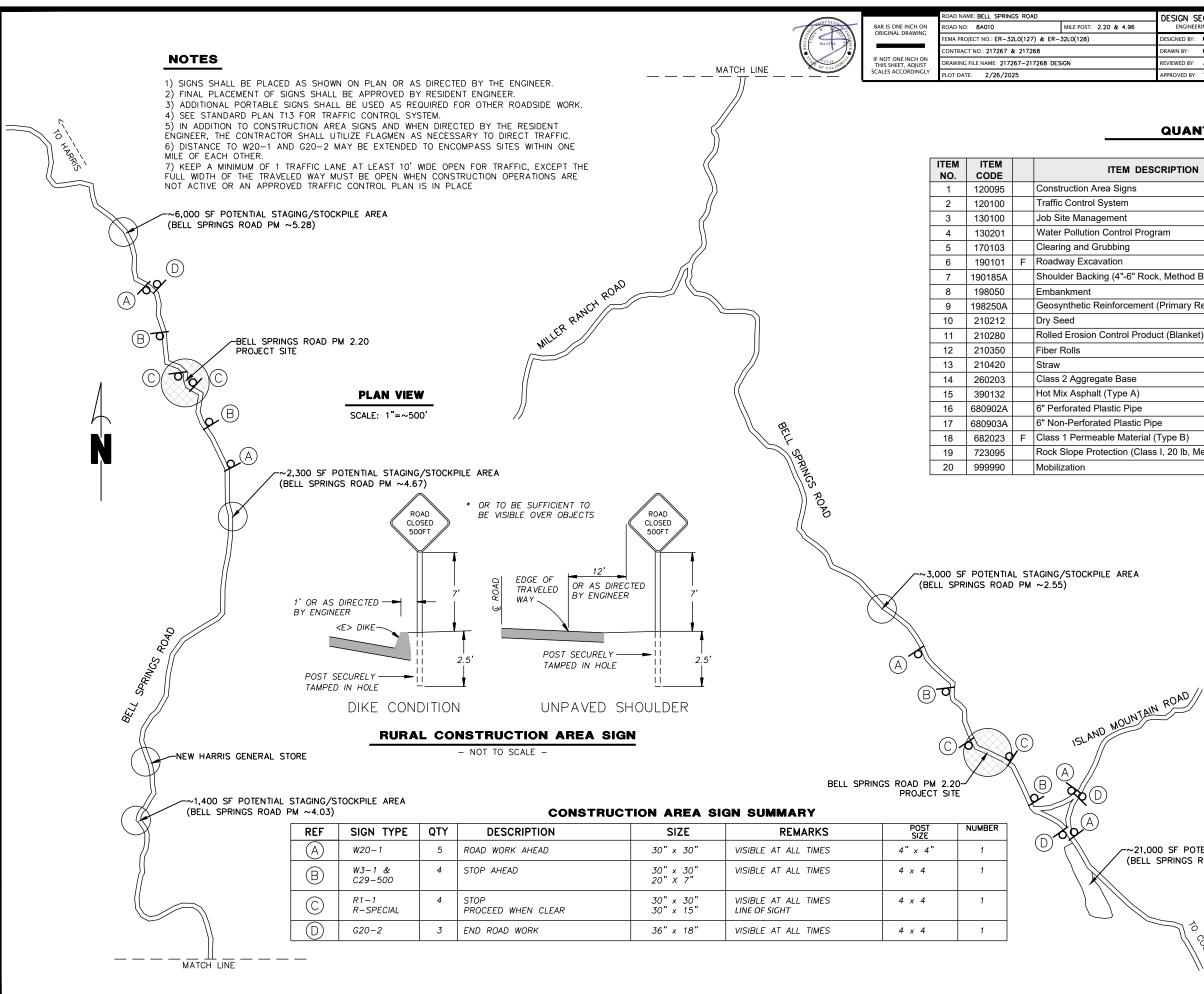

DESIGN SECTION ENGINEERING	COUNTY OF HUMBOLDT DEPARTMENT OF PUBLIC WORKS				
DESIGNED BY: MMS	BELL SPRINGS RD PM 2.20 & 4.96 STORM DAMAGE REPAIR	2			
DRAWN BY: MMS		OF			
REVIEWED BY: JAB	SIGNS, VICINITY MAP, AND QUANTITIES	4 /			
APPROVED BY: TRS		14			

QUANTITIES

UNIT	PM 2.20	PM 4.96	Total
EA	9	7	16
LS	0.5	0.5	1
LS	0.5	0.5	1
LS	0.5	0.5	1
LS	0.5	0.5	1
CY	560	490	1,050
CY	16	5	21
CY	346	309	655
SQYD	1,042	955	1,997
SQFT	1,800	1,030	2,830
SQFT	1,680	1,030	2,710
LF	490	175	665
SQFT	120	0	120
CY	140	93	233
TON	71	48	119
LF	100	100	200
LF	32	27	59
CY	36	29	65
CY	1	1	2
LS	0.5	0.5	1
	EA LS LS CY CY CY SQYD SQFT SQFT LF SQFT CY TON LF LF CY CY CY	EA 9 LS 0.5 CY 560 CY 16 CY 346 SQYD 1,042 SQFT 1,680 LF 490 SQFT 120 CY 140 TON 71 LF 100 LF 32 CY 36 CY 1	EA 9 7 LS 0.5 0.5 CY 560 490 CY 16 5 CY 346 309 SQYD 1,042 955 SQFT 1,800 1,030 SQFT 1,680 1,030 LF 490 175 SQFT 120 0 CY 140 93 TON 71 48 LF 100 100 LF 32 27 CY 36 29 CY 1 1


STOCKPILE NOTES

1) MANAGE MATERIAL PER SECTION 13-4.03 (C) OF THE 2024 CALTRANS STANDARD SPECIFICATIONS

2) IF STOCKPILE AREA IS IN A TURNOUT- THE TURNOUT SHALL BÉ REESTABLISHED TO PRE-CONSTRUCTION CONDITIONS


3) STOCKPILE LOCATIONS HAVE BEEN APPROVED BY PUBLIC WORKS AS DETAILED IN THE ENVIRONMENTAL REPORT.


~21,000 SF POTENTIAL STAGING/STOCKPILE AREA (BELL SPRINGS ROAD PM ~1.75)

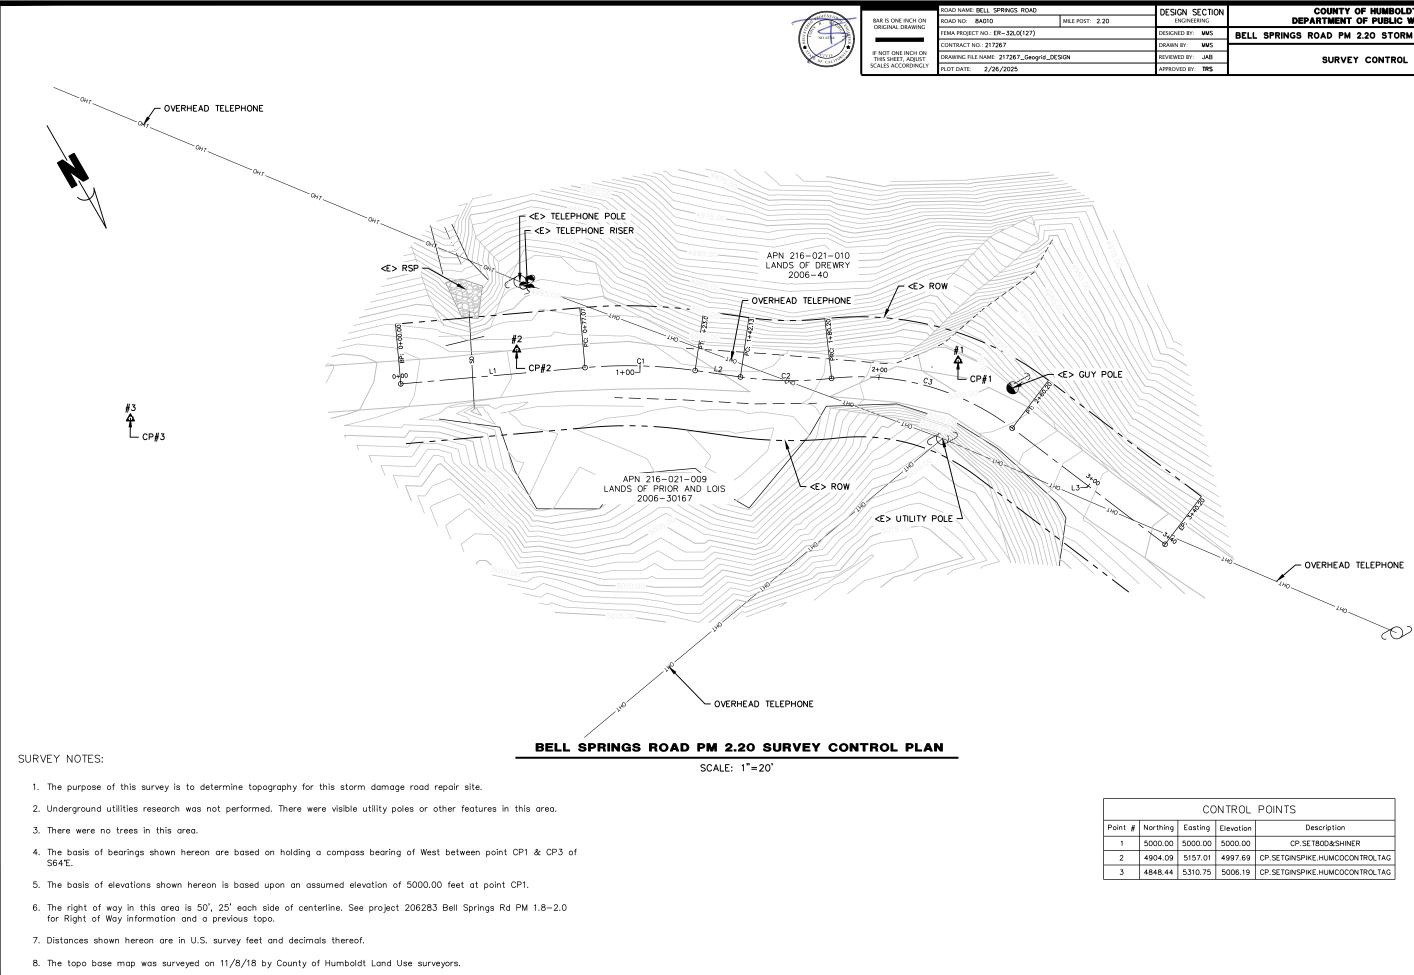

DESIGN SECTION ENGINEERING	COUNTY OF HUMBOLDT DEPARTMENT OF PUBLIC WORKS			
DESIGNED BY: MMS	BELL SPRINGS ROAD PM 2.20 STORM DAMAGE REPAIR	3		
DRAWN BY: MMS		OF		
REVIEWED BY: JAB	SURVEY CONTROL	4 4		
APPROVED BY: TRS		14		

CONTROL POINTS							
orthing	Easting	Elevation	Description				
00.00	5000.00	5000.00	CP.SET80D&SHINER				
904.09	5157.01	4997.69	CP.SETGINSPIKE.HUMCOCONTROLTAG				
848.44	5310.75	CP.SETGINSPIKE.HUMCOCONTROLTAG					

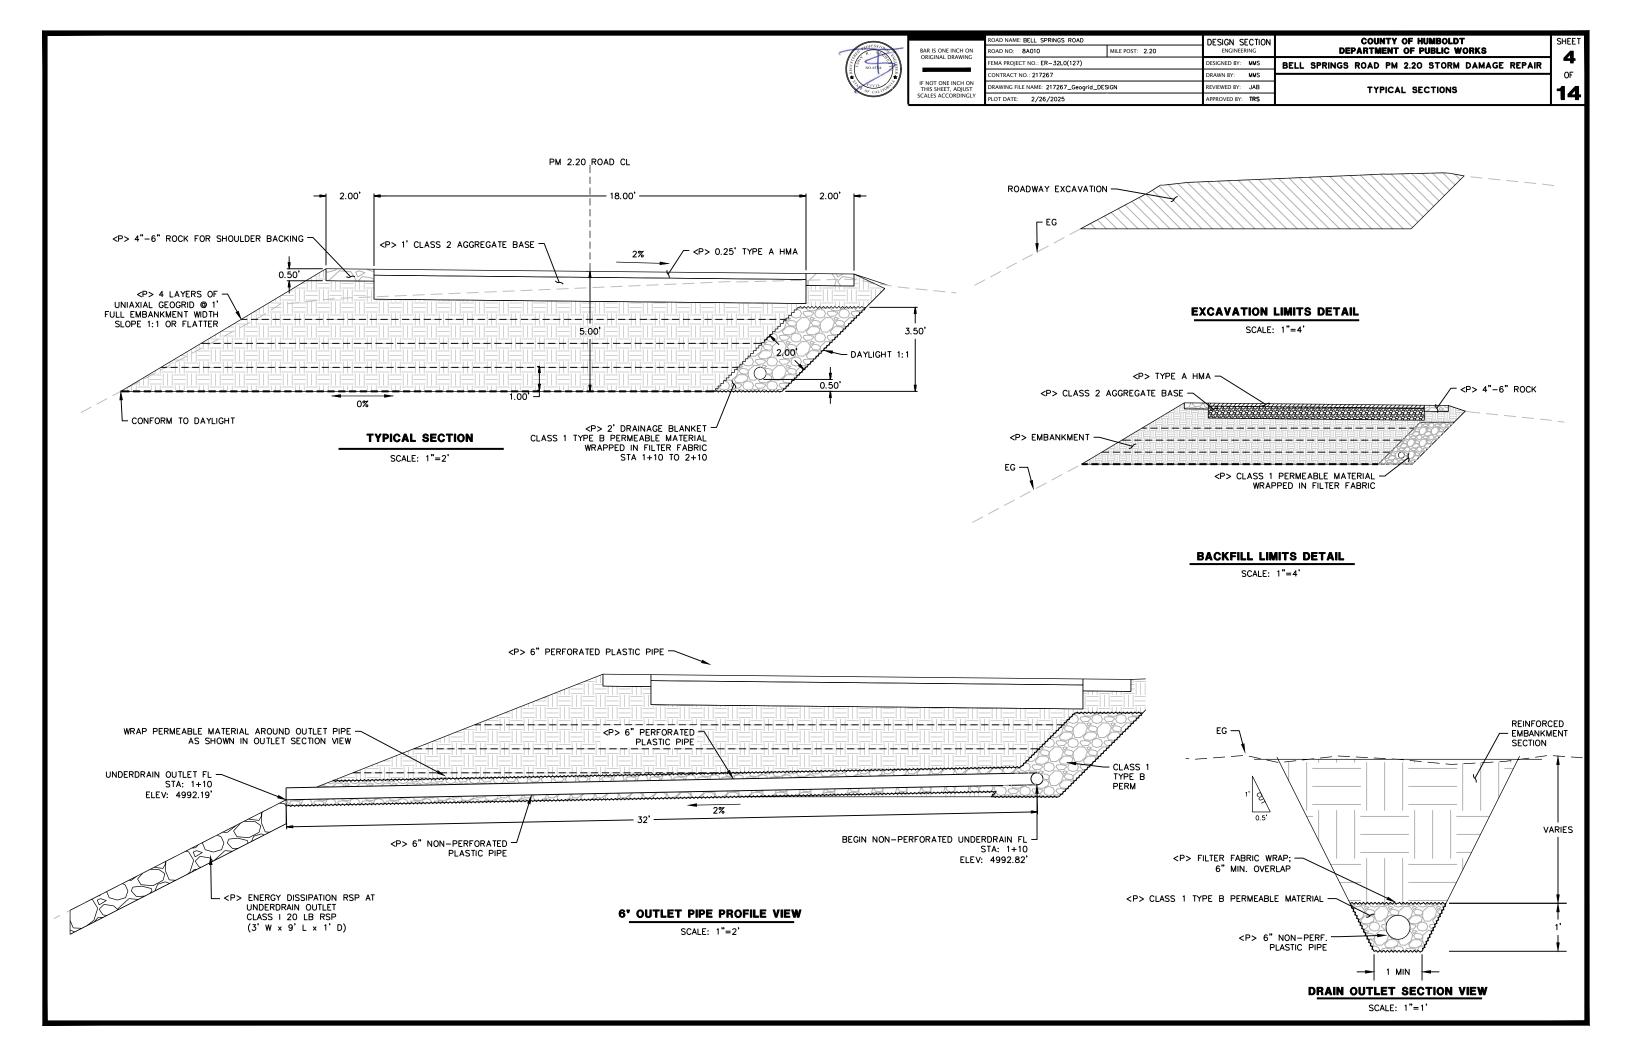

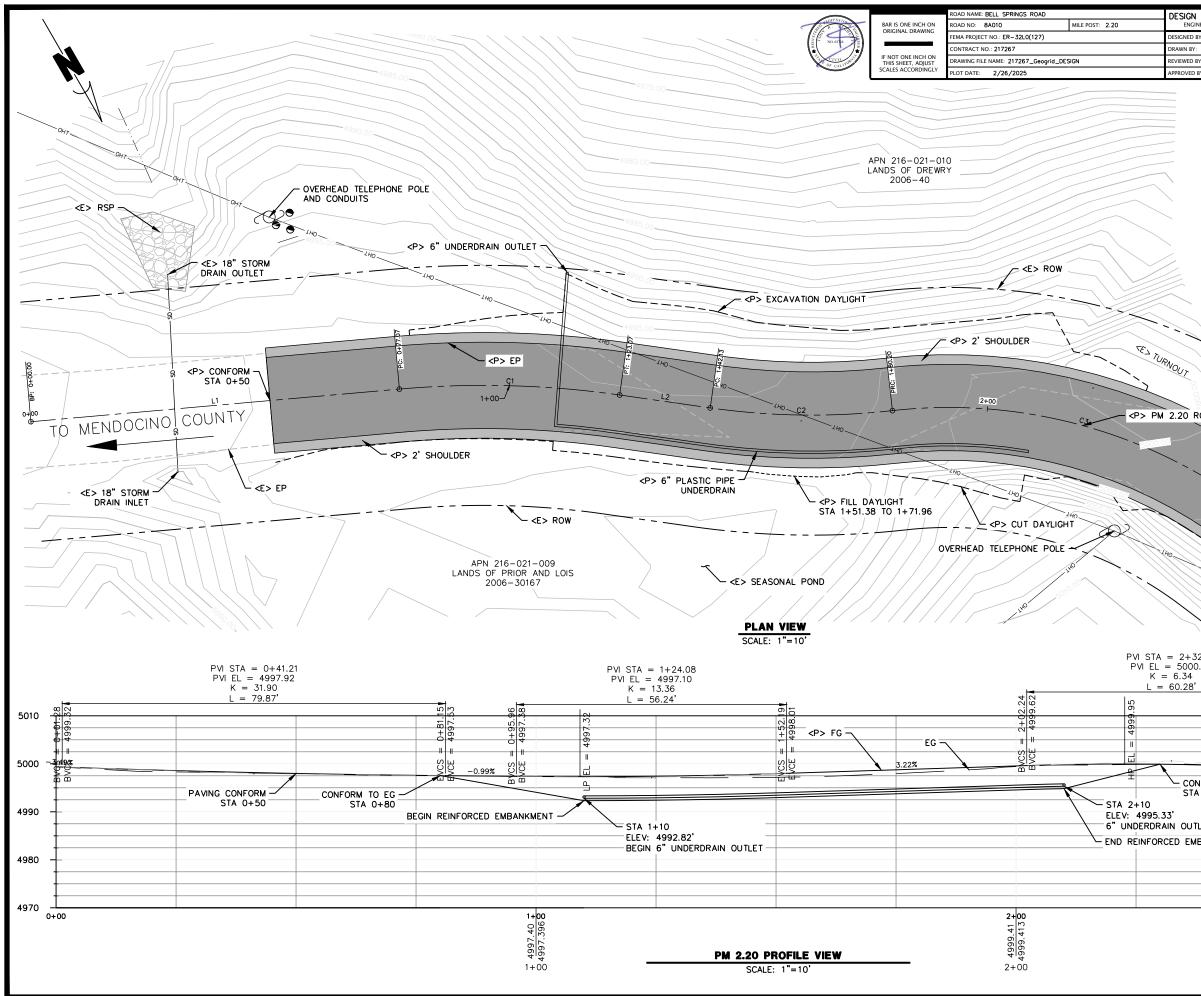



DESIGN SECTION ENGINEERING	COUNTY OF HUMBOLDT DEPARTMENT OF PUBLIC WORKS			
DESIGNED BY: MMS	BELL SPRINGS ROAD PM 2.20 STORM DAMAGE REPAIR	5		
DRAWN BY: MMS		OF		
REVIEWED BY: JAB	PLAN AND PROFILE	4 /		
APPROVED BY: TRS		14		


		PM 2.20 F	ROAD	CL ALIG	NMENT	
SEGMENT	LENGTH	BEARING/DELTA	RADIUS	TANGENT	START	END
L1	77.07'	N65'03'28"W			STA: 0+00.00 N: 4892.31 E: 5205.99	STA: 0+77.07 N: 4924.80 E: 5136.12
 C1	46.00'	013*10'42"	200.00'	23.10'	STA: 0+77.07 N: 4924.80 E: 5136.12	STA: 1+23.07 N: 4948.81 E: 5096.99
L2	19.06'	N51*52'47"W			STA: 1+23.07 N: 4948.81 E: 5096.99	STA: 1+42.13 N: 4960.58 E: 5082.00
 C2	38.07'	014•32'33"	150.00'	19.14'	STA: 1+42.13 N: 4960.58 E: 5082.00	STA: 1+80.20 N: 4980.05 E: 5049.40
C3	80.00'	043*39'14"	105.00'	42.05'	STA: 1+80.20 N: 4980.05 E: 5049.40	STA: 2+60.20 N: 5035.64 E: 4994.58
L3	80.00'	N22 * 46'05"W			STA: 2+60.20 N: 5035.64 E: 4994.58	STA: 3+40.20 N: 5109.41 E: 4963.62


<P> PM 2.20 ROAD CL <E> GUY POLE <P> CONFORM STA 2+60 \mathcal{F} HARPIS L3— PVI STA = 2+32.37PVI EL = 5000.59 K = 6.34PVI STA = 3+08.66PVI EL = 4995.79K = 15.70L = 48.55L = 60.28'8.70 3+32.93↓ 4995.02 5010 404 5000 - CONFORM TO EG m - PAVING CONFORM STA 2+30 4990 6" UNDERDRAIN OUTLET FL - END REINFORCED EMBANKMENT 4980


> 4970 3+00

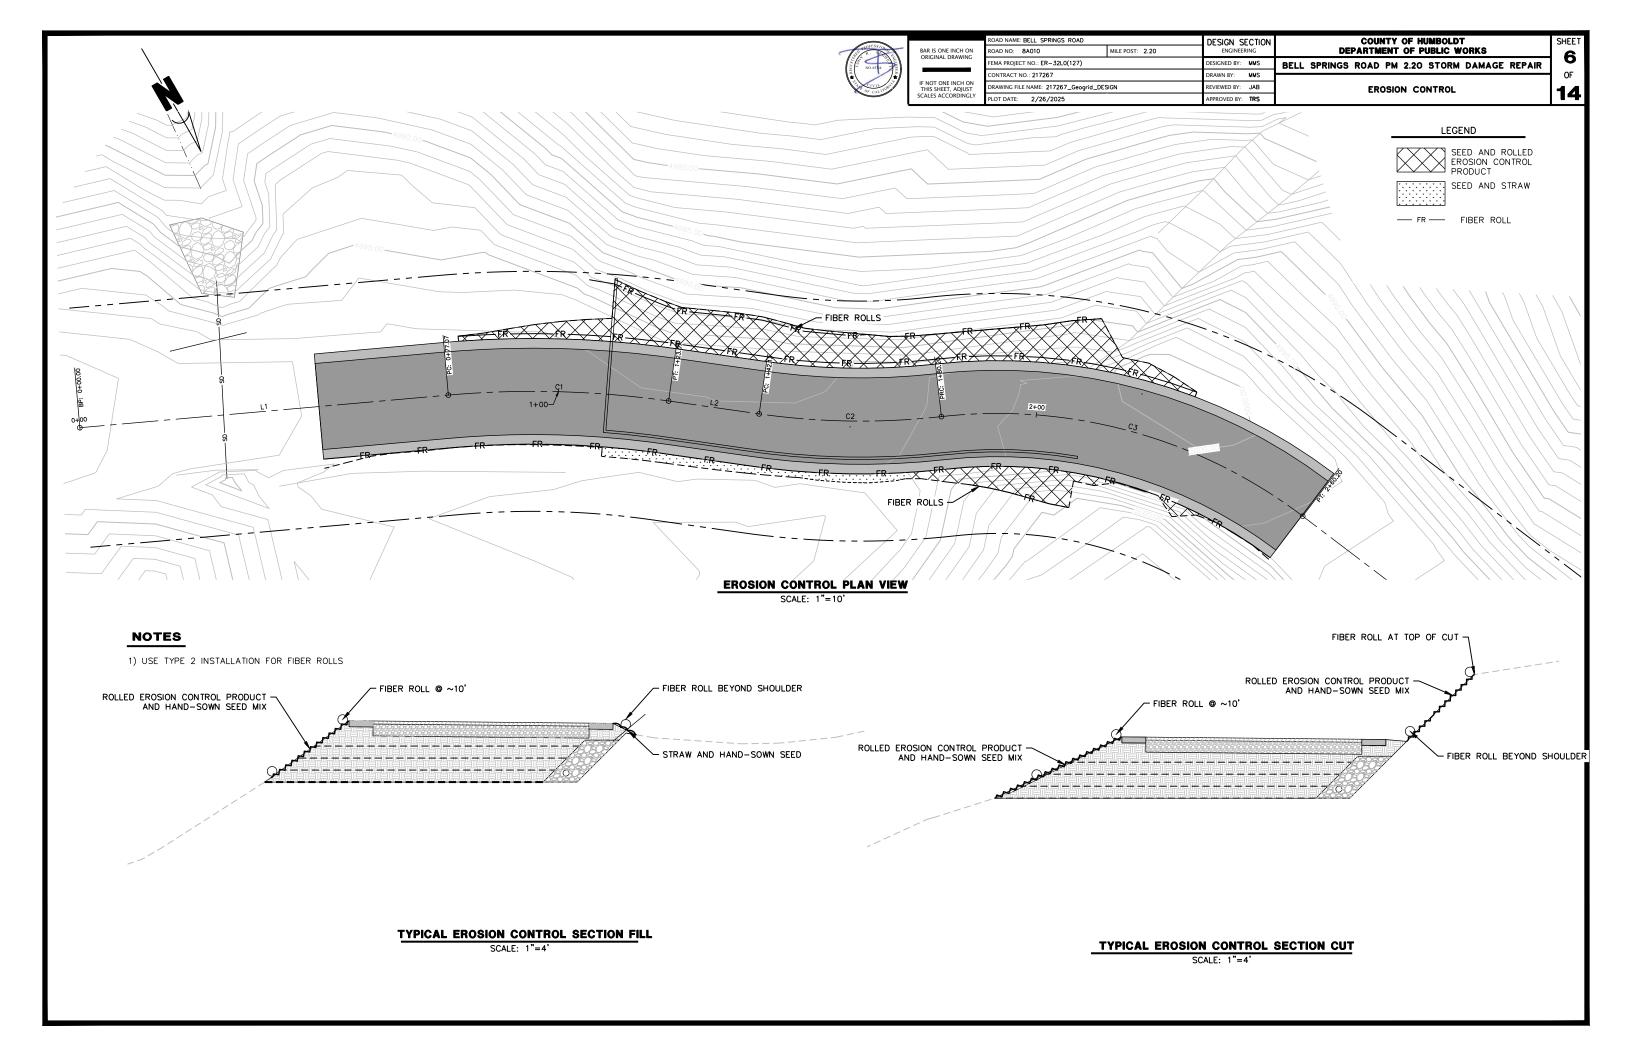

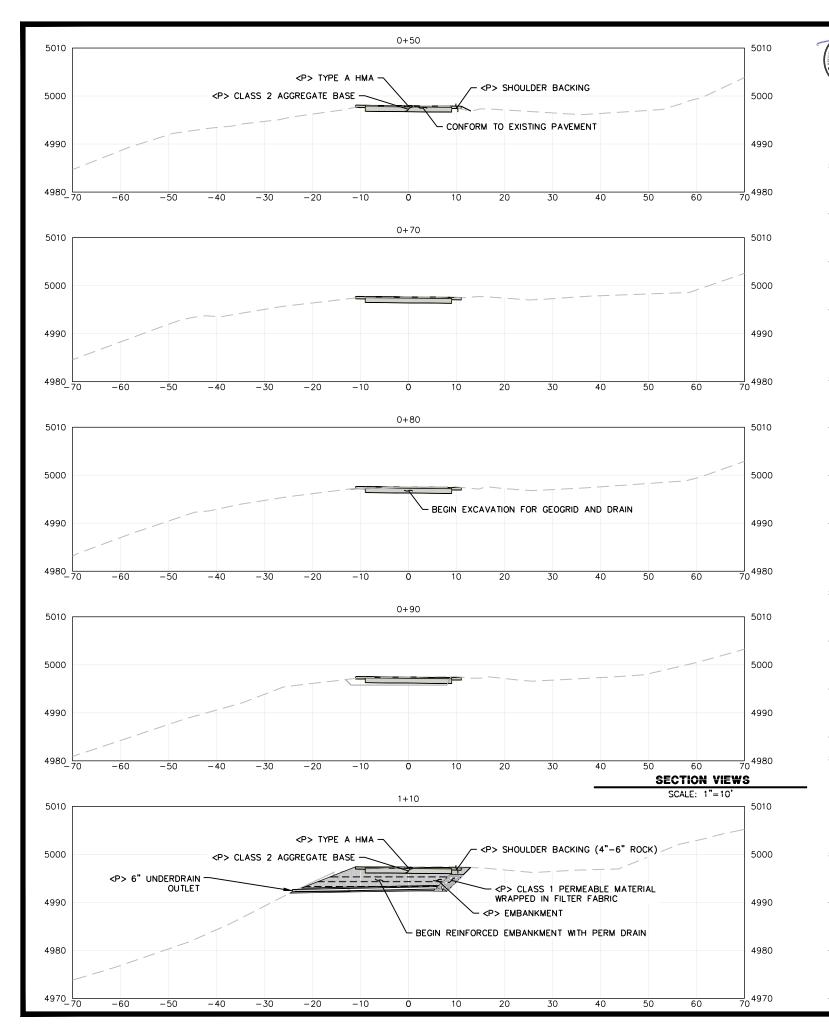


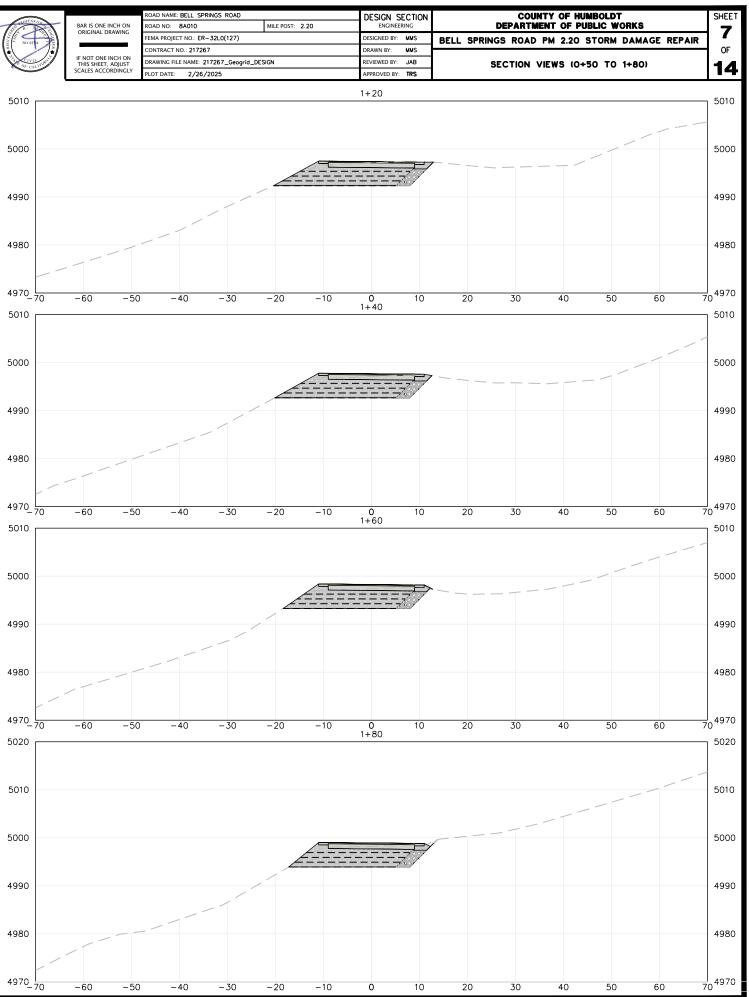


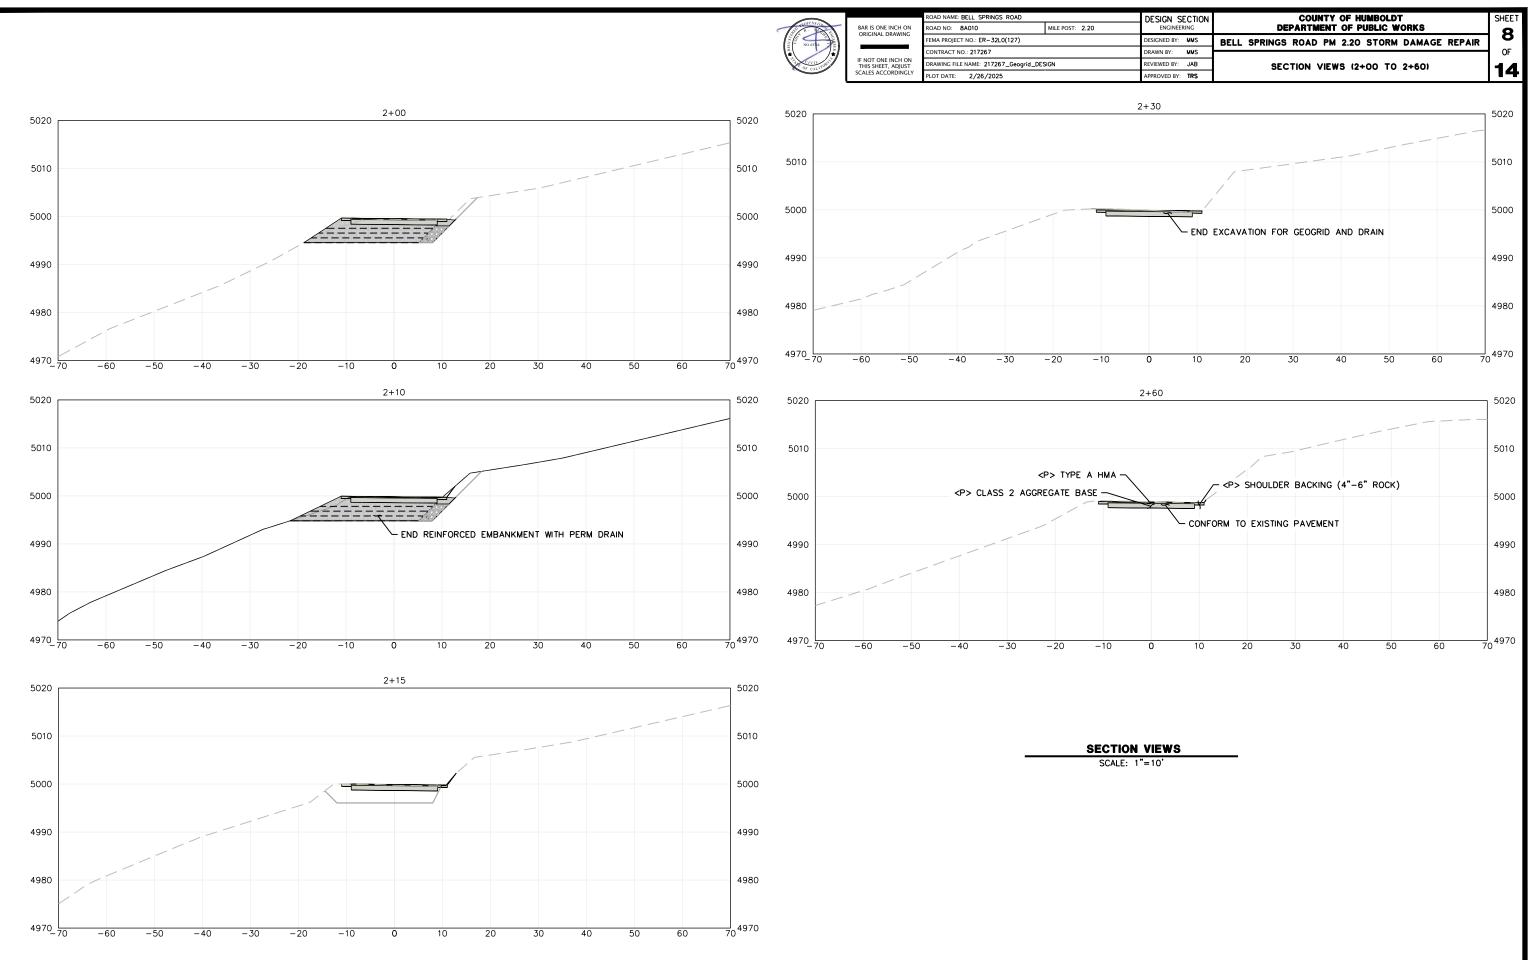


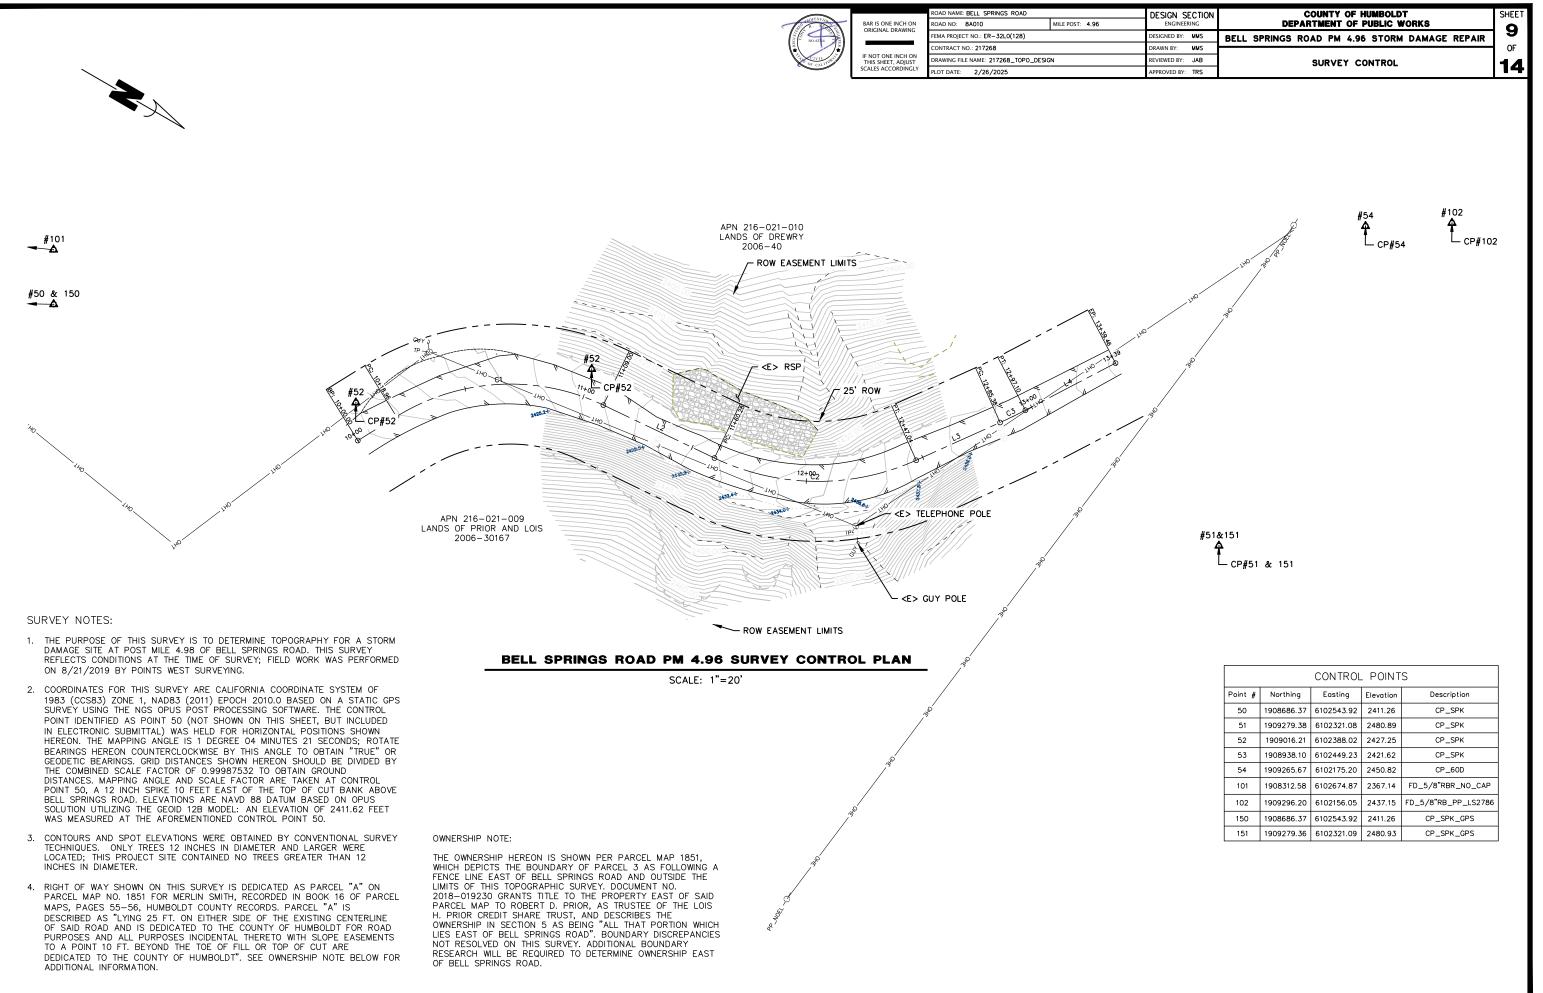


	CONTROL POINTS							
Point #	Northing	Easting	Elevation	Description				
50	1908686.37	6102543.92	2411.26	CP_SPK				
51	1909279.38	6102321.08	2480.89	CP_SPK				
52	1909016.21	6102388.02	2427.25	CP_SPK				
53	1908938.10	6102449.23	2421.62	CP_SPK				
54	1909265.67	6102175.20	2450.82	CP_60D				
101	1908312.58	6102674.87	2367.14	FD_5/8"RBR_NO_CAP				
102	1909296.20	6102156.05	2437.15	FD_5/8"RB_PP_LS2786				
150	1908686.37	6102543.92	2411.26	CP_SPK_GPS				
151	1909279.36	6102321.09	2480.93	CP_SPK_GPS				

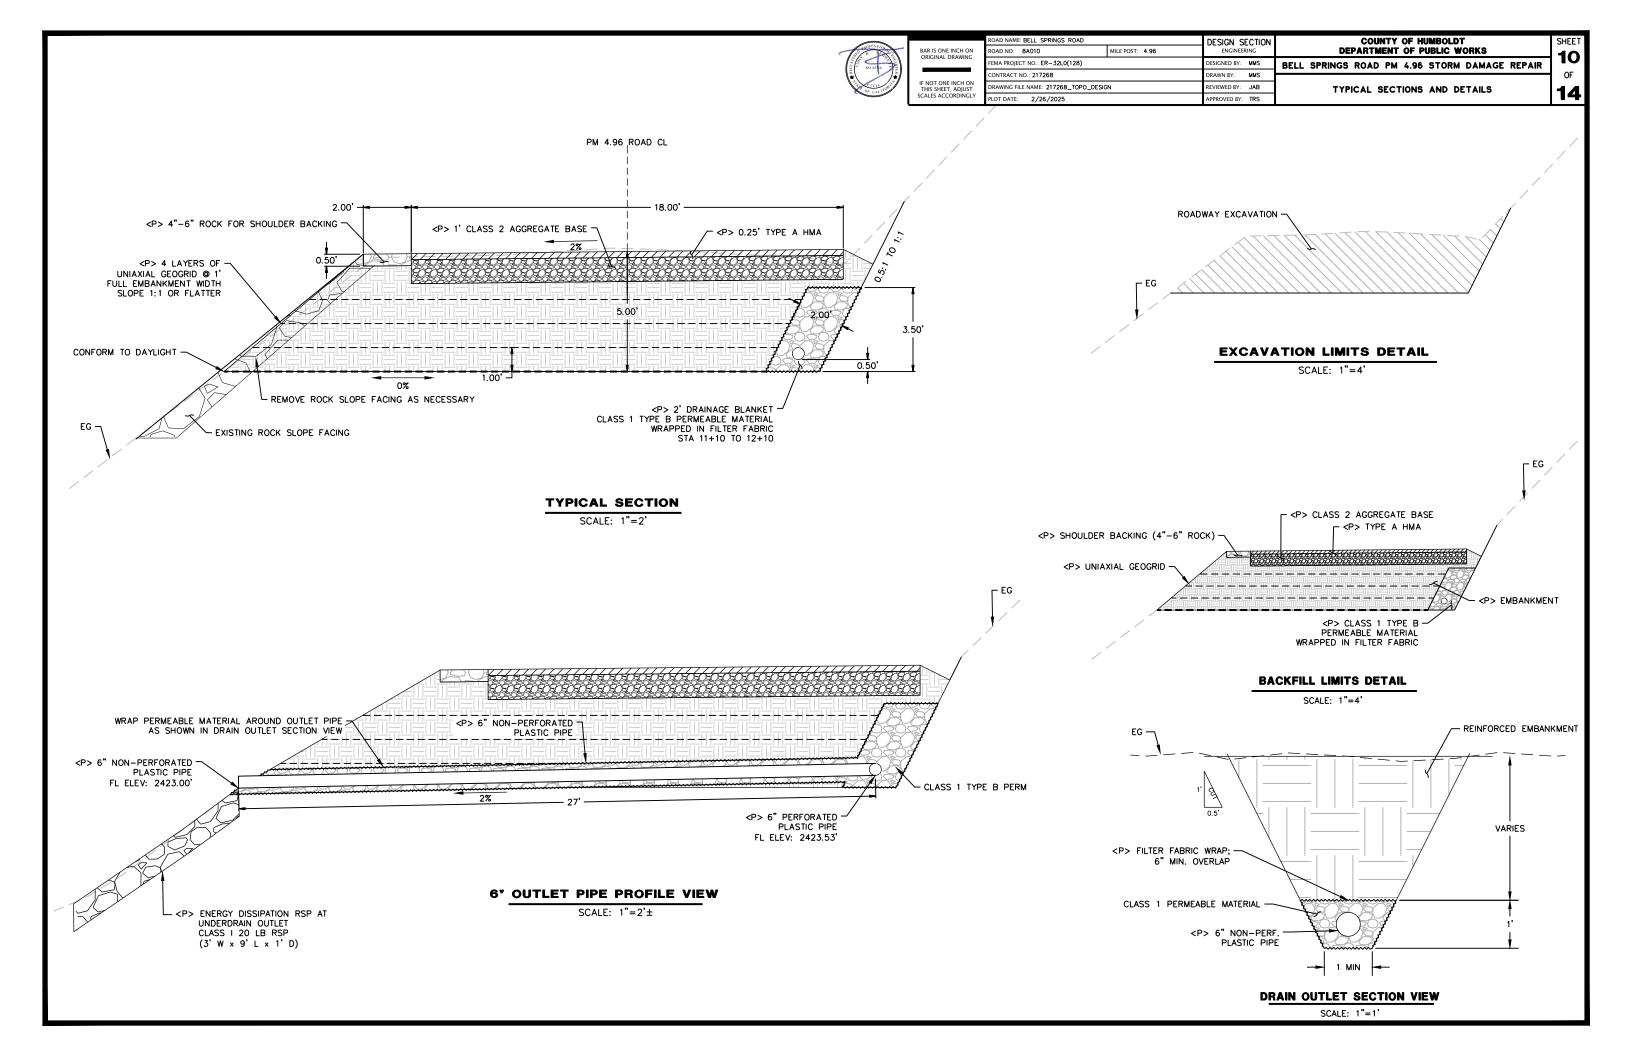

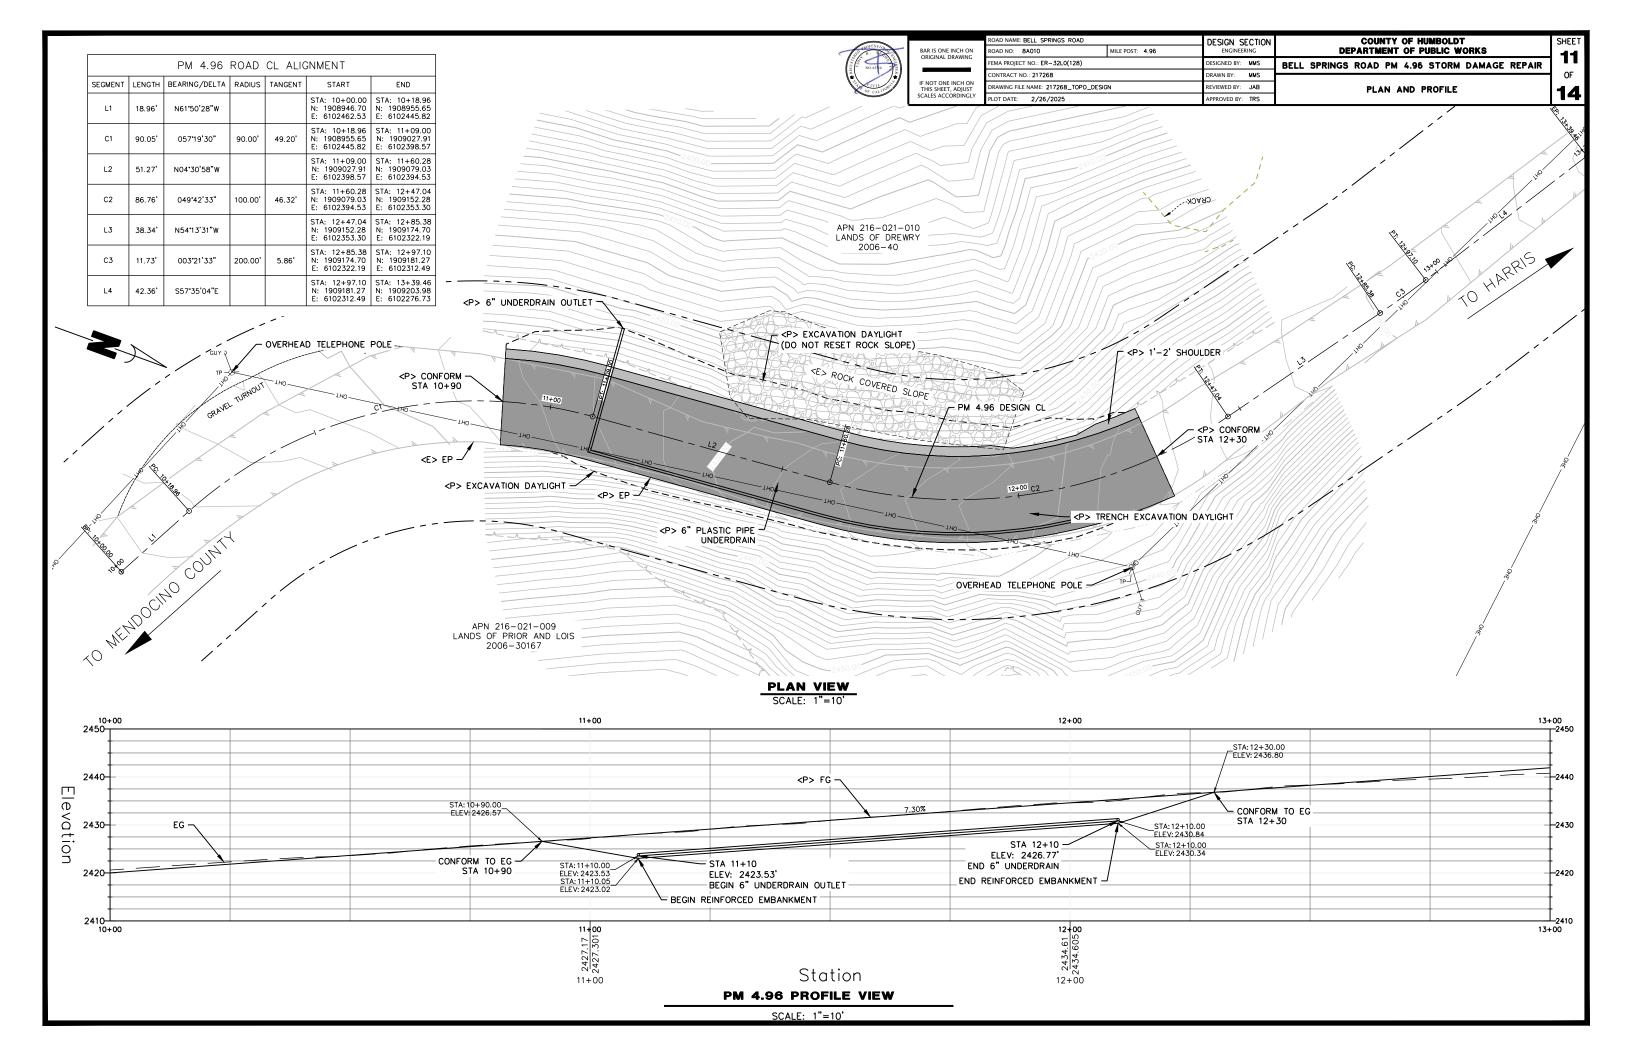


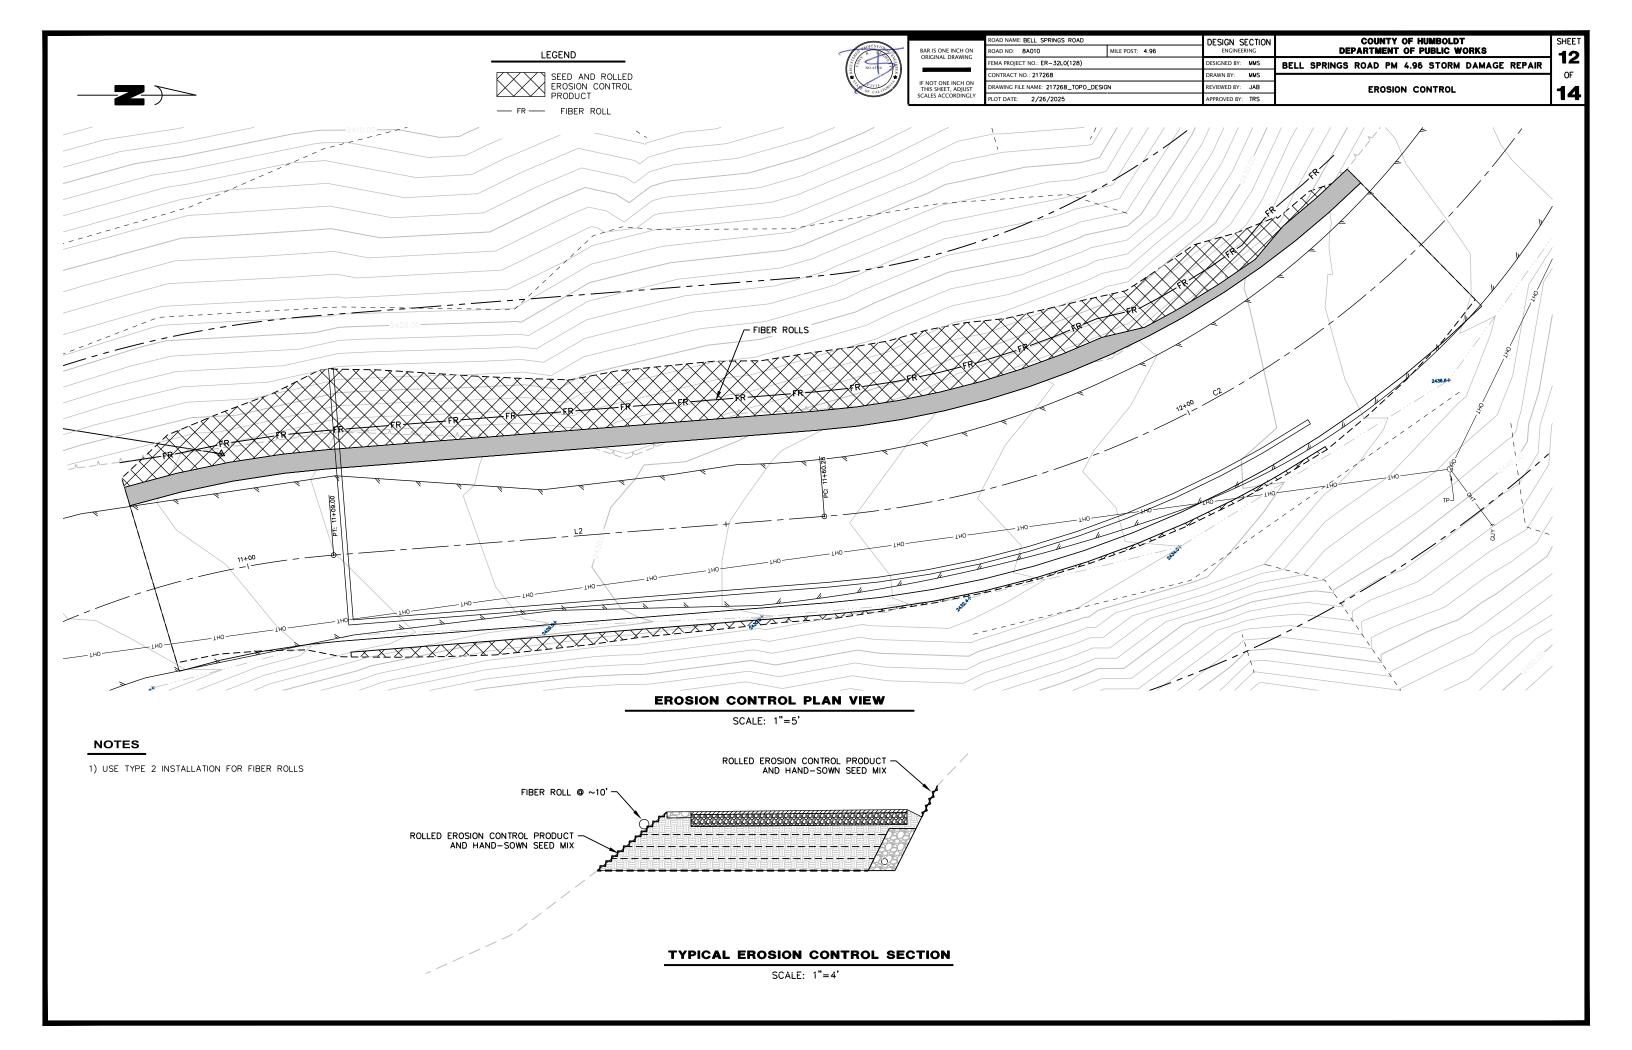

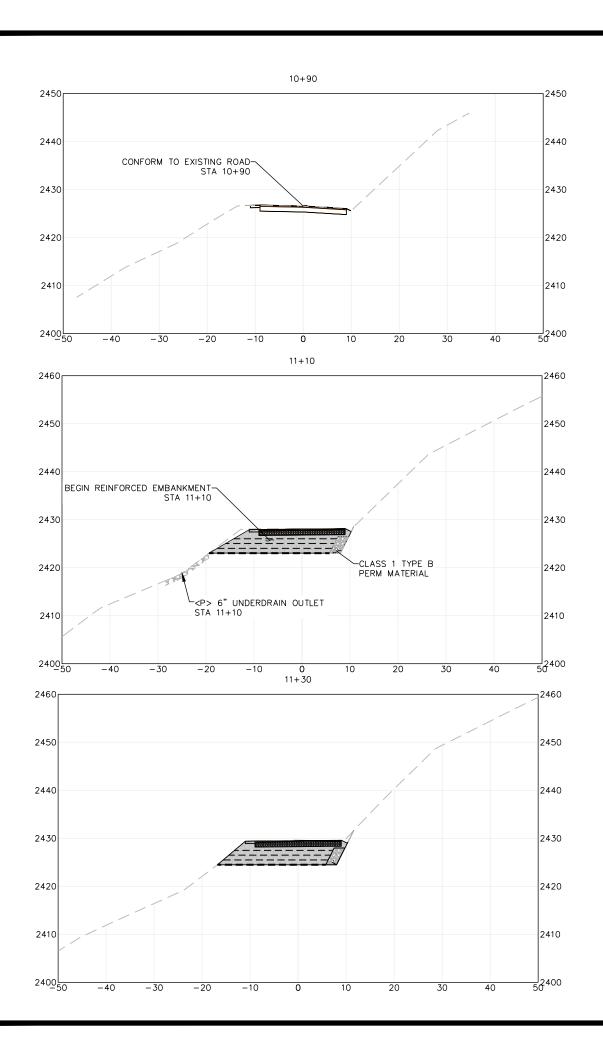


SECTION VIEWS


SCALE: 1"=10'

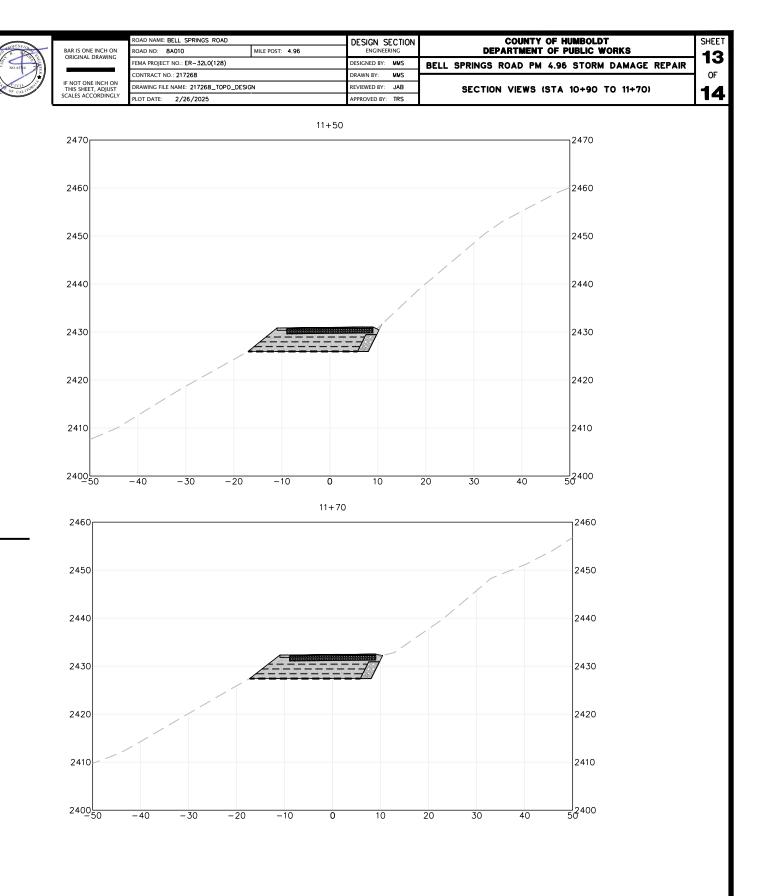




	ROAD NAME: BELL SPRINGS ROAD		DESIGN SECTION	COUNTY OF HUMBOLDT		
ONE INCH ON IAL DRAWING	ROAD NO: 8A010	MILE POST: 4.96	ENGINEERING	DEPARTMENT OF PUBLIC WORKS		
	FEMA PROJECT NO .: ER-32L0(128)		DESIGNED BY: MMS	BELL SPRINGS ROAD PM 4.96 STORM DAMAGE REPAIR	14	
ONE INCH ON HEET, ADJUST	CONTRACT NO.: 217268		DRAWN BY: MMS		OF	
	DRAWING FILE NAME: 217268_TOPO_DESIGN		REVIEWED BY: JAB	CROSS SECTIONS (11+90 TO 12+30)		
	PLOT DATE: 2/26/2025		APPROVED BY: TRS		14	

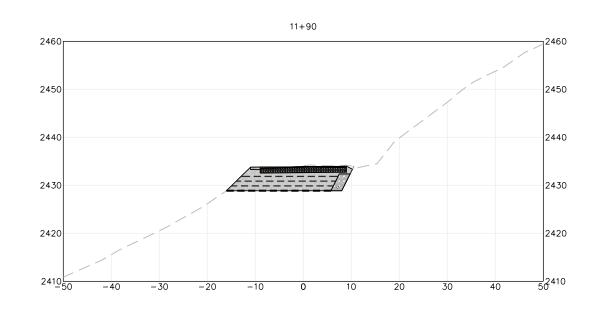

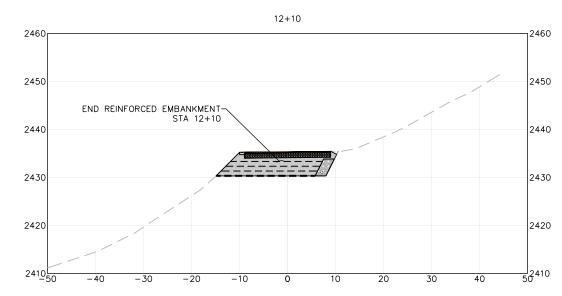

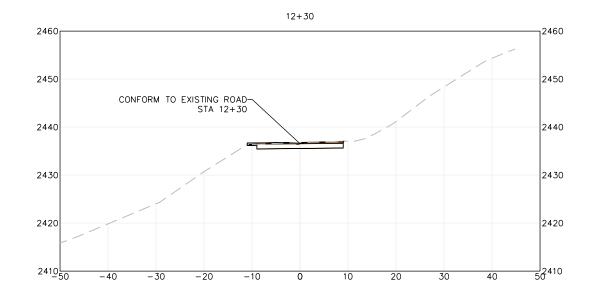



SCALE: 1"=10'